# **POWWOW GARDENS &**


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MAY 1 4 2010

# ART MARKET

Rapid City Growth Management Department

## CITY OF RAPID CITY PROJECT NO. RC09-1850/50793

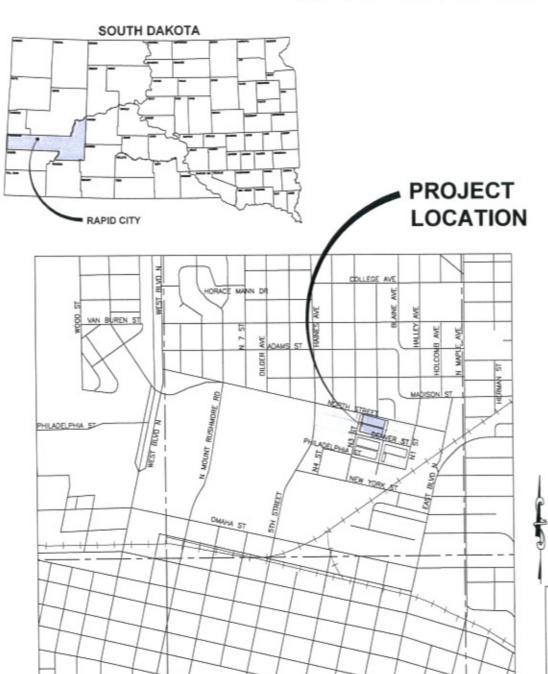

PROJECT LOCATION MAP

specifications have been prepared by me o under my direct supervision and that I am a duly



I hereby certify that these plans and specifications have been prepared by ma or under my direct supervision and that I am a duly registered Professional Engineer under the laws of South Dakota



specifications have been prepared by maid under my direct supervision and that I am a duly registered Professional Engineer under the laws of South Dakota.



specifications have been prepared by me or ofer my direct supervision and that I am a duly registered Architect under the laws of South Dekota.

SITE ELECTRICAL/

ARCHITECT:

LANDSCAPE ARCHITECT:

Associates, Inc.

Wyss

CIVIL ENGINEER:

STRUCTURAL ENGINEER:

Rapid City, South Dekota 57702

phone:605.343.9606 (ex:605.341.7395 Albertson Engineering Inc.

MECHANICAL ENGINEER:

CONSULTING ENGINEERS

3202 West Main Suite C



hereby nertily that these plans & a duly registered Professional Engineer under the laws of South Dekota.

I hereby certify that these plans & specifications have been prepared by me or under my direct supervision & that I am or under my direct supervision & that I am a duly registered Professional Engineer under the laws of South Dakota.

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CITY OF RAPID CITY GROWTH MANAGEMENT DEPT DEVELOPMENT SERVICES PROJECT MANUAL straper parties agreed to appear agreed to the parties of the part

ONE CALL BEFORE DIGGING 1-800-781-7474 POWWOW GARDENS
ART MARKET
CITY OF RAPID CITY PROJECT NO. RC09-

RC09-1850/50793

#### 10SR022 GENERAL NOTES:

ALL AREAS SHALL SLOPE TO DRAIN FREELY. NO PONDING OR STANDING WATER CONDITIONS SHALL OCCUR ANYWHERE WITHIN THE SCOPE OF THIS CONTRACT UNLESS SPECIFICALLY DESIGNED TO DO SO. CONTRACTOR SHALL INSTALL ADDITIONAL FIELD DRAINS OR DROP INLETS AS NEEDED TO ALLEVIATE ANY STANDING WATER CONDITIONS.

- TOP SURFACES OF FURNITURE (BENCHES, TABLES, RECEPTACLES, ETC. SHALL BE LEVEL, EXCEPT AS RECOMMENDED BY THE MANUFACTURER. COORDINATE FOOTING DEPTH AND LOCATIONS TO ACCOUNT FOR THIS, WITHOUT IMPEDING SURFACE FLOW
- SOIL SURFACES SHALL SLOPE TO DRAIN AT A MINIMUM OF 2% AND SHALL BE NO STEEPER THAN 2.1. LAWN SLOPES SHALL NOT EXCEED 3.5.1.
  SOIL FINISH GRADES SHALL BE 6" BELOW FINISH FLOOR ELEVATIONS UNLESS DETAILED OTHERWISE, AND 2" BELOW FINISH SURFACES OF ADJACENT PAVEMENTS TO ACCOMMODATE MULCH LAYER AT PLANTING BEDS.
  ALL NOTES, CONDITIONS AND SPECIFICATIONS OF THE CIVIL ENGINEER'S LITHLITY PLANS ARE APPLICABLE.

- ALL WORK SHALL BE PERFORMED IN COMPLIANCE WITH APPLICABLE CODES. NOTHING IN THESE PLANS SHALL IMPLY OR ALLOW FOR DEVIATION FROM CODE.
- ALL INSTALLATIONS, UTILITY WORK SHALL BE PERFORMED BY CONTRACTORS HOLDING APPROPRIATE LICENSES.
- EQUIPMENT, UTILITIES, OR OTHER ITEMS NOT IDENTIFIED ON THESE DRAWINGS SHALL REMAIN UNDISTURBED IF POSSIBLE. ANY ADDITIONAL EQUIPMENT OR UTILITIES ENCOUNTERED WITHIN THE LIMITS OF WORK SHALL BE BROUGHT TO THE ATTENTION OF THE OWNER'S REPRESENTATIVE PRIOR TO CONTINUING WORK IN THAT AREA.

  CONTRACTORS SHALL BE RESPONSIBLE FOR KNOWING THE LOCATIONS OF ALL UTILITIES, EQUIPMENT, AND CONDUITS WITHIN THE PROJECT AREA.

- CONTACT SOUTH DAKOTA ONE CALL NOTIFICATION CENTER 1-800-781-7474 AS NEEDED TO MAINTAIN CLEARLY MARKED LOCATIONS OF ALL UTILITIES WITHIN THE PROJECT AREA.
- DAMAGES TO EXISTING UTILITIES, EQUIPMENT, IRRIGATION EQUIPMENT AND OTHER PROPERTY SHALL BE RECTIFIED TO THE SATISFACTION OF THE OWNER'S REPRESENTATIVE
- ALL PIPE AND CONDUIT ROUTES, LOCATIONS AND TRENCH SECTIONS SHALL BE APPROVED BY THE OWNER'S REPRESENTATIVE PRIOR TO COVERING. SCHEDULE INSPECTIONS 48 HOURS IN ADVANCE OF BACKFILLING.
- RESTOREMAINTAIN ALL EXISTING DRAINAGE PATTERNS TO EXISTING STRUCTURES, ETC. AS APPROPRIATE.

- LAYOUT NOTES:
  1. DIMENSIONS ARE GIVEN FROM FACES OF CURBS WALLS AND BUILDINGS, BACK OF SIDEWALKS, CENTERLINES OF MOWSTRIPS & HEADERBOARDS, AND EDGES OF FURNITURE.
- WRITTEN DIMENSIONS SHALL TAKE PRECEDENCE OVER SCALED DIMENSIONS IN ALL CASES.
- EXISTING CONDITIONS AND DIMENSIONS SHALL BE FIELD VERIFIED BY CONTRACTOR. IN THE EVENT OF A DISCREPANCY, THE PROJECT LANDSCAPE ARCHITECT SHALL BE NOTIFIED PRIOR TO CONTINUING WORK
- CONTRACTOR SHALL BE RESPONSIBLE FOR KNOWING LOCATIONS OF ALL UNDERGROUND AND ABOVE GROUND UTILITIES, STRUCTURES, ETC.
- DAMAGE TO EXISTING MATERIALS, EQUIPMENT, OR STRUCTURES SHALL BE REPAIRED OR REPLACED, TO THE SATISFACTION OF THE OWNER, AT CONTRACTOR'S EXPENSE.

  LAYOUT SHALL BE STAKED IN THE FIELD FOR REVIEW AND APPROVAL BY THE PROJECT LANDSCAPE ARCHITECT. SCHEDULE FIELD INSPECTION WITH LANDSCAPE ARCHITECT AT LEAST 24 HOURS IN ADVANCE.
- REFER TO ENGINEERING GRADING PLANS FOR FINISH GRADES AND ELEVATIONS OF ALL PAVEMENTS AND STRUCTURES NOT PROVIDED IN THESE DRAWINGS.
- CONTRACTOR SHALL BE RESPONSIBLE FOR COORDINATING INSTALLATIONS AND SCHEDULING WITH OTHER TRADES
- ALL MATERIALS, EQUIPMENT, AND INSTALLATIONS SHALL BE AS SHOWN THIS DRAWING SET, OR AS DESCRIBED IN THE SPECIFICATIONS.

- THIS SYSTEM IS DESIGNED TO OPERATE WITH A MINIMUM STATIC WATER PRESSURE OF 75 PSI AT THE POINT OF CONNECTION. THE CONTRACTOR SHALL VERIFY THE STATIC WATER PRESSURE PRIOR TO COMMENCING WORK. IF THERE IS GREATER THAN 80 PSI @ POINT OF CONNECTION CONTRACTOR SHALL INSTALL A PRESSURE REGULATING VALVE AND SET PRESSURE TO 75 PSI AFTER THE BACKFLOW PREVENTER. CONFIRM ALL ADDITIONAL APPURTENANCES WITH OWNER & SUBMIT TO LANDSCAPE ARCHITECT FOR APPROVAL
- IRRIGATION CONTROLLER SHALL BE LOCATED IN MAINTENANCE ROOM OF RESTROOM BUILDING. COORDINATE TRENCHING AND SLEEVING WITH GENERAL CONTRACTOR.
- EACH CONTROLLER SHALL HAVE IT'S OWN COMMON WIRE. THERE IS ONE (1) CONTROLLER FOR THIS JOB.

  CONTROLLER SHALL RUN 2 ADDITIONAL CONTROL WIRES FOR EACH CONTROLLER ALONG THE ENTIRE SYSTEM AND LOOP THE WIRES BACK TO EACH CONTROLLER. THESE WIRES WILL BE SPARES
- VALVE STATION ID NUMBERS ON PLAN DESIGNATE THE FOLLOWING: S = SHRUB SPRAY ZONES, L = LAWN ZONES, D = DRIP ZONES R\* ROTORS.
- PROGRAM CONTROLLER TO IRRIGATE ZONES IN NUMERIC ORDER SHOWN ON PLAN TO ALLOW INFLITRATION OF APPLIED WATER, AND REDUCE RUNOFF, SEQUENCE AS FOLLOWS: (R-X), (L 1-X), (S 1-X), (D 1-X) MAINLINE AND LATERAL LINE LOCATIONS ARE DIAGRAMMATIC. CONTRACTOR SHALL KEEP LINES OUT OF PAVED AREAS WHERE POSSIBLE. COMMON TRENCH IF POSSIBLE.

  VALVE LOCATIONS ARE DIAGRAMMATIC, CONTRACTOR SHALL LOCATE BOXES IN PLANTING BEDS, NOT IN LAWNS WHERE POSSIBLE. APPROXIMATELY 12'-18' FROM PAVEMENTS, WALKS, ETC. (GANG VALVES WHERE
- POSSIBLE).
- SOLENOID VALVE ADJUSTMENT: CLOSE FLOW CONTROL UNTIL SPRINKLER RADIUS IS AFFECTED THEN OPEN 1/2 TURN FOR OPTIMUM DIAPHRAGM LIFE
- PIPE SIZES NOTED ON PLAN.
- COORDINATE PIPE SLEEVING, WIRE-PULLS AND PAVEMENT CROSS-OVERS WITH GENERAL CONTRACTOR PRIOR TO ROUGH GRADING. CONTRACTOR SHALL STUB UP AND CAP SLEEVES 12'-18' INSIDE PLANTERS INSTALL SCH 40 SLEEVE UNDER ALL PAVED SURFACES FOR BOTH MAINLINE & LATERALS. MINIMUM SLEEVE SIZE TO BE TWICE DIAMETER OF THE LINE.
- ADJUST RADIUS OF ALL SPRINKLERS TO MINIMIZE OVERTHROW.
- CONTRACTOR SHALL INSTALL RAINBIRD 1800 PCS (PRESSURE COMPENSATING SCREENS) AS NEEDED TO REDUCE RADII OF SPRAY PATTERNS, AND TO ELIMINATE OVERSPRAY. REFER TO MANUFACTURER'S CATALOG CHART WHEN SELECTING APPROPRIATE SCREENS.
- LOCATE HEADS 4" FROM ADJACENT CURB AND PAVED SURFACES, AND 12" FROM ADJACENT BUILDINGS AND STRUCTURES EXCEPT WHERE NOTED. ALL PIPE AND EQUIPMENT ( EXCEPT COPPER PIPE, CONTROLLERS, WIRE SLEEVES AND PIPES SHOWN IN SLEEVES, SHALL BE INSTALLED IN PLANTER AREAS, EXCEPT WHERE NECESSARY. SOME SHOWN IN PAVED AREAS ON PLAN FOR GRAPHIC CLARITY.
- ALL EQUIPMENT SHALL BE SUPPLIED AND INSTALLED AS DESCRIBED IN THE SPECIFICATIONS, OR AS SHOWN IN THE DETAILS.
- 16 CONTRACTOR SHALL USE FIELD LOCATOR SERVICE TO VERIFY LOCATION OF ALL UNDERGROUND UTILITIES CONTRACTOR SHALL HAND TRENCH AROUND UNDERGROUND UTILITIES AS REQUIRED BY LOCAL AUTHORITIES 17. EXISTING TREES TO REMAIN SHALL BE PROTECTED DURING CONSTRUCTION TRENCHING BENEATH THE THE DRIPLINE OF EXISTING TREES SHALL BE AVOIDED AND SHALL BE PERFORMED MANUALLY WHEN NECESSARY.

  18. CONTRACTOR SHALL REPAIR DAMAGE DONE TO SITE ELEMENTS DUE TO CONTRACTORS WORK AT NO ADDITIONAL EXPENSE TO THE OWNER. CONTRACTOR SHALL THOROUGHLY DOCUMENT EXISTING CONDITION OF SITE PRIOR TO COMMENCING WORK AND SUBMIT TO THE OWNER COPIES OF DOCUMENTATION

- CONTRACTOR SHALL LOCATE AND PROTECT ALL EXISTING UTILITIES. CONTRACTOR SHALL REPAIR OR REPLACE ANY DAMAGED UTILITIES AT NO COST TO OWNER.
  ALL PLANT MATERIAL SHALL CONFORM TO THE GUIDELINES ESTABLISHED BY THE CURRENT AMERICAN STANDARD FOR NURSERY STOCK. PUBLISHED BY THE AMERICAN ASSOCIATION OF NURSERYMEN OR EQUIVALENT.
  ALL TREE AND SHRUB LOCATIONS SHALL BE STAKED BY CONTRACTOR AND APPROVED BY PROJECT LANDSCAPE ARCHITECT.
- ALL PLANTS SHALL BEAR THE SAME RELATION SHIP TO FINISHED GRADE AS THE PLANT'S ORIGINAL GRADE BEFORE DIGGING
- ALL PLANTS AND STAKES SHALL BE SET PLUMB UNLESS OTHERWISE SPECIFIED ALL PLANTS SHALL BE INSTALLED IN ACCORDANCE WITH ALL DRAWINGS AND SPECIFICATIONS.
- ALL PLANTING BEDS AREAS ARE TO RECEIVE SHREDDED WOOD MULCH, OR APPROVED EQUAL, MULCH SHALL BE PROVIDED AND DELIVERED BY THE CITY OF RAPID CITY. CONTACT THE CITY PROJECT MANAGER AT 48 HOURS IN ADVANCE OF DELIVERY
- MULCH TO A 2' MINIMUM DEPTH. PERENNIAL AREAS SHALL RECEIVE A 2' MIN. DEPTH. TREES IN LAWN ARE TO RECEIVE A 4-0' DIA. MULCH RING WITH A MINIMUM DEPTH OF 2'. DO NOT MULCH SEEDED GRASS AREAS HYDROSEEDING SHALL TAKE PLACE DURING THE RAINY SEASON AND AFTER SOIL TEMP. EXCEEDS 40 DEGREES FROM APPROX. MAY 15 TO JUNE 30
- LANDSCAPE PLANTING SHALL TAKE PLACE FROM APRIL 15 TO JUNE 15 OR FROM SEPTEMBER 1 TO NOVEMBER 1, UNLESS OTHERWISE INDICATED
- CONTRACTOR IS RESPONSIBLE FOR MAINTAINING HEALTH OF ALL PLANT MATERIAL INCLUDING TREES, SHRUBS, PERENNIALS, TURF GRASSES, AND NATIVE GRASSES UNTIL FINAL ACCEPTANCE OF PROJECT
- ALL PLANTS SHALL BE SPRAYED WITH AN ANTIDESSICANT WITHIN 24 HOURS OF PLANTING. AND AT THE BEGINNING OF THEIR FIRST WINTER. THE CONTRACTOR SHALL REFER TO THE CONTRACT SPECIFICATIONS AND PLANTING DETAILS FOR ADDITIONAL REQUIREMENTS. THE CONTRACTOR SHALL PROVIDE A ONE (1) YEAR WARRANTY FOR ALL PLANT MATERIAL UNLESS OTHERWISE INDICATED IN SPECIFICATIONS.
- ALL PLANT MATERIAL TO BE FREE OF PESTS, DISEASE AND BREAKAGE SEE SPECIFICATIONS.


- 16. OWNER, OR OWNER'S REPRESENTATIVE TO INSPECT PLANT MATERIAL BEFORE PLANTING SEE SPECIFICATIONS.

  17. CONTRACTOR TO REMOVE AND DISPOSE OF ALL METAL WIRE BASKETS, FROM ROOTBALL, BEFORE PLANTING.

  18. THE CONTRACTOR IS RESPONSIBLE FOR INSTALLING GRASS SEED MIX PER PLAN AND ON ALL MISCELLANEOUS DISTURBED AREAS NOT DESIGNATED PLANTING BEDS OR SEED AREAS. SEED TO BE INSTALLED AND MAINTAINED PER NOTES AND SPECIFICATIONS. MIX FOR MISCELLANEOUS AREAS SHALL BE "RECLAMATION GRASS MIX". PREPARE SOIL AS DESCRIBED ON SOIL CONDITIONING PLAN PRIOR TO BEGINNING PLANT INSTALLATION. COMPOST TO BE PROVIDED AND DELIVERED BY THE CITY DEPARTMENT OF PARKS AND RECREATION. CONTACT THE CITY PROJECT MANAGER AT 48 HOURS IN ADVANCE OF DELIVERY.

  19. PLANT QUANTITIES ARE SUPPLIED ON PLANS FOR THE CONVENIENCE OF THE CONTRACTOR, IN THE CASE OF A DISCREPANCY, PLANS) SHALL GOVERN.

- CONTRACTOR IS REQUIRED TO OBTAIN FROM CITY OF RAPID CITY PRIOR TO START OF CONSTRUCTION:
- a BUILDING PERMIT
- b. AIR QUALITY PERMIT
- c. A PERMIT TO WORK IN RIGHT OF WAY
- d. EROSION AND SEDIMENT CONTROL PERMIT
- 2. CONTRACTOR IS REQUIRED TO OBTAIN FROM STATE OF SOUTH DAKOTA (DENR) PRIOR TO START OF CONSTRUCTION
- a. STATE WATER POLLUTION PREVENTION PLAN (SWPPP) PERMIT

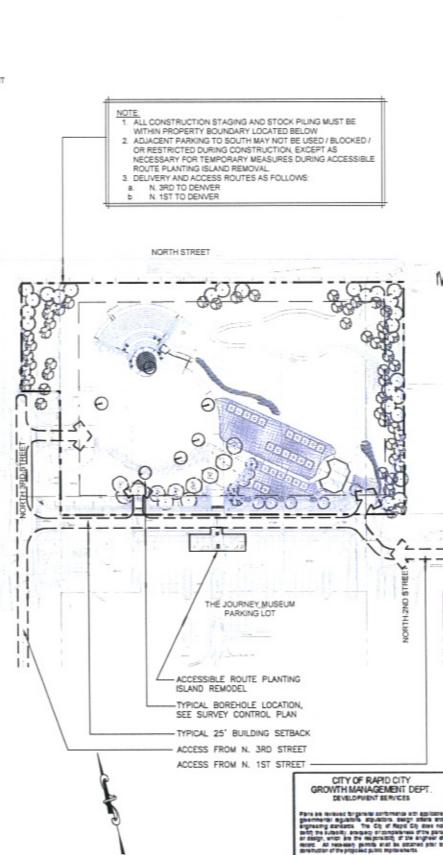

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Associates,

Designed By: Drawn by: MDF / PHW CMW / AKW

AUG, 2009

Design Date: FEB, 2010

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FMG. Inc.

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GARDEN


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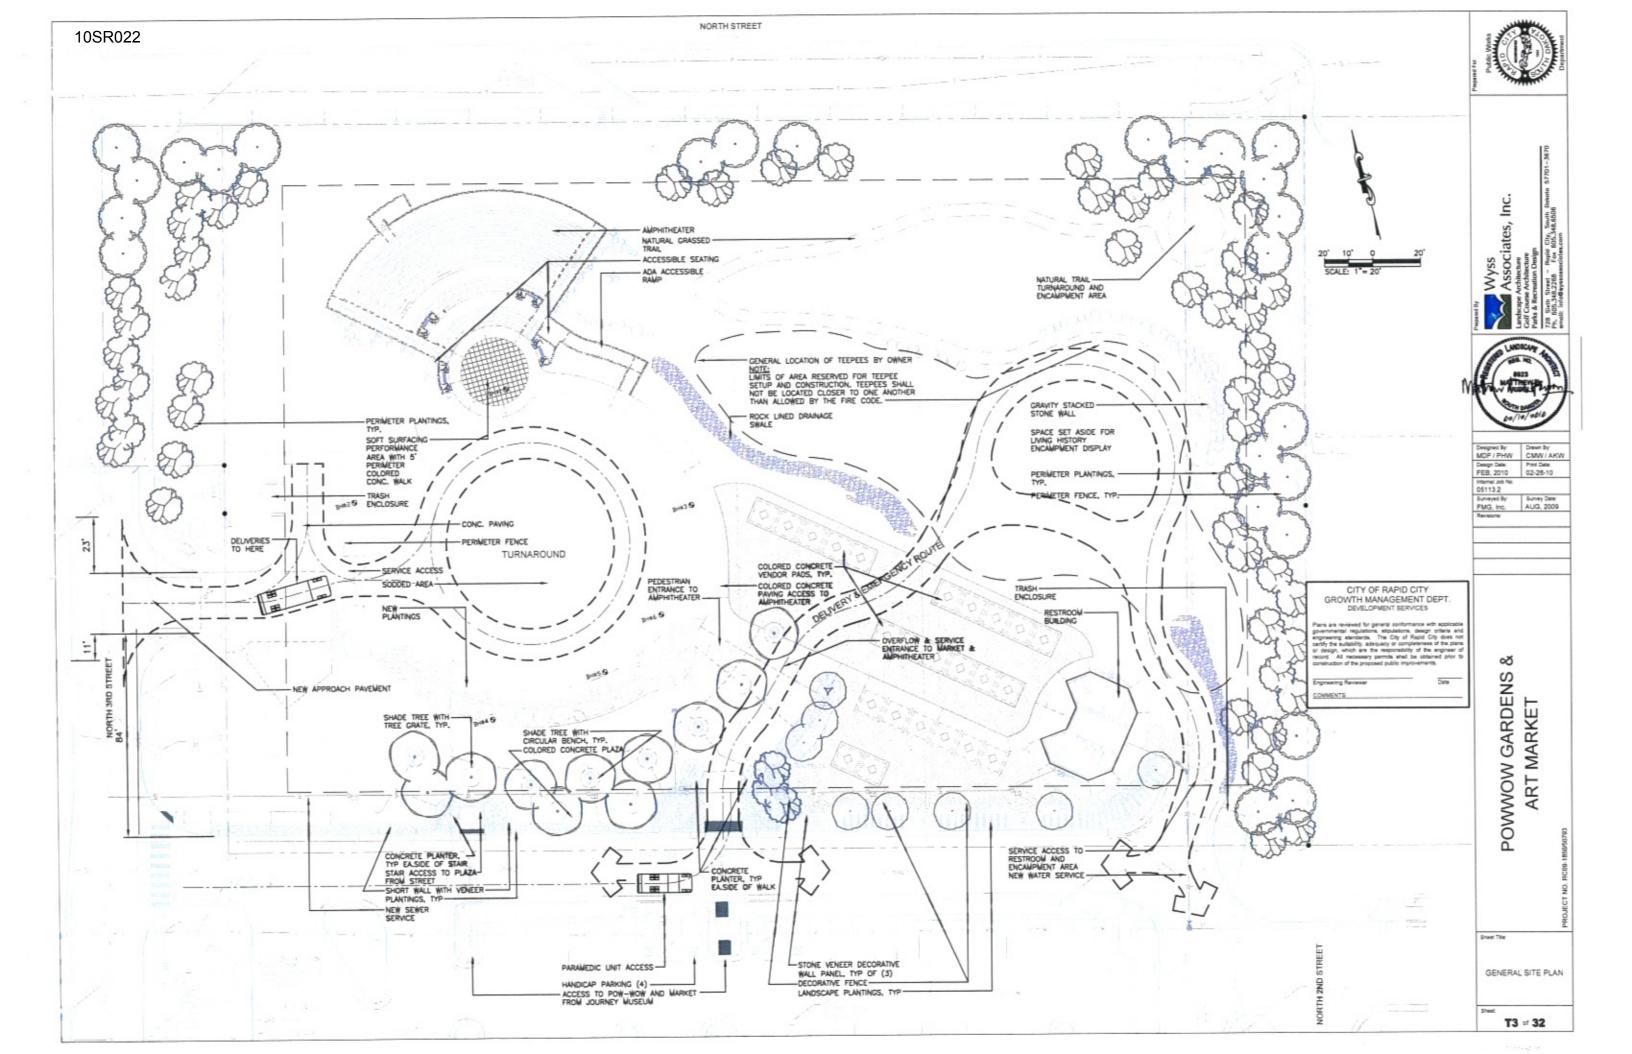
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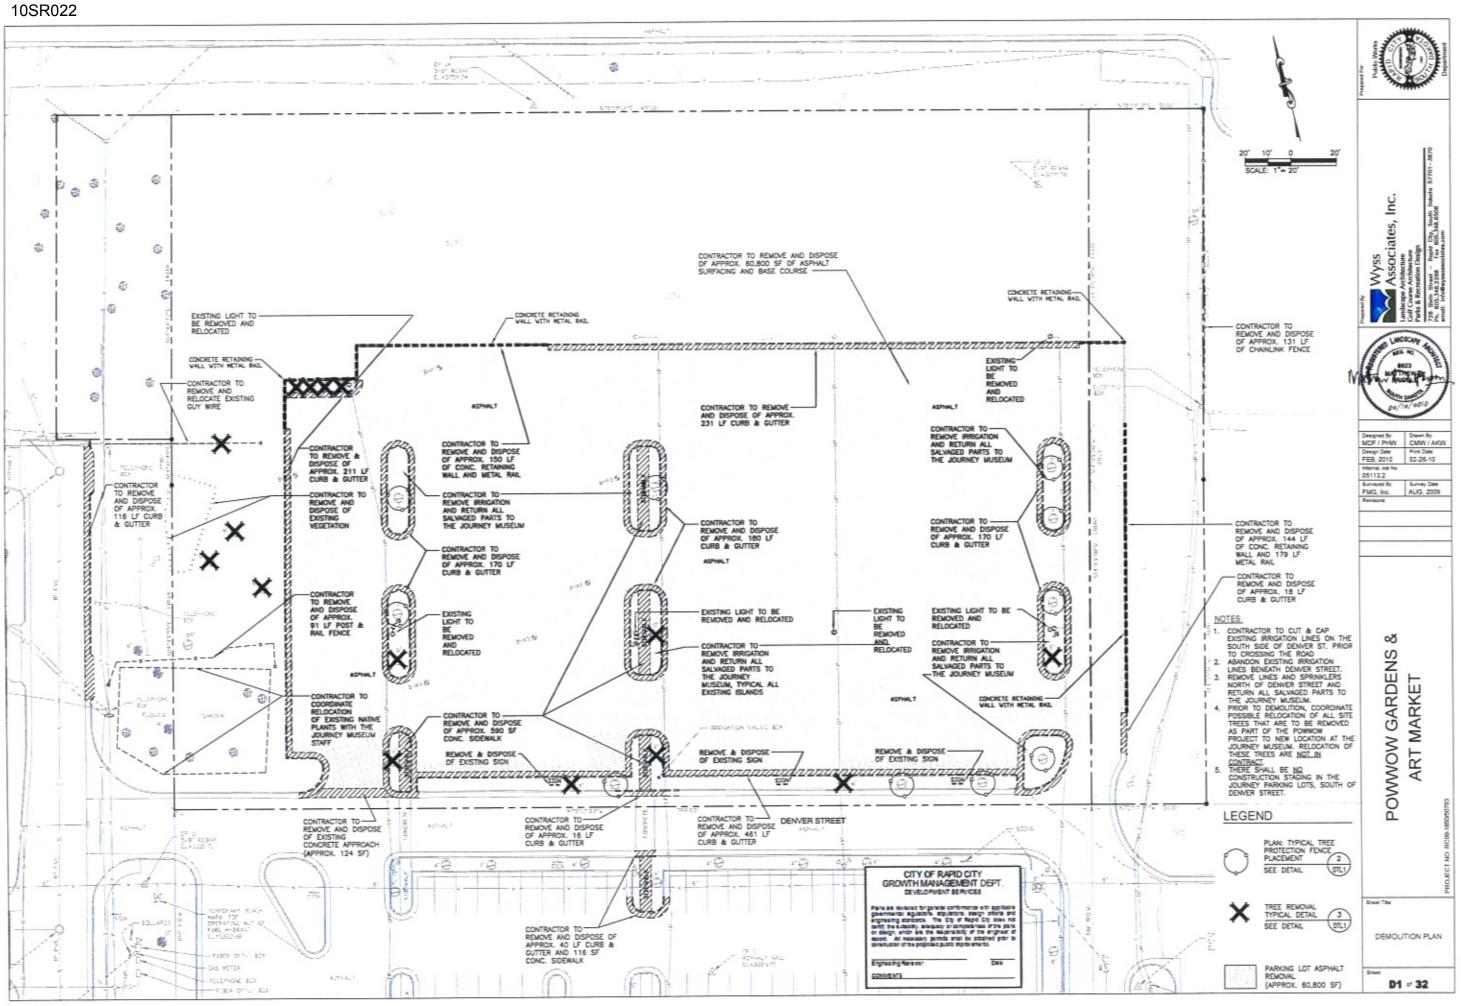
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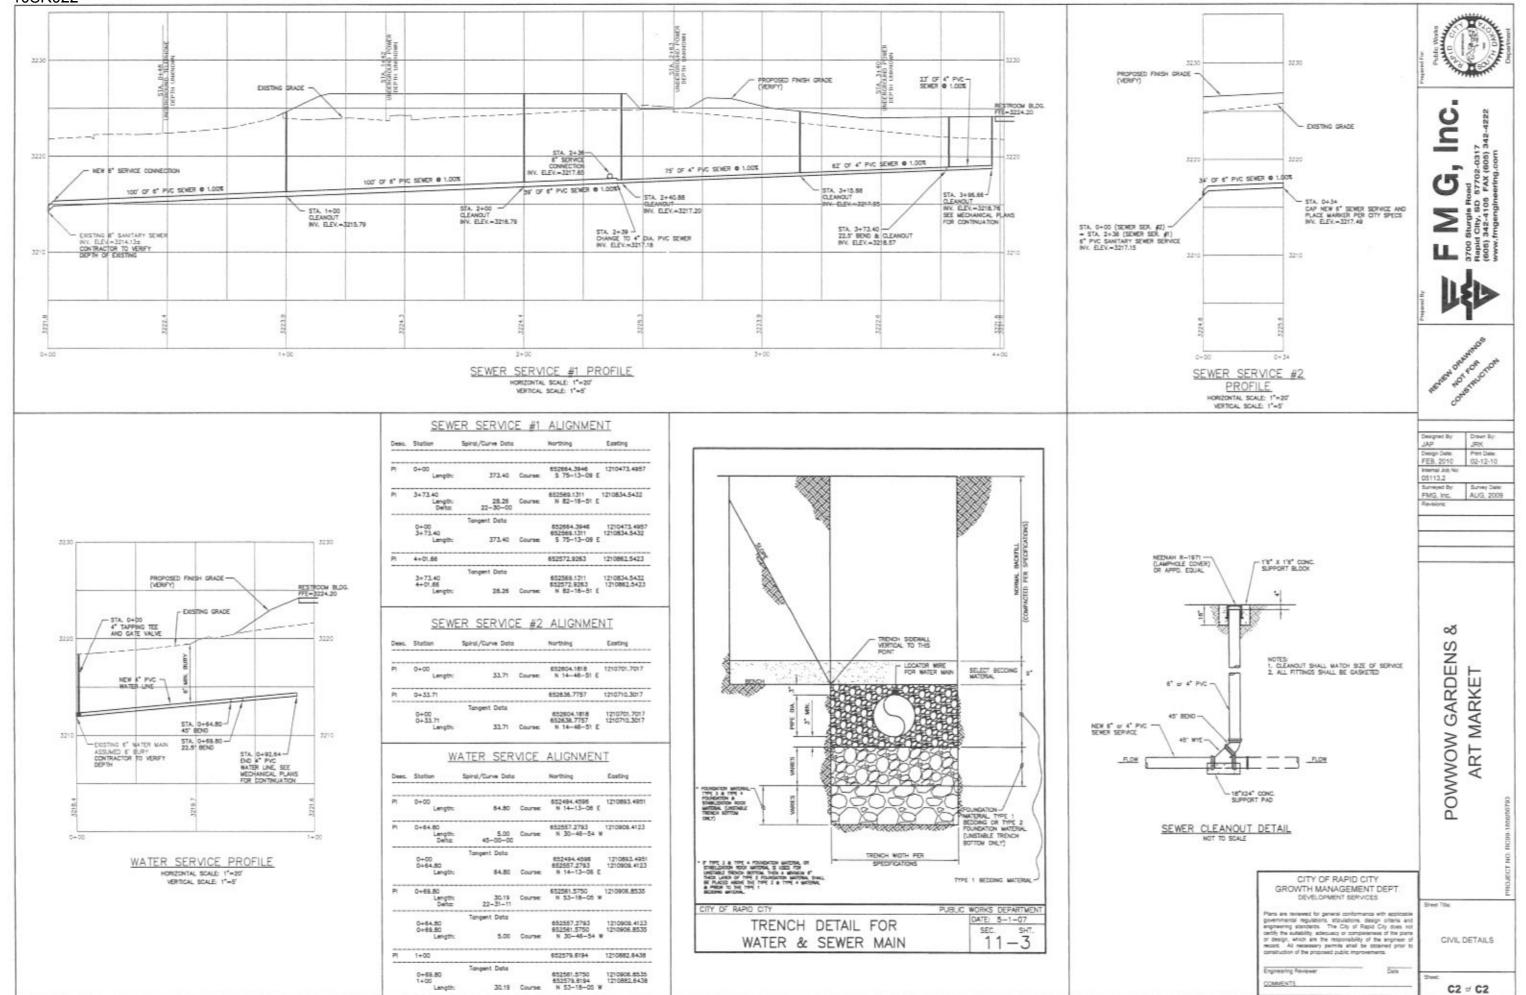
GENERAL NOTES


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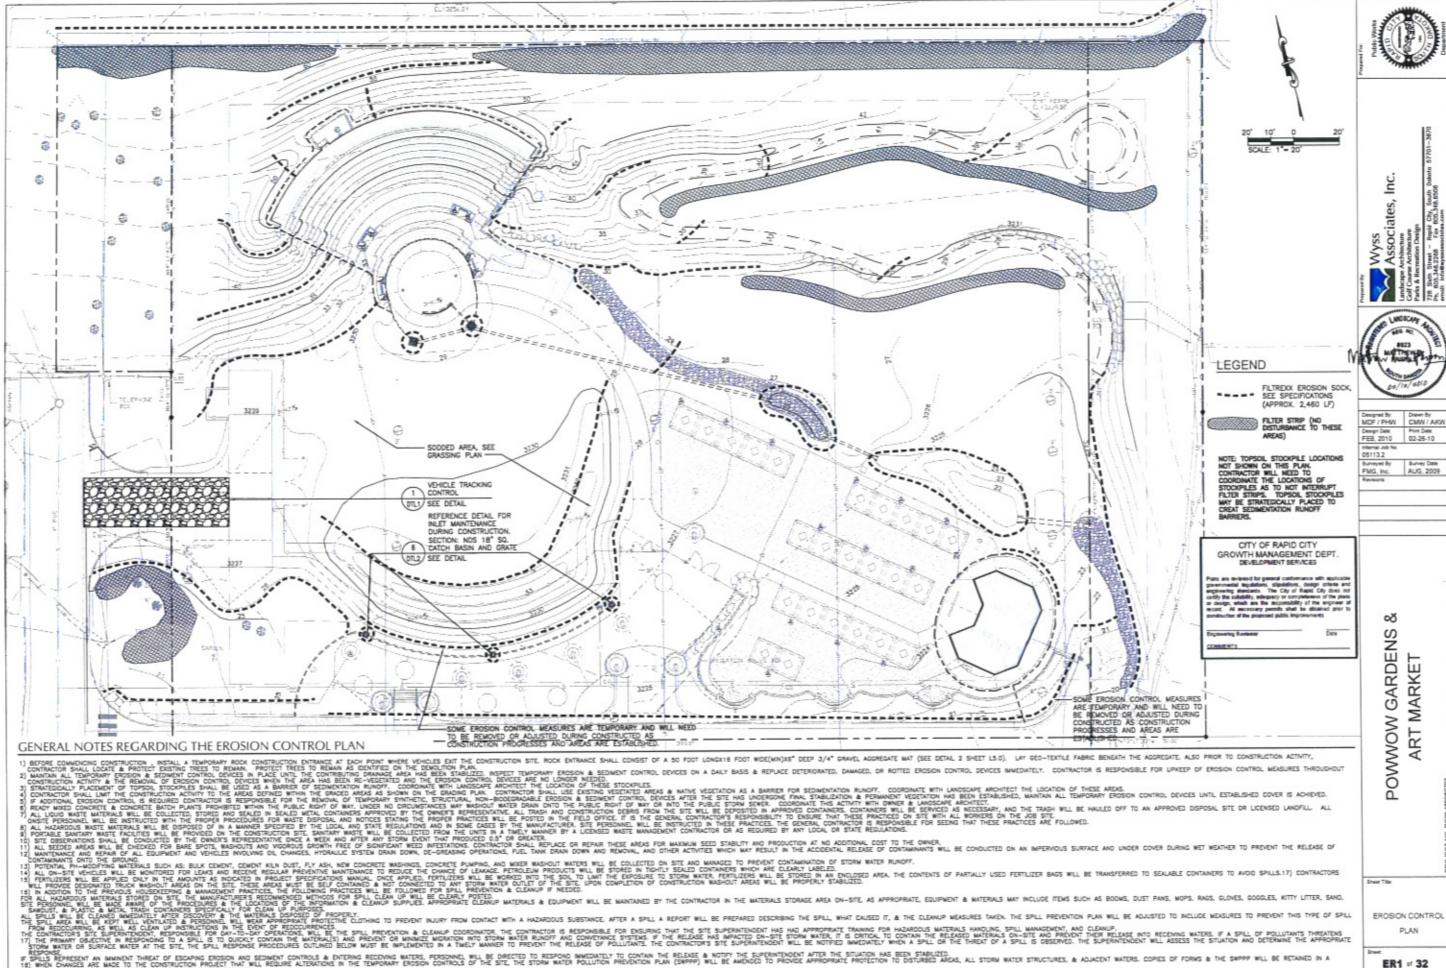








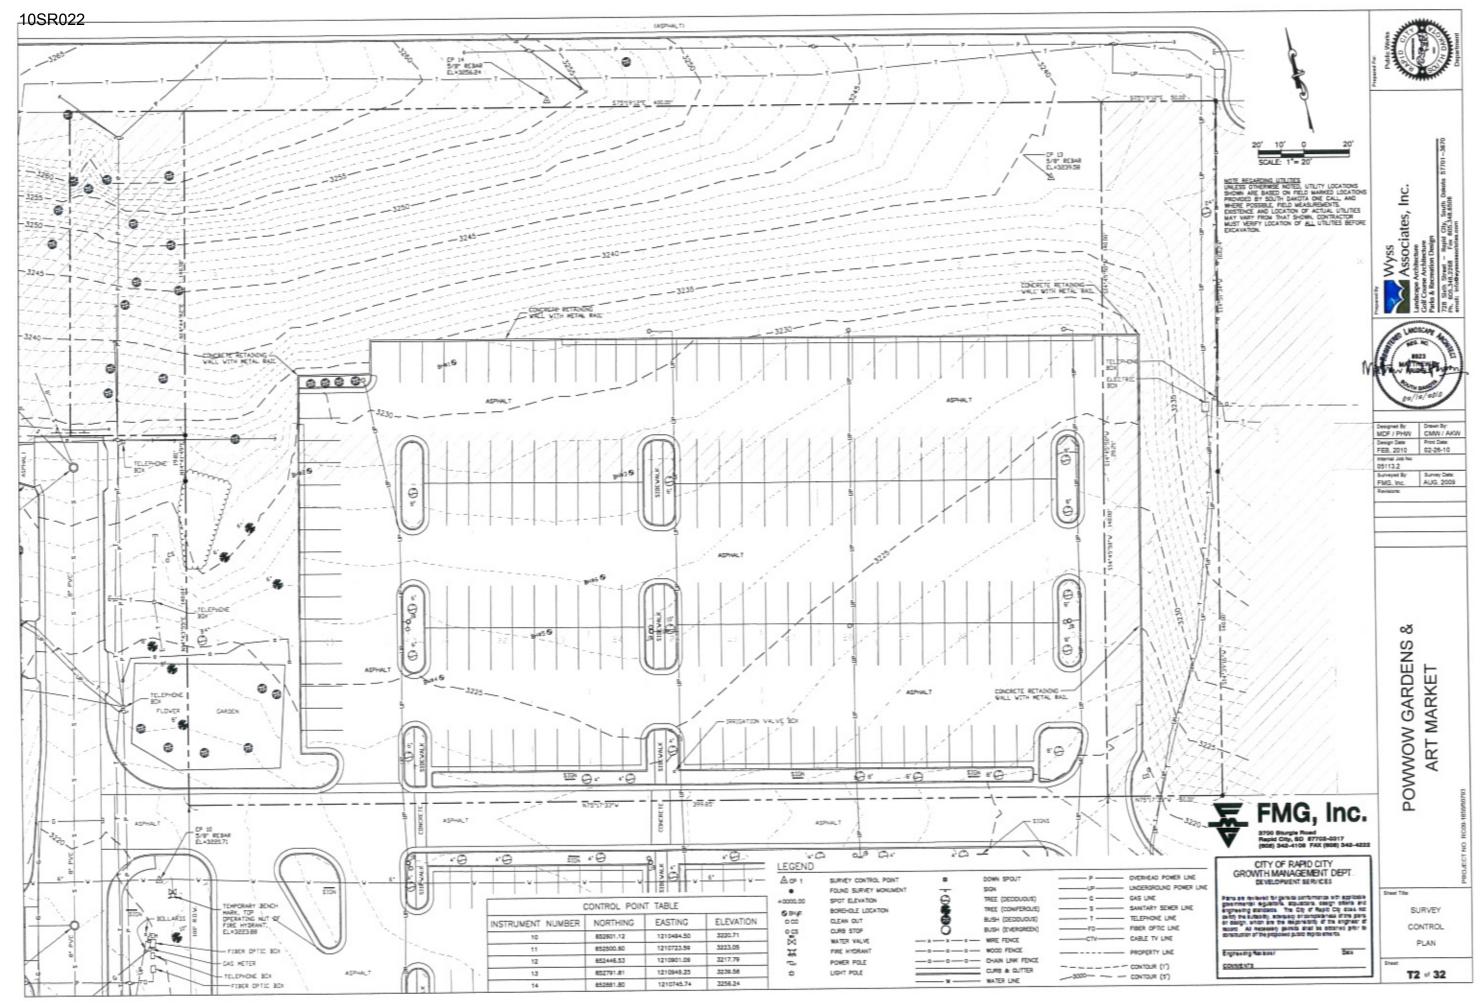

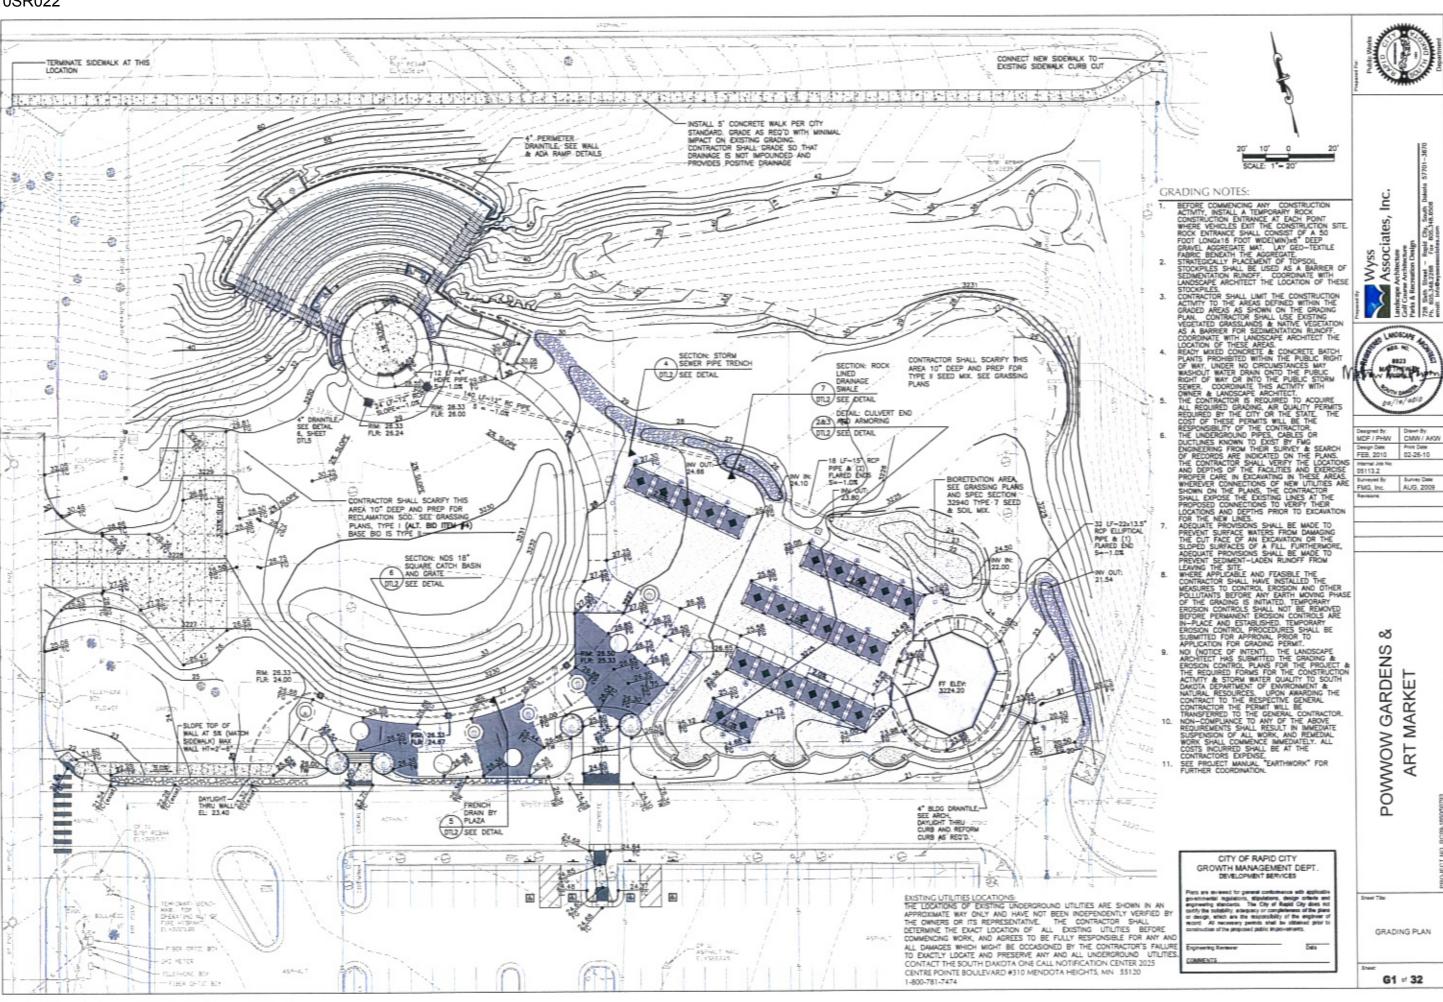

MSE.

SEPRESENT AN IMMINENT THREAT OF ESCAPING EROSION AND SEDIMENT CONTROLS & ENTERING RECEIVING WATERS, PERSONNEL WILL BE DIRECTED TO RESPOND IMMEDIATELY TO CONTAIN THE SUPERINCE PROTECTION TO DISTURBED AREAS, ALL STORM WATER STRUCTURES, & ADJACENT WATERS. COPIES OF FORMS & THE SWPPP WILL BE RETAINED IN A NO CHANGES ARE MADE TO THE CONSTRUCTION PROJECT THAT WILL REQUIRE ALTERATIONS IN THE TEMPORARY EROSION CONTROLS OF THE STORM WATER POLLUTION PREVENTION FLAN (SWPPP) WILL BE AMENDED TO PROVIDE APPROPRIATE PROTECTION TO DISTURBED AREAS, ALL STORM WATER STRUCTURES, & ADJACENT WATERS. COPIES OF FORMS & THE SWPPP WILL BE RETAINED IN A WATER POLLUTION PREVENTION FLAN (SWPPP) WILL BE AMENDED TO PROVIDE APPROPRIATE PROTECTION TO DISTURBED AREAS, ALL STORM WATER STRUCTURES, & ADJACENT WATERS. COPIES OF FORMS & THE SWPPP WILL BE RETAINED IN A WATER POLLUTION PROJECT.

∞ŏ OWWOW GARDENS ART MARKET

AUG. 2009

Sheet Title:

EROSION CONTROL

ER1 # 32

ALLIANCE OF TRIBAL TOURISM ADVOCATES (A.T.T.A.) CITY OF RAPID CITY

#### TRAIL CONTRACTOR:

TO BE DETERMINED

EROSION CONTROL CONSULTANT: WYSS ASSOCIATES, INC.

728 SIXTH STREET RAPID CITY, SD \$7701 PHONE. (605) 348-2258 matti@wyssassociates.com

THE PROJECT IS OUTDOOR MARKETPLACE AND AMPHITHEATER WHOSE MAJOR AMENITIES ARE, AN OUTDOOR AMPHITHEATER WITH PERFORMANCE AREA, A RESTROOM, VENDOR SPACES, AN OUTDOOR PLAZA, INTERPRETIVE AREAS AND WALKING TRAIL AREAS INCLUDE IRRIGATION, PLANTING AND OTHER TYPICAL PARK FEATURES

THE PROJECT IS LOCATED IN LOT 1-19 \$ W1/2 YAC 2ND ST ABUTTING LOT1 & E1/2 OF THAT PORTION OF VAC 3RD ST ABUTTING LOT 16 & N1/2 OF VAC ALLEY, ELDOX 8, DRIEDNAL TOWN OF RAPID CITY, SEC. 36, TZN, RJE, RAPID CITY, PERMINISTON COUNTY. SO

N1/2 OF LOT 17-20 & 1/2 OF ALLEY ABUTTING SAID LOTS, \$LOCK & ORIGINAL TOWN OF RAPID CITY, SEC. 36, TZN, R7E, RAPID CITY, INDIVIDUO COUNTY, 50 (IL18 ACRES) AND

S1/2 OF LOT 17-20 5 N1/2 VAC DENVER ST AD TO SAID LOTS, BLOCK 8, DRIGHAL TOWN OF RAPID CITY, SEL. 36, Tan, R7E, RAPID PENNINGTON COUNTY, SD (0.28ACRES) AND

LITE, PERMISSION COUNTY, DE (LEAR-NES) PARA LITE 21-22: SIZ VAR, ALLEY & NIZ VAR DEBMER ST ADI TO SAID LOTS, BLOCK B. CRIGINAL TOWN OF RAPID CITY, SEL 36, TZN, RIE RAPID CITY, PERMISSION COUNTY, 50 (0.23 ACRES) ANDLOT 23-24; SIZ VAR, ALLEY B NIZ VAR, DEWYER ST ADI TO SAID LOTS. BLOCK B. CRIGINAL TOWN OF RAPID CITY, SCL. 36, TZN, AZPB CITY, PERMISSION COUNTY, SO (0.23 ACRES) ANDLOT 25-32; WIZ OF VAR ZIND ST ADI TO SAID LOT 32; SIZ OF VAR ALLEY B NIZ VAR DEBMER ST ADI TO SAID LOTS 25-32, BLOCK B. CRIGINAL TOWN OF RAPID CITY, SEC. 36, YZN, RZE, RAPID CITY, PENNINGTON COUNTY, SO 1.09 ACRES) TOTAL ACREAGE: 3.73

#### EXISTING SITE CONDITIONS

THE SITE IS AN EXISTING OVERFLOW PARKING LOT FOR THE JOURNEY MUSEUM AND CIVIC CENTER. THE REMAINDER OF THE SITE HAS SOME CONFER TREES WITH NATIVE GRASSES DRAWAGE CROSSES THE SITE FROM THE NORTH-MEST TO THE SOUTHEAST, NORTH-SAD STREET IS THE WESTERN BORDER OF THE SITE THE EAST SIDE OF THE PROPERTY IS BORDERED BY NORTH 2ND STREET NORTH STREET BORDERS THE NORTH PROPERTY LINE. THE PROPERTY INCLUDES VACATED PRITONS OF NORTH 3RD STREET, NORTH 2ND STREET AND AN ALLEY.

THE SURROUNDING LAND USES ARE SINGLE-FAMILY RESIDENTIAL MULTI-FAMILY RESIDENTIAL. THE PROPERTY DIRECTLY TO THE SOUTH OF THE SITE IS DWINED BY THE CITY OF RAPID CITY.

#### SITE SOILS

CP COLOMBO-URBAN LAND COMPLEX 0 TO 1 PERCENT SLOPES 2.7% PERCENT OF SITE - LOCATED IN SECONNER SKA SATANTA-URBAN LAND COMPLEX. 0 TO 2 PERCENT SLOPES 38.1% PERCENT OF SITE - SW X; OF SITE 6 TO 15 PERCENT SLOPES \$9.1% PERCENT OF SITE - NE X OF SITE ZND ZIGWEID-NIHILL COMPLEX.

GEOTECHNICAL REPORT IS ATTACHED AS APPENDIX A.

#### AREAS

THE TOTAL SITE IS 173 ACRES (DENVER STREET UNDISTURBED IS 47 ACRES)

WORKING SITE IS 3.25 ACRES

THE ESTIMATED TOTAL DISTLIBEANCE IS APPROXIMATELY 104,368 SQ FT OR ABOUT 2.40 ACRES.

THE ESTIMATED TOTAL VOLUME OF DISTURBED SOIL IS APPROXIMATELY 5,000 CU YD. ALL SOIL SHALL BE UTILIZED ON

#### EROSION CONTROL MEASURES

EROSION & SEDIMENT CONTROL MEASURES USED ON THIS SITE WILL BE INSTALLED, MAINTAINED AND REMOVED BY CONTRACTOR, THESE MEASURES INCLUDE BUT ARE NOT LIMITED TO STRAW WATTLES OR LOGS (100% WEED FREE). TRACKING CONTROL MATERIAL (PIT RUN ROCK) AND VEGETATIVE BARRIER. THESE DOCUMENTS OUTLINE THESE PRACTICES, BUT GENERALLY LEAVE THE IMPLEMENTATION TO THE CONTRACTOR TO APPLY WHERE APPROPRIATE.

### TRADITIONAL EROSION CONTROL MEASURES

THE FOLLOWING CONTROL MEASURES SHALL BE ENFORCED ON SITE:

- 1. THE CONTRACTOR IS ULTIMATELY RESPONSIBLE FOR CONTROLLING THE TRANSPORT OF SEDIMENT ON THIS SITE. IF AT ANY TIME THE PROCEDURES OUTLINED MERBIN DO NOT PROVIDE ADEQUATE CONTROL OF THE SOIL. THEN THE CONTRACTOR IS RESPONSIBLE FOR PROVIDING IMMEDIATE AND EFFECTIVE REMEDIES, MODIFYING THE EROSION CONTROL PLAN AND CONSULTING WITH THE CITY AND LANDSCAPE ARCHITECT TO DETERMINE WHAT FURTHER
- CONTROL PLAN AND CONSULTING WITH IN HE CITY AND CARDAD-PLANE. REQUIRED TO PLANE POWNER
  MEASURES MAY BE REQUIRED TO FULLY COMPLY WITH ALL APPLICABLE REQUIRED.

  CONCRETE. READY MIXED CONCRETE AND CONCRETE BATCH PLANTS ARE PROHIBITED WITHIN THE PUBLIC RIGHT
  OF WAY. CONTRACTOR WILL NEED TO COORDINATE THE LOCATIONS OF WASHOUT AREAS WITH NEO OWNER'S
  REPRESENTATIVE AND LANDSCAPE ARCHITECT. LINDER NO CONDITIONES MAY WASHOUT WATER DRAIN INTO
  THE PUBLIC FIGHT OF WAY OR INTO THE PUBLIC STORM SEWER OR ONTO NEIGHBORING PROPERTY.
- PIPING: ALL DRAINAGE CULVERTS WILL BE PROTECTED WITH EROSION CONTROL MEASURES, SEE EROSION CONTROL PLAN.
- CONTRACTOR SHALL CONFORM TO SODOT STANDARD SPECIFICATIONS FOR TEMPORARY MEASURES TO CONTROL EROSION AND WATER POLLUTION. ALL EROSION CONTROL DEVICES SHOWN ON THE PLAN SHALL BE PROVIDED. INSTALLED AND MAINTAINED BY THE CONTRACTOR.
- CLEARING AND GRUBBING SHALL ONLY BE PERFORMED IN AREAS WHERE CONSTRUCTION ACTIVITY WILL BE PERFORMED WITHIN 24 HOURS
- 6 LANDSCAPE ARCHITECT AND CITY INSPECTOR HAVE THE AUTHORITY TO DIRECT CONTRACTOR TO PROVIDE IMMEDIATE PERMANENT AND TEMPORARY (ROSION CONTROL MEASURES TO PREVENT OFFSITE RUNOFF, CONTRACTOR SHALL REMOVE SILT FENCE, WATTLES, BALES (F USED) AND OTHER TEMPORARY MEASURES WHEN
- THEY ARE NO LONGER NEEDED.

  SITE DISSERVATIONS SHALL BE CONDUCTED BY THE OWNER'S REPRESENTATIVE AND COMPLY WITH STATE STORM WATER POLLUTION PREVENTION PLAN REGULATIONS AS WELL ONCE A WEEK AND AFTER ANY STORM EVENT THAT PRODUCED 15' OR GREATER, ALL SEEDED AREAS WILL BE CHECKED FOR BARE SPOTS, WASHOUTS AND VIGOROUS GROWTH FREE OF BIGNIFICANT WEED INVESTMENTS. CONTRACTOR SHALL REPLACE OR REPAIR THESE AREAS FOR MAXIMUM SEED STABILITY AND PRODUCTION AT NO ADDITIONAL COST TO THE OWNER.

  NATURAL VEGETATION SHALL ACT AS A FILTER STRIP BELOW TRAIL CONSTRUCTION. WHERE THIS STRIP IS LESS.
- HAN 20 OF UNCOVERED EXISTING VEGETATION ADDITIONAL EROSION CONTROL MEASURES SUCH AS LISTED ABOVE MAY BE REQUIRED.
- CONTRACTOR IS RESPONSIBLE FOR CLEANING ENTRANCE ROADS DAILY OF ALL DIRT, MUD AND DEBRIS DEPOSITED ON THEM AS A RESULT OF THE CONSTRUCTION OPERATION.
- 10 CONTRACTOR SHALL COORDINATE THE LOCATION OF STAGING AREAS WITH OWNER CONCESSIONAIRE & LANDSCAPE ARCHITECT.

#### CONSTRUCTION SITE NONSTRUCTURAL CONTROL MEASURES

THE FOLLOWING NONSTRUCTURAL CONTROL MEASURES SHALL BE ENFORCED ON SITE.

- SIGNAGE. A SIGN COMPLYING WITH CITY STORM WATER QUALITY MANUAL, ITEM 1853 "CONTACT INFORMATION
- DISPLAY REQUIREMENTS WILL BE POSTED AT EACH ENTRANCE.

  2. AIR QUALITY: CONTRACTOR IS RESPONSIBLE FOR COMPLYING WITH ANY AIR QUALITY CONTROL MEASURES.
  REQUIRED BY THE LOCAL GOVERNMENT AGENCIES. DUST SHALL BE CONTROLLED BY SCHEDULED WATERING OR. OTHER APPROVED METHODS
- 3 SANTARY WASTE FACILITIES: PORTABLE SANTARY WASTE FACILITIES WILL BE PROVIDED ON THE CONSTRUCTION SITE. SANTARY WASTE WILL BE COLLECTED FROM THE UNITS IN A TIMELY MANNER BY A LICENSED WASTE MANAGEMENT CONTRACTOR OR AS REQUIRED BY ANY LOCAL OR STATE REGULATIONS.
- 4 SPILL PREVENTION
  - . CLEAN UP LEAKS DRIPS AND OTHER SPILLS IMMEDIATELY
  - b. ALL LIQUID WASTE MATERIALS WILL BE COLLECTED. STORED AND SEALED IN SEALED METAL CONTAINERS APPROVED BY THE OWNER'S REPRESENTATIVE.
  - ALL TRASH AND CONSTRUCTION DEBRIS FROM THE SITE WILL BE DEPOSITED IN APPROVED CONTAINERS. CONTAINERS WILL BE SERVICED AS NECESSARY, AND THE TRASH WILL BE HALLED OFF TO AN APPROVICE DISPOSAL SITE OR LICENSED LANDFILL. REGULARLY PICKUP AND DISPOSE OF GARBAGE AND WASTE MATERIAL
  - 4. ALL ONSITE PERSONNÉL WILL BE INSTRUCTED WITH THE PROPER PROCEDURÉS FOR WASTE DISPOSAL AND NOTICES STATING THE PROPER PRACTICES WILL BE POSTED IN THE FIELD OFFICE. IT IS THE GENERAL CONTRACTOR'S RESPONSIBILITY TO ENSURE THAT THESE ARE PRACTICED ON SITE WITH ALL WORKERS ON THE JOB SITE.
- e. FERTILIZERS THE USE OF FERTILIZERS IS NOT ANTICIPATED
- 5 HAZARDOUS WASTE HANDLING
  - 8 ALL HAZARDOUS WASTE MATERIALS WILL BE DISPOSED OF IN A MANNER SPECIFIED BY THE LOCAL AND STATE REGULATIONS AND IN SOME CASES BY THE MANUFACTURER.
  - b. ALL SITE PERSONNEL WILL BE INSTRUCTED IN THESE PRACTICES. ASSIGN RESPONSIBILITY OF HAZARDOUS MATERIAL INVENTORY TO A LIMITED NUMBER OF PEOPLE WHO ARE TRAINED TO HANDLE SUCH MATERIALS. IN THE EVENT OF SPILLS OF ANY DANGEROUS OR HAZARDOUS MATERIAL, NOTIFY CITY PUBLIC WORKS DEPARTMENT
  - c. THE CONTRACTOR IS RESPONSIBLE FOR SEEING THAT THESE PRACTICES ARE FOLLOWED
- E EQUIPMENT MAINTENANCE
  - A MAINTENANCE AND REPAIR OF ALL EQUIPMENT AND VEHICLES INVOLVING DIL CHANGES, HYDRAULIC SYSTEM DRAIN DOWN, DE-GREASING OPERATIONS, FUEL TANK DRAIN DOWN AND REMOVAL, AND OTHER ACTIVITIES WHICH MAY RESULT IN THE ACCIDENTAL RELEASE OF CONTAMINANTS WILL BE CONDUCTED ON AN IMPERVIOUS SURFACE AND UNDER COVER DURING WET WEATHER TO PREVENT THE RELEASE OF CONTAMINANTS ONTO THE
  - E IF NO IMPERYOUS SURFACE IS AVAILABLE THEN DRAIN OR REPLACE MOTOR OIL OR OTHER AUTOMOTIVE FLUIDS IN AN AREA AWAY FROM STREAMS OR STORM OR SANITARY SEWER INLETS. COLLECT SPENT FLUIDS AND RECYCLE OR DISPOSE OF PROPERLY.
  - C PETROLEUM PRODUCTS WILL BE STORED IN TIGHTLY SEALED CONTAINERS WHICH ARE CLEARLY LABELED
  - & PERFORM REGULAR MAINTENANCE OF EACH PIECE OF EQUIPMENT TO CHECK FOR: PROPER OPERATION, LEAKS, MALFUNCTIONS, AND EVIDENCE OF LEAKS OR DISCHARGE (STAINS). CONTRACTOR WILL HAVE A PROCEDURE FOR SPILL REPORTING CLEANUP, AND REPAIR.
- # IN FUELING AREAS CLEAN UP SPILLS WITH DRY CLEANUP METHODS (ASSORBENTS). AND USE DAMP CLOTHS ON GAS PUMPS AND DAMP MOPS ON FLOORS INSTEAD OF A HOSE.
- OTHER MEASURES AS OUTLINED IN THE CITY OF RAPID CITY STORM WATER QUALITY MANUAL AND BY THE THE SO DEMR STORM WATER POLLUTION PERMIT SHALL BE FULLY INTEGRATED INTO THESE PLANS AS NECESSARY TO

#### TIME SCHEDULE

CONSTRUCTION STAGING TO BE DETERMINED BASED UPON BIO ADVERTISEMENT

EROSION CONTROL INSTALLATION. TO BE DETERMINED BASED UPON BID ADVERTISEMENT

CONSTRUCTION COMMENCES TO BE DETERMINED BASED UPON BID ADVERTISEMENT

BUBSTANTIAL COMPLETION: TO BE DETERMINED BASED UPON BID ADVERTISEMENT

SERDING TO BE DETERMINED BASED UPON BID ADVERTISEMENT

GROW-IN PERIOD: TO BE DETERMINED BASED UPON BID ADVERTISEMENT

#### PERMANENT STABILIZATION

IT IS ANTICIPATED THAT THE PROJECT WILL PRIMARILY BE STABILIZED BY THE COMPLETE GRO-IN OF LANDSCAPE MATERIAL AT THE END OF FALL 2010. LANDSCAPE DETENTION AREAS, ROCKED AREAS AND OTHER STORM WATER. INFRASTRUCTURE WILL REQUIRE A MINIMUM OF ANNUAL MAINTENANCE, WITH CLEANING OF ACCUMULATED MATERIALS. AND ROUTINE CHECKING TO ENSURE THE FACILITIES ARE OPERATING AS INTENDED. DETENTION AREAS MAY REQUIRE MORE EXTENSIVE SOIL MODIFICATIONS ON A DECANNUAL SCHEDULE.

#### STORM WATER MANAGEMENT CONSIDERATIONS

THIS INITIAL PHASE OF THE PROCESS ALSO USES BEST MANAGEMENT PRACTICES FOR STORMWATER QUALITY TO GUIDE THE BASIC FORMULATION OF THE INFRASTRUCTURE. THESE FEATURES, TREATED AS AMENITIES BY THIS PLAN, PROVIDE THE BACKBONE OF THE SITE AND ARE FULLY INTEGRATED INTO EACH AMENTY. THE FOLLOWING DESCRIPTIONS PROVIDE THE LOGIC FOR EACH AREA OF THE SITE

- . PLAZA (SMALL CONCRETE GATHERING AREA AT ENTRANCE OF SITE) SHALL "SHEET DRAIN" ONTO EXISTING CLIRE AND GUTTER THAT DRAINS WEST AND EAST TO THE SOUTH OF THE PROJECT
- . LAWN AREAS. WATER HERE TRANSPORTED IN MINOR LANDSCAPED SWALES (GRASSED)
- AMPHITHEATER AND PERFORMANCE AREA. THESE GRASS AREAS ARE GRADED AS GIANT DISH THAT DRAINS TO AN AREA INLET AND THEN DISPERSED INTO A GRASS SWALE THAT EMPTIES INTO CHISTE BIORETENTION AREA.
- . NATURAL AREAS OF THE SITE. MOST OF THE SITE WILL BE RECLAIMED TO NATURAL GRASS LAND WITH ONLY MINIMAL GRADING TO PROVIDE TRAILS.
- . THE DRAINAGE THROUGH THE SITE WILL RECEIVE ONLY MINOR IMPACTS BY THIS DESIGN. IT'S DISCHARGE POINT AT THE SOUTHEAST CORNER OF PROPERTY WILL NOT CHANGE AT THIS TIME.

THIS SITE IS DESIGNED SO THAT CONSTRUCTION STORMWATER CONTROLS EVOLVE INTO THE PERMANENT STORMWATER QUALITY MEASURES THAT ENSURE A SUSTAINABLE DESIGN AS FOLLOWS

- . LANCSCAPE DETENTION AREAS SHALL BE MAINTAINED AS SECUMENT BASINS DURING CONSTRUCTION.
- . SITE IS BEING RECLAIMED FROM ASPHALT PARKING TO PARK TYPE, EXISTING SITE IS 50% IMPERVIOUS THIS PROJECT AT FULL BUILD OUT WILL HAVE A TOTAL IMPERVIOUS PERCENTAGE OF 27%
- RELATIVELY MINOR IMPACT TO THE OVERALL SITE ENSURES THAT THE WATER IN THE CONSTRUCTION AREAS IS LIMITED
- . GRADING DOES NOT INTERRUPT NATURAL SHEET FLOW ON THE SITE

### WETLANDS

NO WETLANDS ARE ON SITE

#### DEWATERING

DÉWATÉRING OPERATIONS ARE NOT EXPECTED. IF NEEDED, A GENERAL DEVIATERING PERMIT WILL BE REQUIRED.

A NOTICE OF INTENT HAS BEEN FILED WITH DENR BY THE LANDSCAPE ARCHITECT. SEE APPENDIX

#### MAINTENANCE

INSPECTION OF EROSION AND SEDIMENT CONTROL MEASURES SHOULD BE SCHEDULED BY MEEKLY AND FOLLOWING ANY STORM EVENT OF 1/2 INCH OR GREATER, ALL MEASURES SHOULD BE MAINTAINED IN GOOD WORKING OPDER. INSPECTION AND MAINTENANCE OF EROSION CONTROL MEASURES AND THE ENTIRE TRAIL SHALL CONTINUE MONTHLY UNTIL THE SUMMER OF 2011 TO ENSURE NO PROBLEM AREAS DEVELOP WITHIN THE SITE PROJECT LIMIT. ANY AREAS THAT INDICATE POTENTIAL LONG TERM DAMAGE SHALL HAVE APPROPRATE DESIGN MEASURES TAKEN TO HALT SIGNIFICANT SITE DAMAGE. SEASONAL INSPECTION AND MAINTENANCE WILL BE REQUIRED FOR THE LIFE OF THE GRASSED TRAIL

ONGOING MAINTENANCE AFTER FINAL ACCEPTANCE WILL BE DONE BY THE OWNER (ATTA) AND WILL FOLLOW THE CHECKLISTS ATTACHED IN THE PROJECT MANUAL APPENDIXES.

#### OWNER'S CERTIFICATION

THIS EROSION AND SEDIMENT CONTROL REPORT AND ATTACHED SITE CONSTRUCTION PLAN APPEAR TO FULFILL THE TECHNICAL CRITERIA AND THE CRITERIA FOR EROSION AND SEDMENT CONTROL REQUIREMENTS OF THE CITY OF RAPID CITY. I UNDERSTAND THAT ADDITIONAL EROSION CONTROL MEASURES MAY BE NEEDED IF UNFORESEEN EROSION OR SEDIMENT CONTROL PROBLEMS OCCUR OR IF THE SUBMITTED PLAN DOES NOT FUNCTION AS INTENDED. THE REQUIREMENTS OF THIS PLAN SHALL RUN WITH THE LAND AND BE THE OBLIGATION OF THE LANDOWNER UNTIL SUCH TIME AS THE PLAN IS PROPERLY COMPLETED. MODIFIED. OR VOIDED.

	SIGNED	_
ATE	OWNER'S REPRESENTATIVE	
	ALTHORITY.	

#### ENGINEER'S CERTIFICATION

I HEREBY CERTIFY THAT THESE PLANS WILRE PREPARED LINDER MY DIRECT SUPERVISION AND THAT I AM A DULY REGISTERED LANDSCAPE ARCHITECT UNDER THE LAWS OF THE STATE OF BOUTH DAKOTA

	SIGNET		
DATE		MATT FRIDELL RUA	REG NO 8923

## PRIME CONTRACTOR'S CERTIFICATION

THIS SECTION IS TO BE EXECUTED BY THE GENERAL CONTRACTOR AFTER THE AWARD OF THE CONTRACT. THIS SECTION MAY BE EXECUTED ANY TIME THERE IS A CHANGE IN THE PRIME CONTRACTOR OF THE PROJECT

I CERTIFY UNDER PENALTY OF LAW THAT THIS DOCUMENT AND ALL ATTACHMENTS WILL BE REVISED OR MAINTAINED UNDER MY DIRECTION OR SUPERVISION IN ACCOMPANCE WITH A SYSTEM DESIGNED TO ASSURE THAT QUALIFIED PERSONNEL PROPERLY GATHER AND EVALUATE THE INFORMATION SUBMITTED BASED ON MY INDURRY OF THE PERSON OR PERSONS WHO MANAGE THE SYSTEM, OR THOSE PERSONS DIRECTLY RESPONSIBLE FOR GATHERING THE INFORMATION, THE INFORMATION SUBMITTED IS TO THE BEST OF MY KNOWLEDGE AND BELIEF, TRUE, ACCUPATE, AND COMPLETE, I AM AWARE THAT THERE ARE SIGNIFICANT PENALTIES FOR SUBMITTING FALSE INFORMATION, INCLUDING THE POSSIBILITY OF FINE AND IMPRISONMENT FOR KNOWING VIOLATIONS

	SIGNED
DATE	
	WHITE OUT CONTRACTOR'S POINT OF CONTACT AND COMPANY NAM

CITY OF RAPID CITY CROWTH MANAGEMENT DEPT DEVELOPMENT SERVICES

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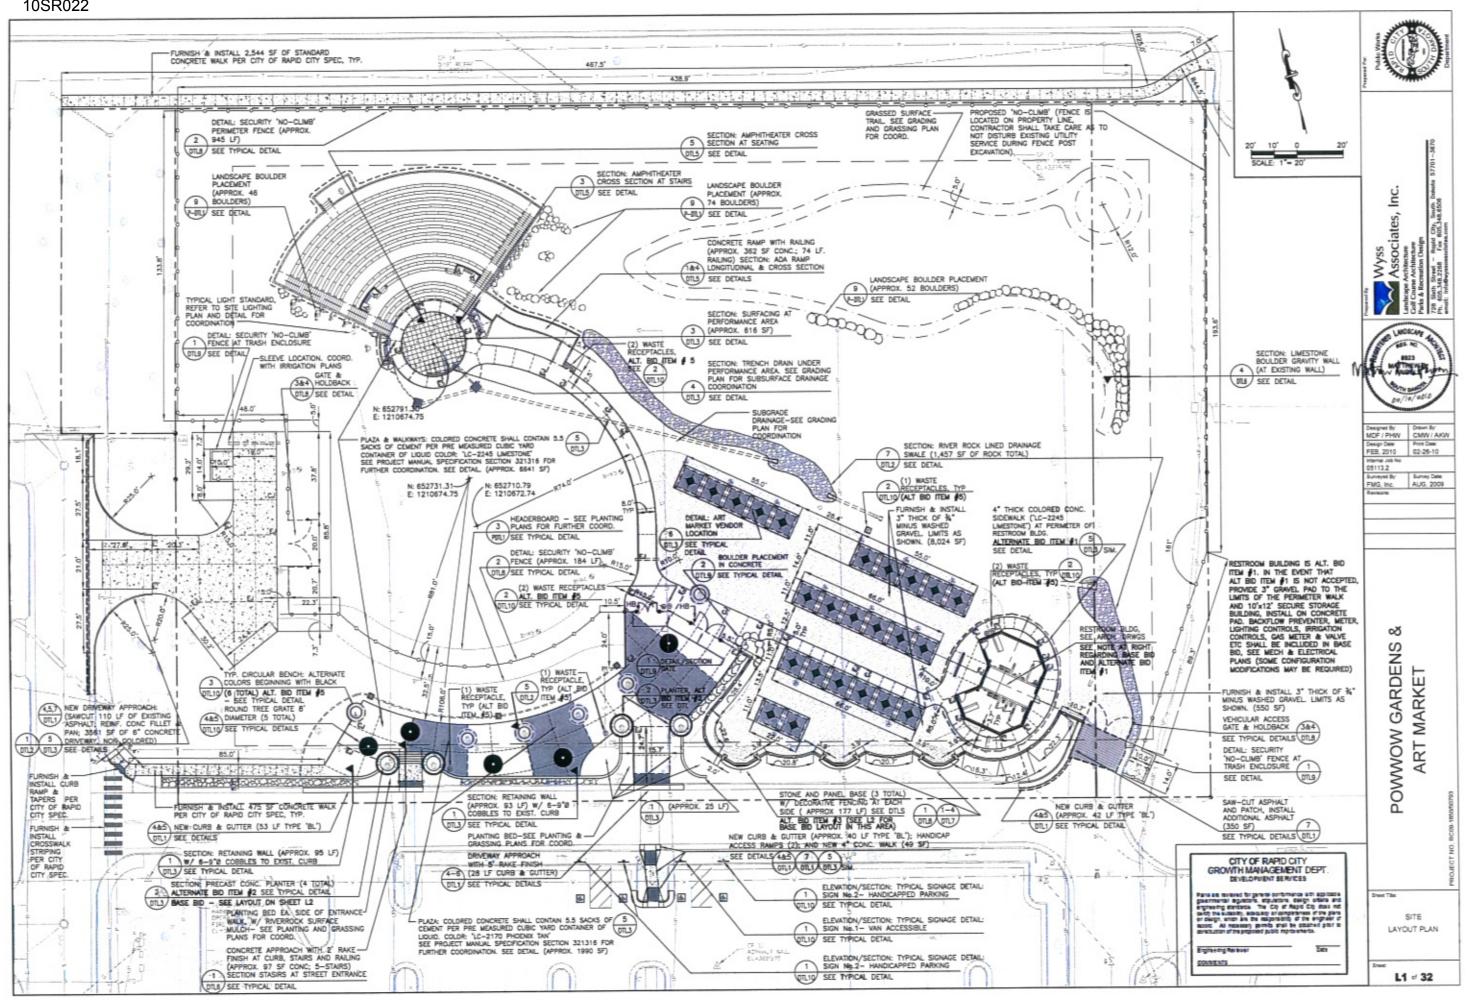
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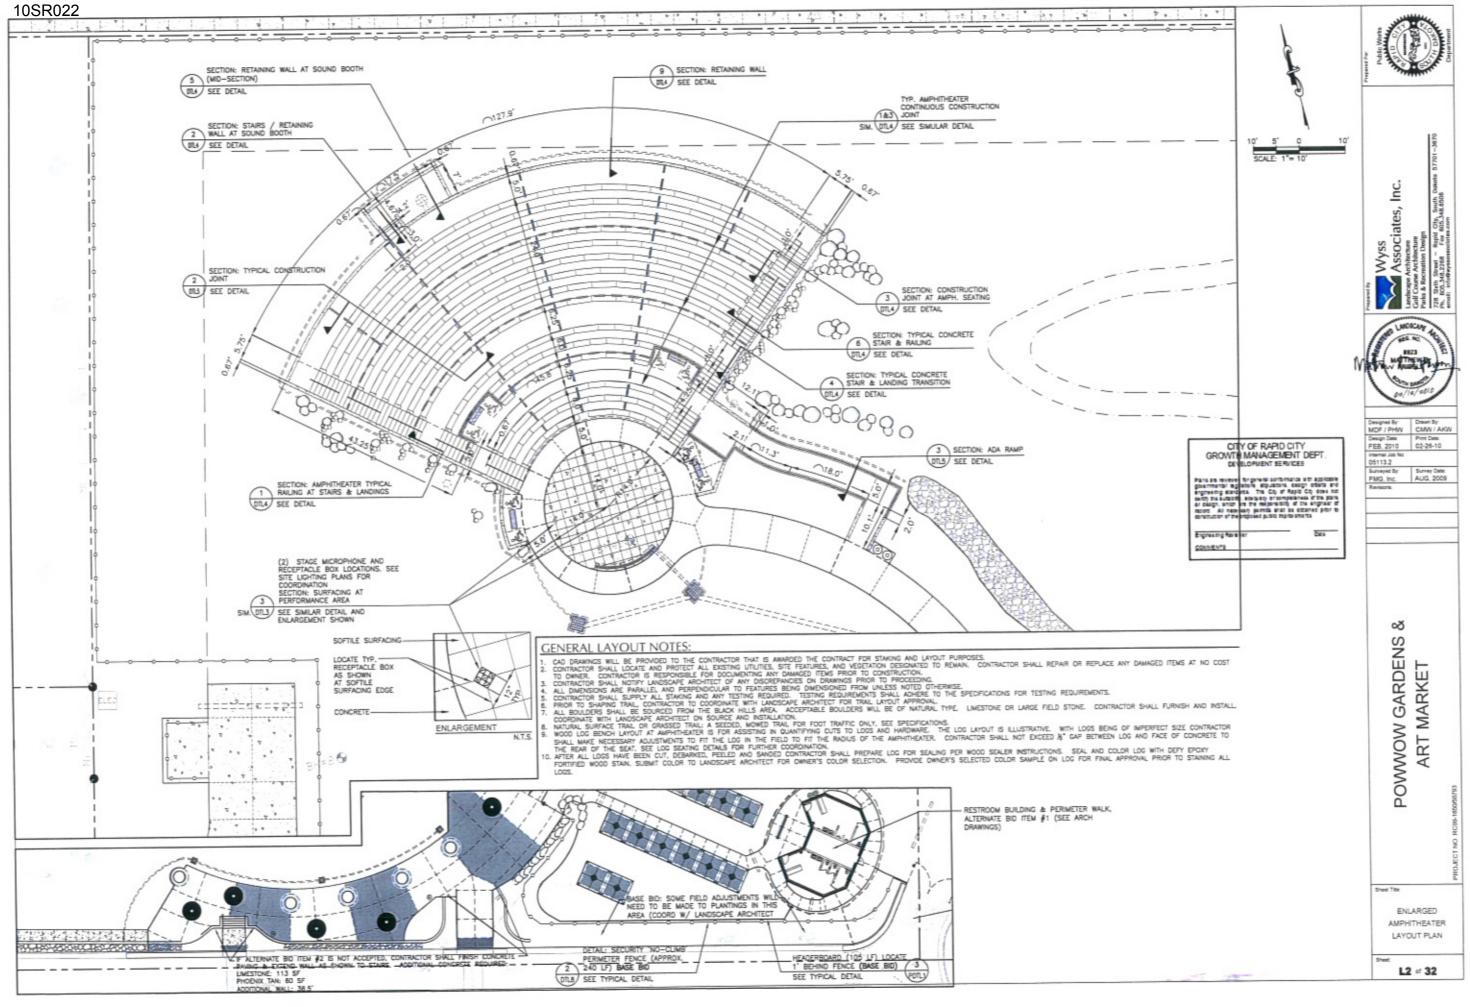
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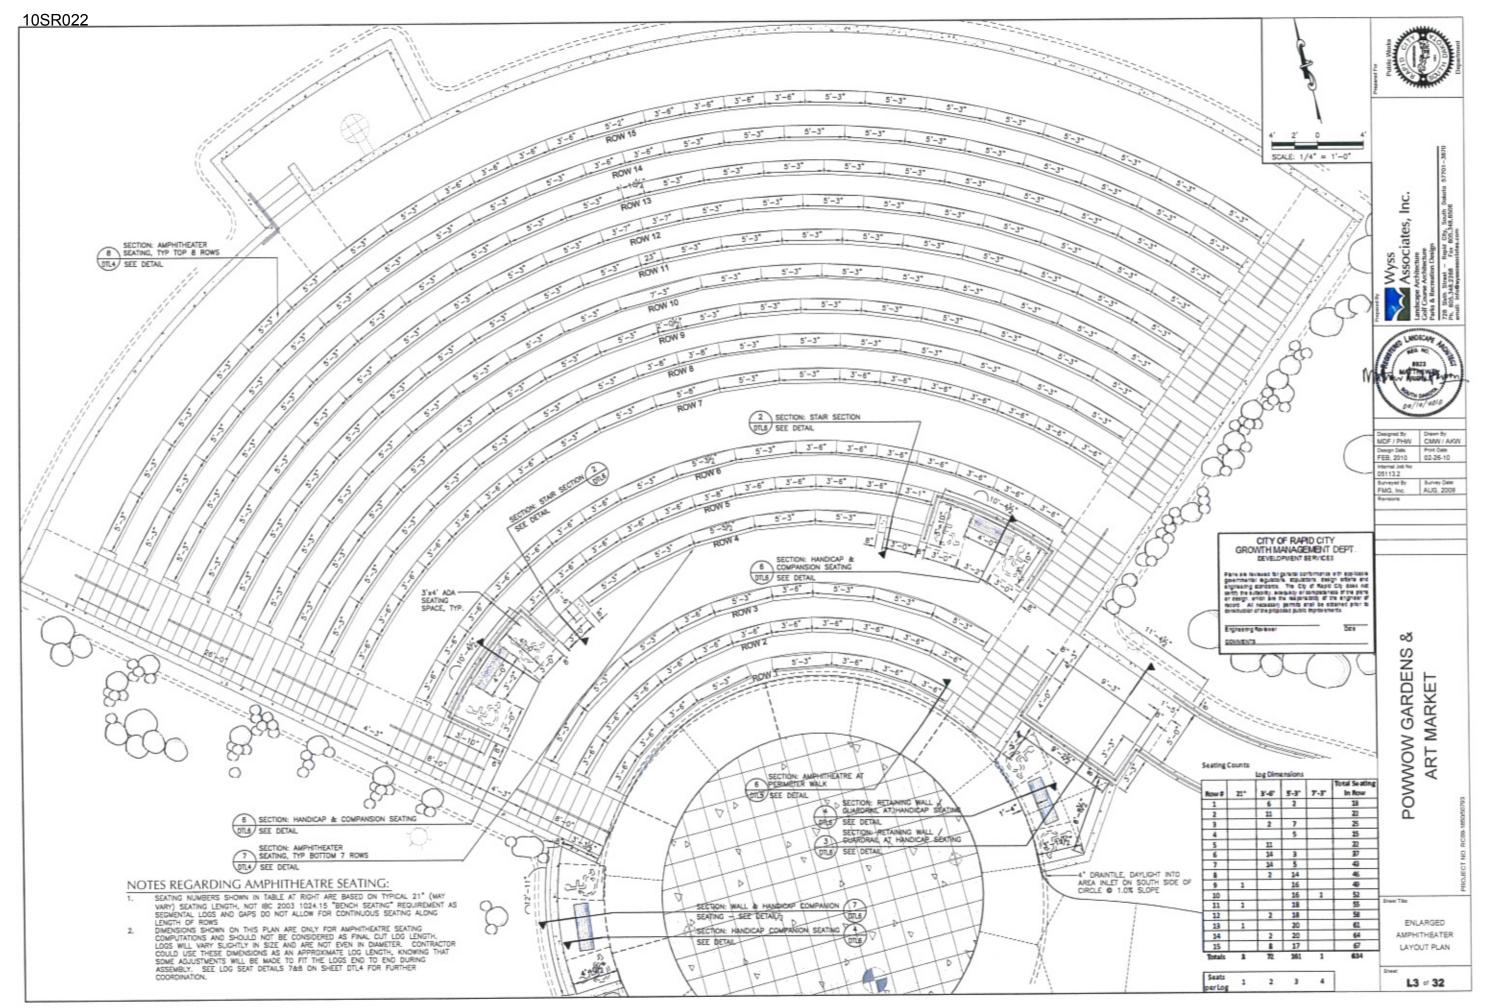
**EROSION CONTROL** 


REPORT

ER2 of 32










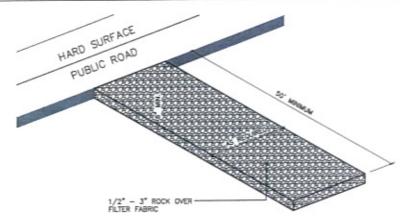


VEHICLE TRACKING CONTROL

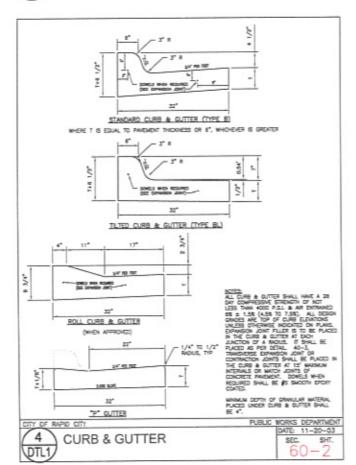


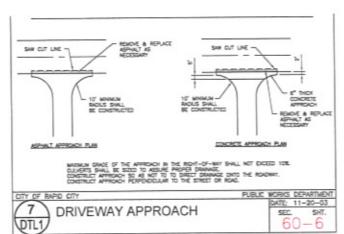

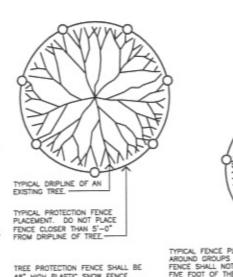


HREE PHOLICION FENCE SPACE &
48" HIGH PLASTIC SNOW FENCE,
CRANGE IN COLOR, OR AS SPECIFIED
IN PROJECT MANUAL, FENCE SHALL
BE SECURED TO STEEL "I" POSTS WITH
20 GA. WIRE. POSTS SHALL BE SPACED NO GREATER THAN 8'-0" ON CENTER.

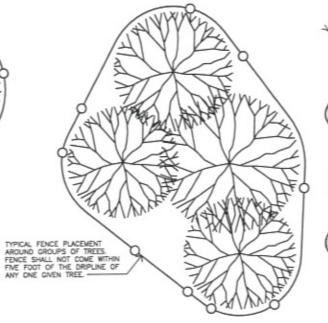


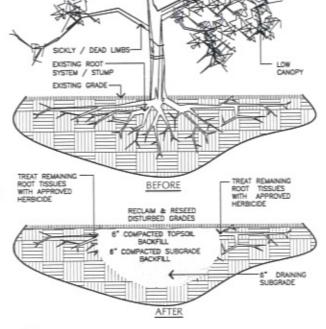


TREE REMOVAL TYPICAL DETAIL

PLAN: TYPICAL TREE PROTECTION FENCE PLACEMENT SCALE: 1/8" = 1'-0"

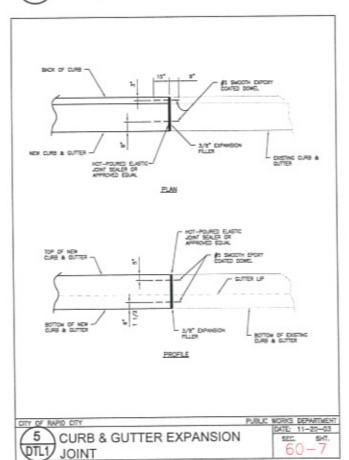

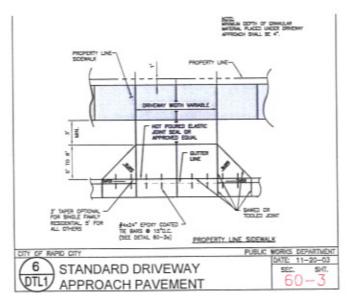

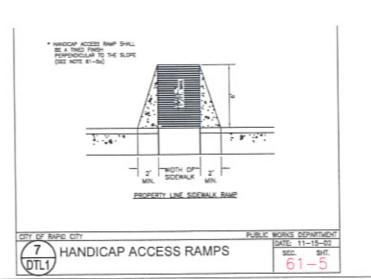

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SITE DETAILS

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**ART MARKET** 


POWWOW GARDENS


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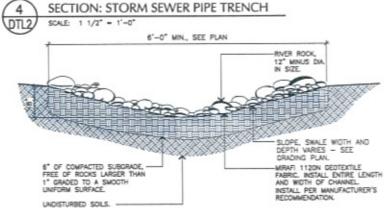
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Survey Date: AUG, 2009





IN AREAS WITHIN PROJECT, ALL TRENCHING AREAS CONTRACTOR SHALL INSTALL 6" TOPSOIL IN ALL DISTURBED AREAS.

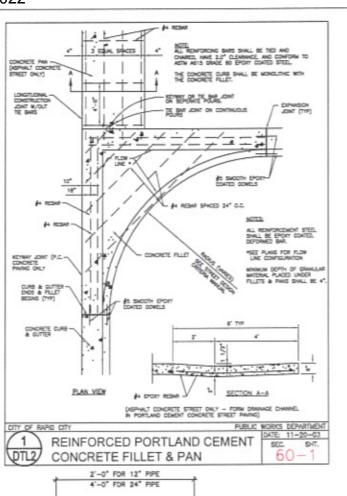


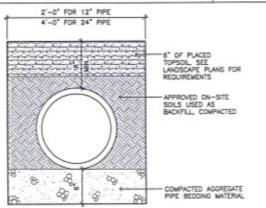SECTION: RIVER ROCK LINED DRAINAGE SWALE

SCALE: 1" = 1'-0"


-RING CULVERT WITH 4"-8" RIVER COBBLES GEOTEXTILE, SEE DRAINAGE INSET COBBLES SO THAT TOP OF COBBLES ARE DO NOT EXCEED TOP OF OUTLET OR INLET ELEVATION OF FLARED END SECTION PLAN ELEVATION


DETAIL: METAL CULVERT END ARMORING

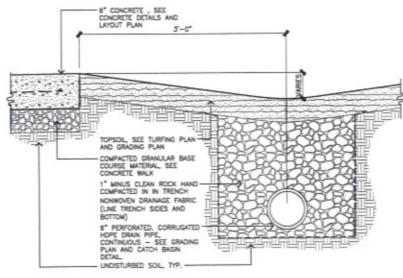


SECTION: FRENCH DRAIN BY PLAZA SCALE: 1 1/2" = 1'-0"

SCALF: 3/4" = 1'-0"

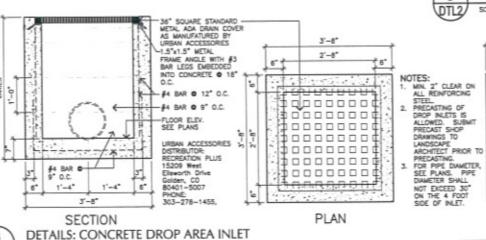


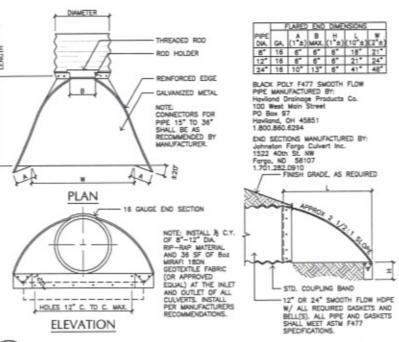

DETAIL: HDPE DRAIN PIPE & METAL CULVERT END SECTION NOT TO SCALE

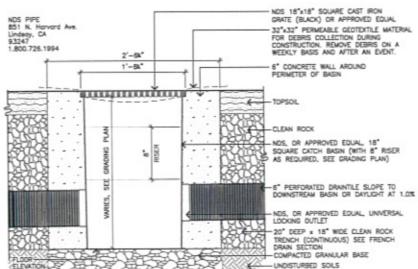

SECTION: NDS 18" SQUARE CATCH BASIN AND GRATE 6 SCALE: 1 1/2" = 1'-0"

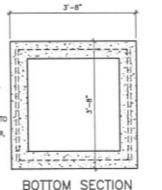

CITY OF RAPID CITY GROWTH MANAGEMENT DEPT DEVELOPMENT SERVICES

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Emphasing Nation COMMENTS

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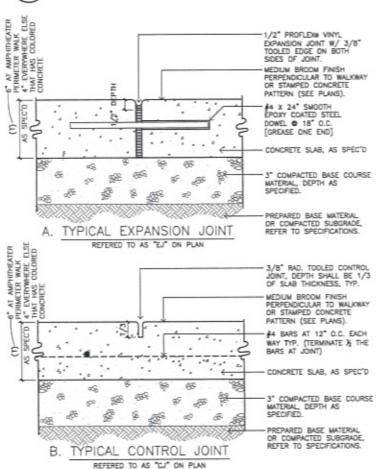
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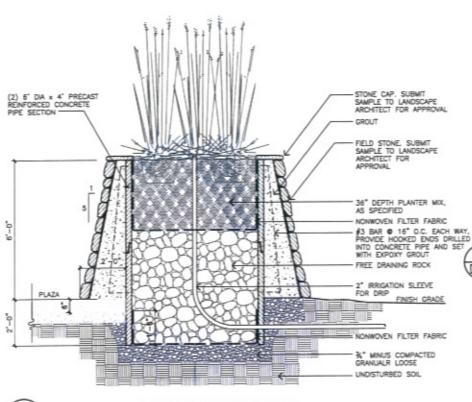
SITE DETAILS





SECTION: TYPICAL CONCRETE JOINT DETAILS


SCALE: 3" = 1'-0"




SECTION: PRECAST CONCRETE PLANTER ALTERNATE BID ITEM #2 SCALE: 1/2" = 1'-0'


DETAIL: ART MARKET VENDOR LOCATION

SCALE: 1/2" = 1'-0"

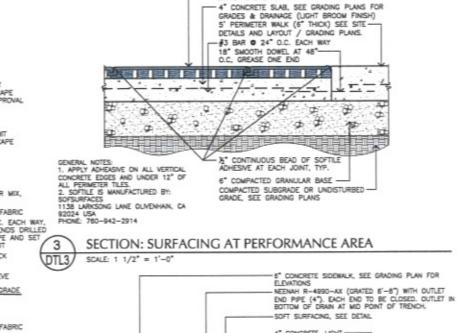

SOFTILE SURFACING (2" DEPTH) SEE PLANS FOR COLOR LAYOUT INSTALL PER MANUFACTURER'S RECOMMENDATIONS.

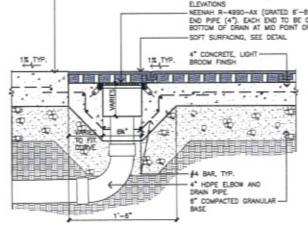

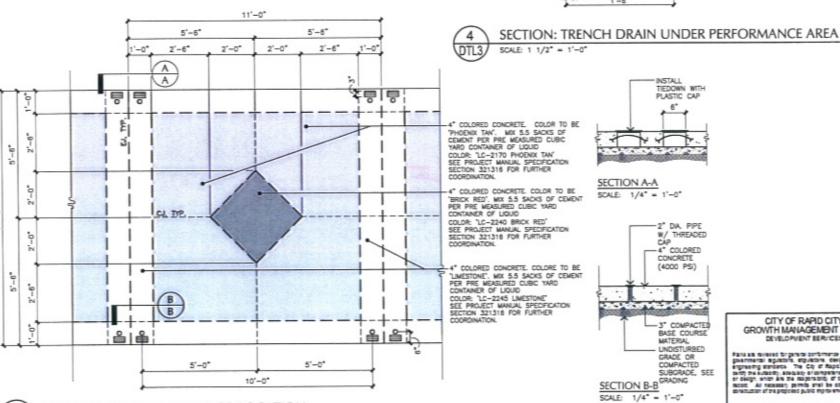

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Designed By Drawn By: MDF / PHW CMW / AKW

AUG. 2009

Design Date: FEB, 2010

05113.2 FMG, Inc.

Wyss Associates, Inc.

POWWOW GARDENS MARK R

CITY OF RAPID CITY


GROWTH MANAGEMENT DEPT.


DEVELOPMENT SERVICES


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SITE DETAILS

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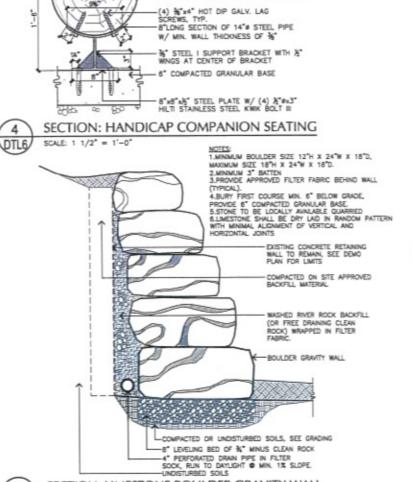



GLASS WEDGE

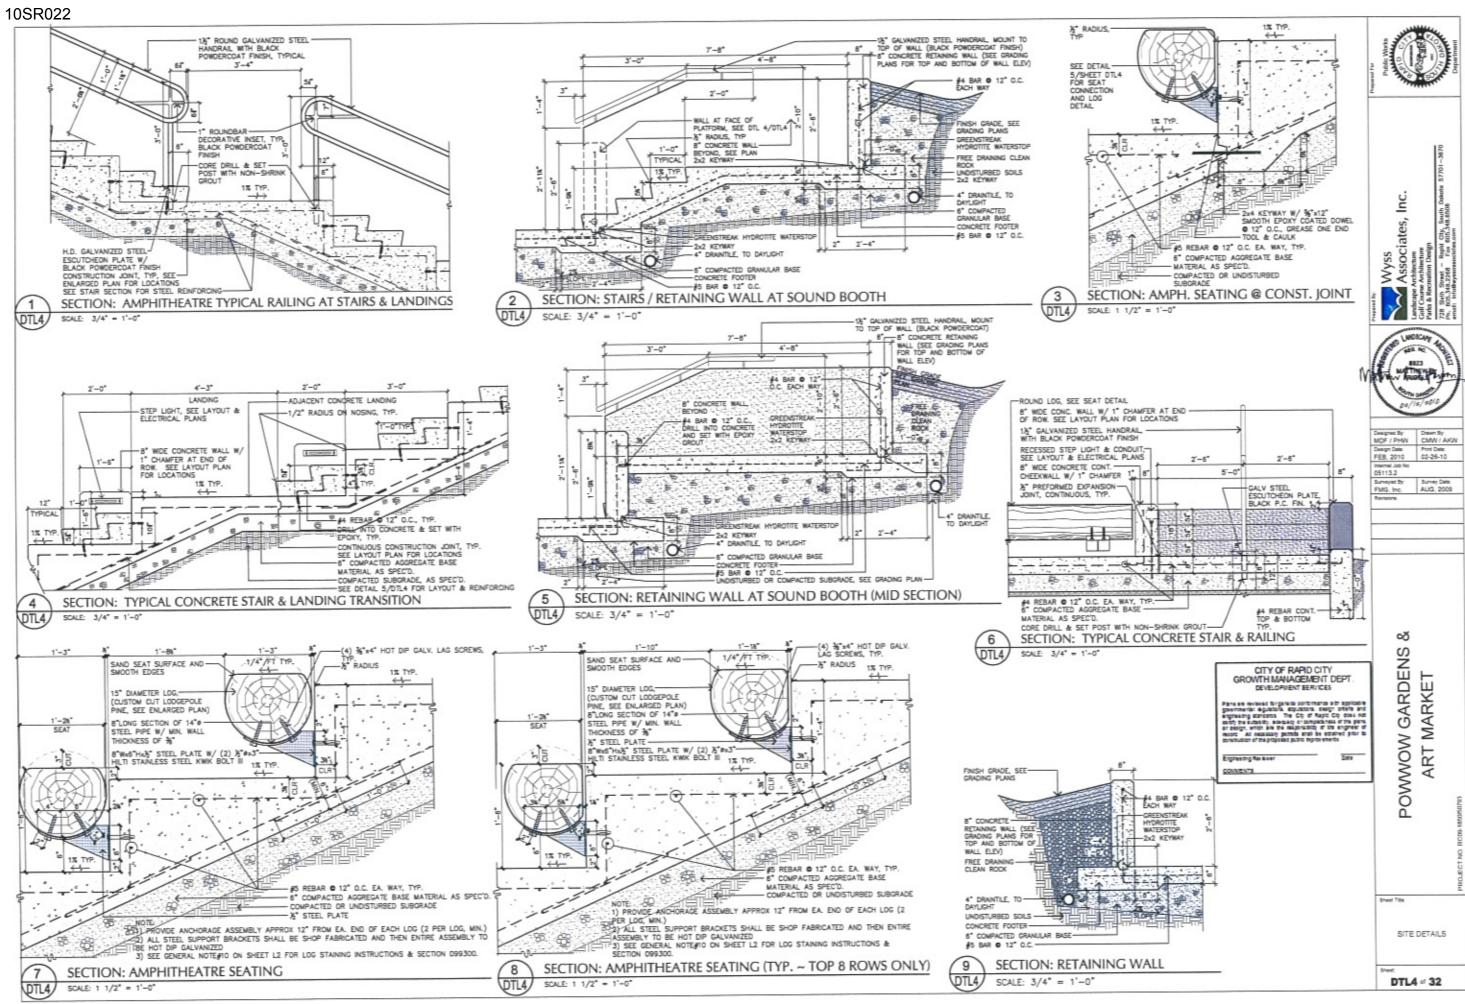WALL BEYOND, SEE LAYOUT &
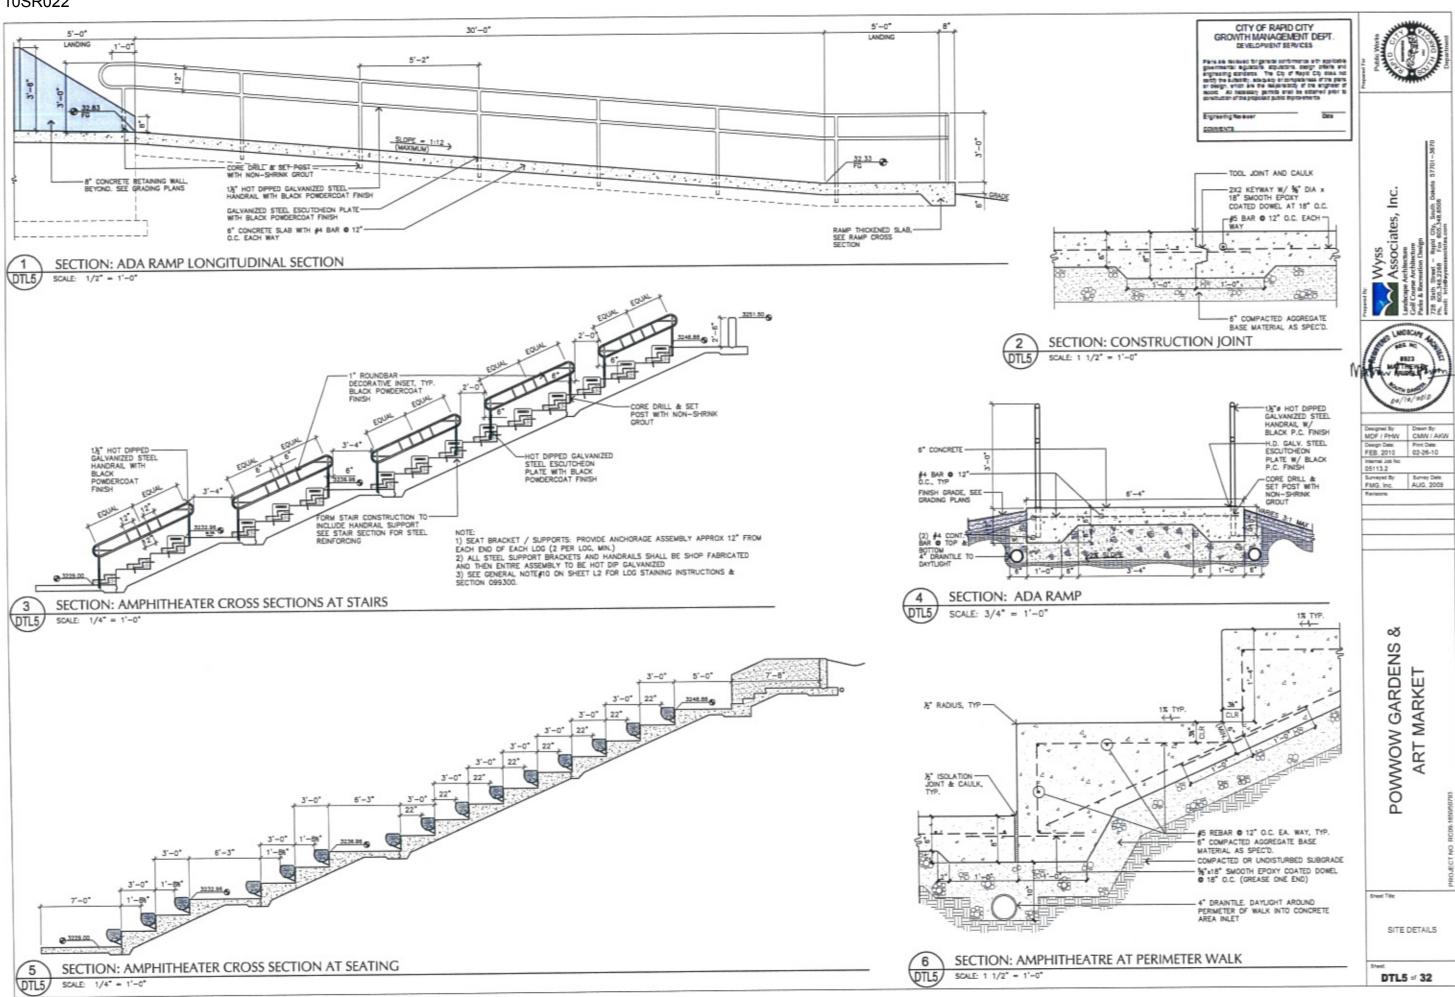
#29.20±

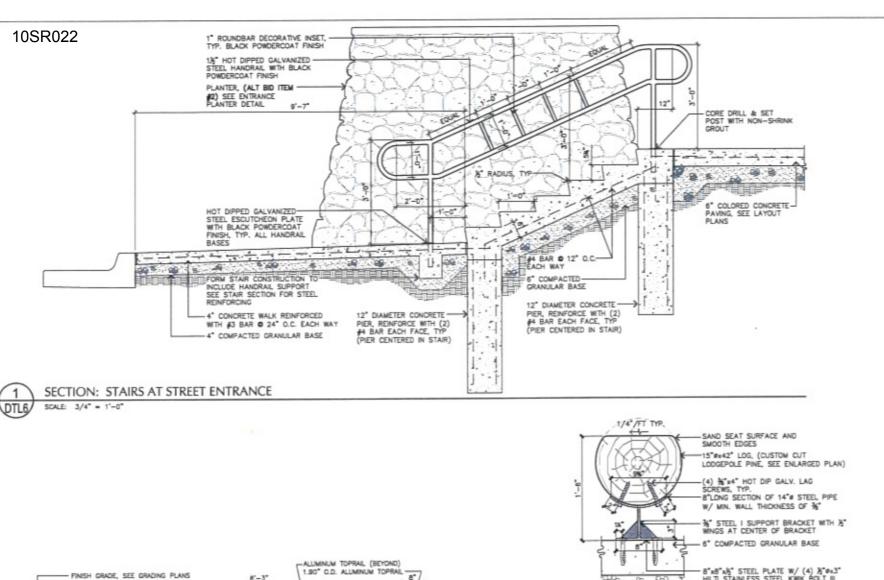A" PER FT



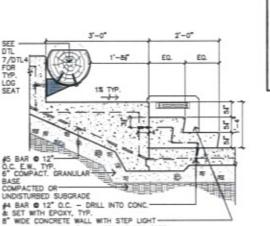

1'-118"

1.90° O.D. ALIMINIM TOPRAL (SEE MAN ON DIL 3/DILE FOR FURTHER COORD.) #5x8° BAR © 24° OC HORIZ AND 12° DC VERT. DRILL NITO CONCRETE AND SET WITH EPDRY GROUT \*\*\_n\*\*

ALONG STAIR WITH 1" CHAMFER AT TOP (SEE

B" CONCRETE

WATERSTOP

RETAINING WALL (SEE GRADING PLANS FOR TOP OF WALL ELEV)

UNDISTURBED SOLS -

6" COMPACTED GRANULAR BASE-

SCALE: 3/4" = 1'-0".

CONCRETE FOOTER-

2x2 KEYWAY #5 BAR 0 12" O.C.

6

(BEYOND)

#4 BAR @ 12" O.C. EACH WAY

HANDICAR COMPANION LOG SEAT (48°

LONG) SEE DTL 4/DTL6 FOR FURTHER

SCALE: 3/4" = 1'-0"

SECTION: STAIR SECTION

7/DT FOR TYP. LOG SEAT

FLECTRICAL)

CITY OF RAPID CITY GROWTH MANAGEMENT DEPT

Раго на положе то должно согтотната или адгиства должности адриства. Водасти и выпри отказ и остружения делами. В соверу отказ и остружения делами и остружения делами от от объери, и остружения от остружения о

3'-10%

SECTION: RETAINING WALL AT HANDICAP SEATING

#4 BAR @ 12" D.C. EACH WAY

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Inc.

MDE / PHW CMW / AKW Design Date: FEB, 2010 02-25-10 05113.2 Surveyed By: Survey Date FMG, Inc. AUG, 2009

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ART MARKET **WOWWO** 

SITE DETAILS

DTL6 = 32

FINISH GRADE, SEE GRADING PLANS

-8" CONCRETE RETAINING WALL (SEE GRADING PLANS FOR TOP AND BOTTOM OF

WALL ELEV)

HYDROTITE PAINTILE, TO DAYLIGHT UNDISTURBED SOILS

FREE DRAINING CLEAN ROCK — GREENSTREAK

-CONCRETE FOOTER

-2x2 KEYWAY #5 BAR 0 12" O.C.

-6" COMPACTED GRANULAR BASE

SCALE: 3/4" = 1'-0"

GREENSTREAK H

WATERSTOR

2×2 KEYWAY

#5 BAR 0 12" O.C.

UNDISTURBED SOILS

6" COMPACTED GRANULAR BASE

6" THICK COLORED CONCRETE WITH #4 BAR #12" O.C. EACH WAY OVER 6" COMPACTED GRANULAR BASE (SEE SHEET L1 FOR COLDRED CONCRETE MIX) SECTION: RETAINING WALL / GUARDRAIL AT HANDICAP SEATING

/2" CLEAR TEMPERED GLASS

STRUCTURAL GROUT (10,000 PSI.-NON-SHRINK,

BEYOND (MITER CORNERS TO FIT)

%" CONC ANCHOR (WEDGE BOLT TYPE) W/ MIN. EMBED OF 3%" INTO CONCRETE. B" C.C. (MAX)

8" CONCRETE WALL (5,000 PSI). SEE GRADING PLANS TO FOR TOP AND BOTTOM OF WALL ELEVATIONS

#4 BAR @ 12" O.C. EACH WAY

ORFENSTREAK HYDROTITE 4

9. 8

6" TALL CONCRETE CURB -

9 - 6 9

2x4 ALUMINUM BASE SHOE

NON-METALLIC)

GLASS VINTL

SECTION: LIMESTONE BOULDER GRAVITY WALL

SCALE: 3/4" = 1'-0"


SECTION: RETAINING WALL AT HANDICAP SEATING

SCALE: 3/4" = 1'-0"


1 NORTH ELEVATION: STONE & PANEL BASE DTL7 SCALE: 1/2" = 1'-0"

SCALE: 1/2" = 1'-0"

ALTERNATE BID ITEM #3

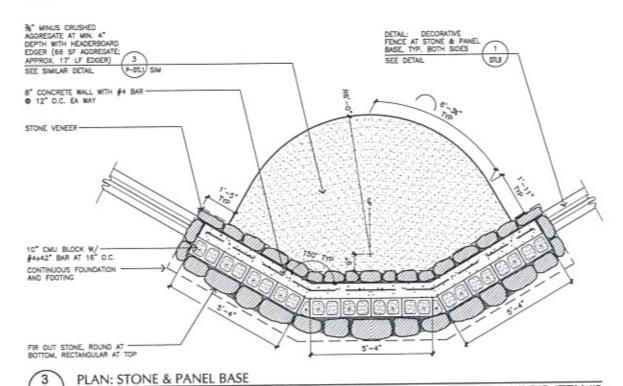


ALTERNATE BID ITEM #3

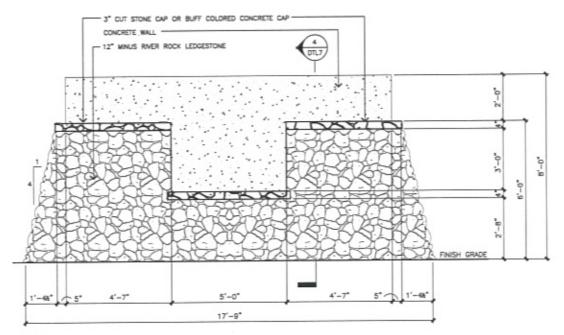

SOUTH ELEVATION: STONE & PANEL BASE

ALTERNATE BID ITEM #3

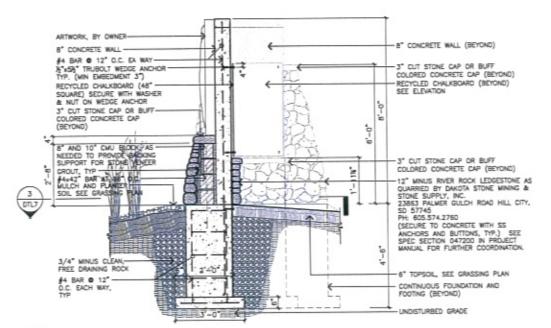

4 SECTION: STONE & PANEL BASE

ALTERNATE BID ITEM #3

#### CITY OF RAPID CITY GROWTH MANAGEMENT DEPT. DEVELOPMENT SERVICES

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FMG, Inc. AUG, 2009
Revisions

and, the proof cover


POWWOW GARDENS & ART MARKET


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Sheet Title:

SITE DETAILS

u= DTL7 ≠ 32



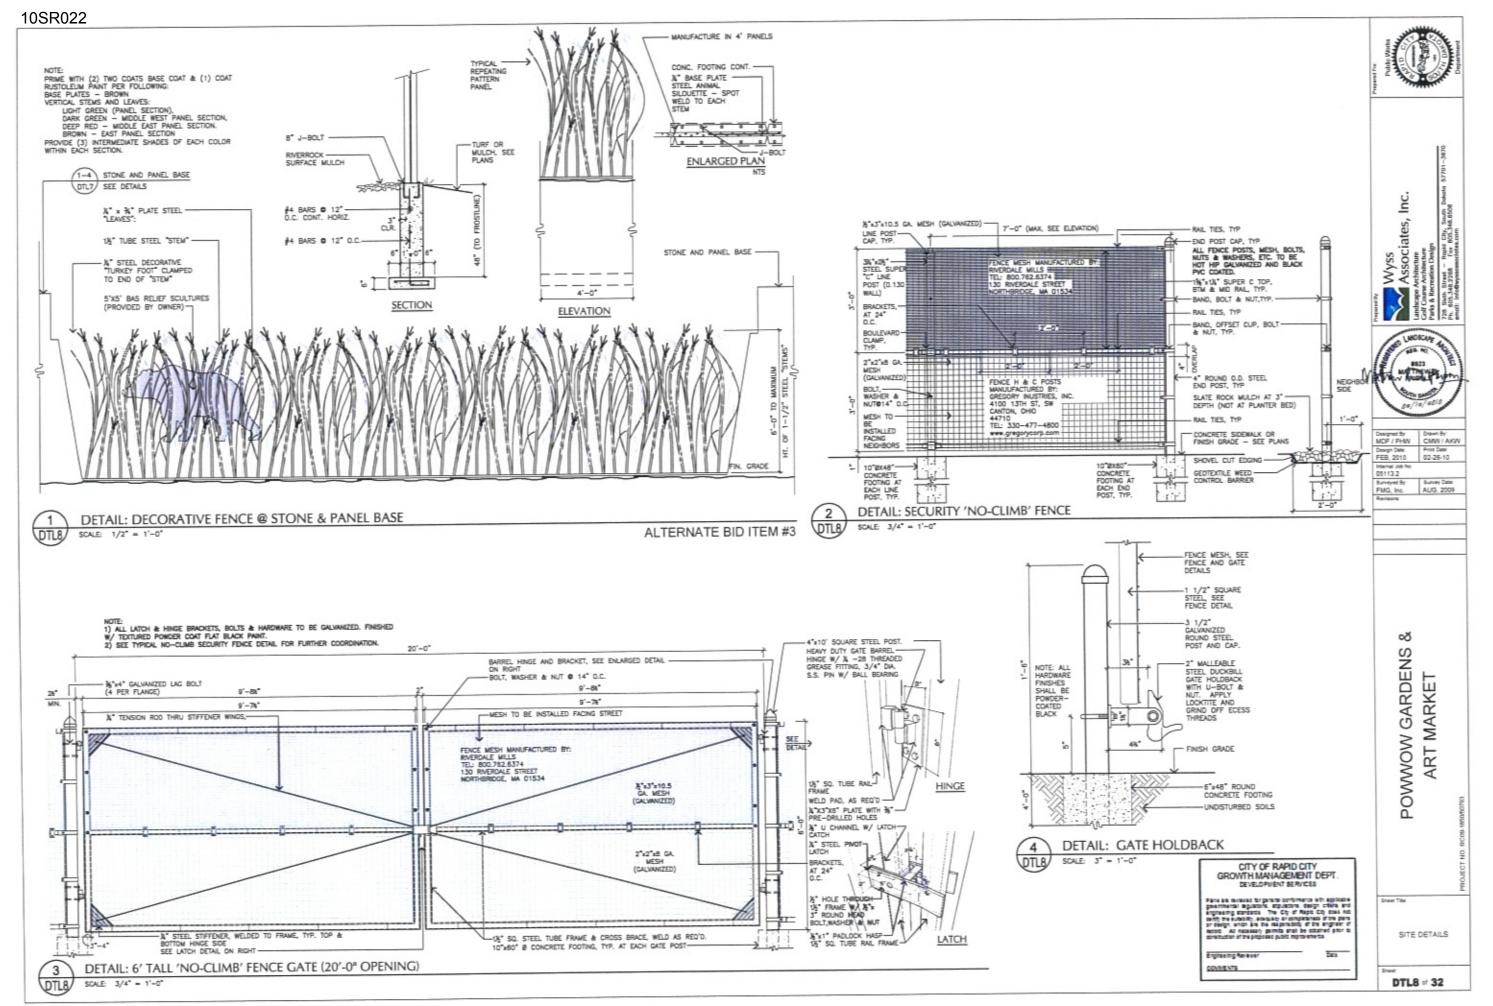

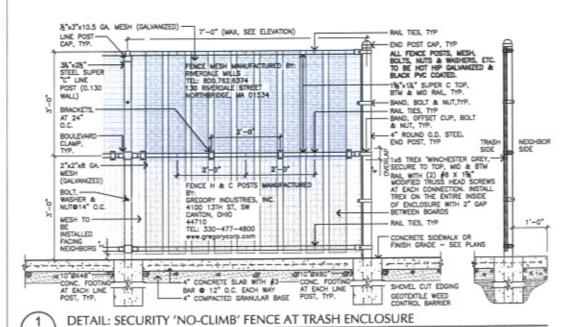4" CONCRETE 1/4" FLEXIBLE FOAM FOAM ISOLATION JOINT BY W.R. MEADOWS — OR APPROVED EDUAL. FINISH WITH 3/8" TOOLED EDGE. INSTALL JOINT AROUND PERIMETER OF BOULDER. WALK, AS SPECIFIED. OUTDOOR TURF AS SPECIFIED. -LOCALLY AVAILABLE BOULDERS SUBMIT PHOTOGRAPHS OF TYPICAL BOULDERS FOR REVIEW BY LANDSCAPE ARCHITECT. COMPACTED SUBGRADE NOTES:

1.) BURY BOULDER ‡ TO ‡ INTO FINISH GRADE.


2.) REFER TO PLAN AND SPECIFICATIONS FOR INFORMATION ON ROCK SIZES AND LOCATIONS.

3.) ROCKS SHALL NOT BE DUMPED OR DOZED IN TO PLACE BUT BE SET BY CRANE OR SIMILAR MECHANISM, UTILIZING SLINGS OR TONGS. CARE SHOULD BE TAKEN NOT TO DAMAGE DIFFOSED SURFACES OF STONES. DAMAGED SURFACES SHALL BE REPAIRED AS APPRIOVED BY THE OWNER'S REPRESENTATIVE.

SECTION: BOULDER PLACEMENT IN CONCRETE

SCALE: 1" = 1'-0"

DETAILS/SECTIONS: MAIN PEDESTRIAN AND OVERFLOW GATE

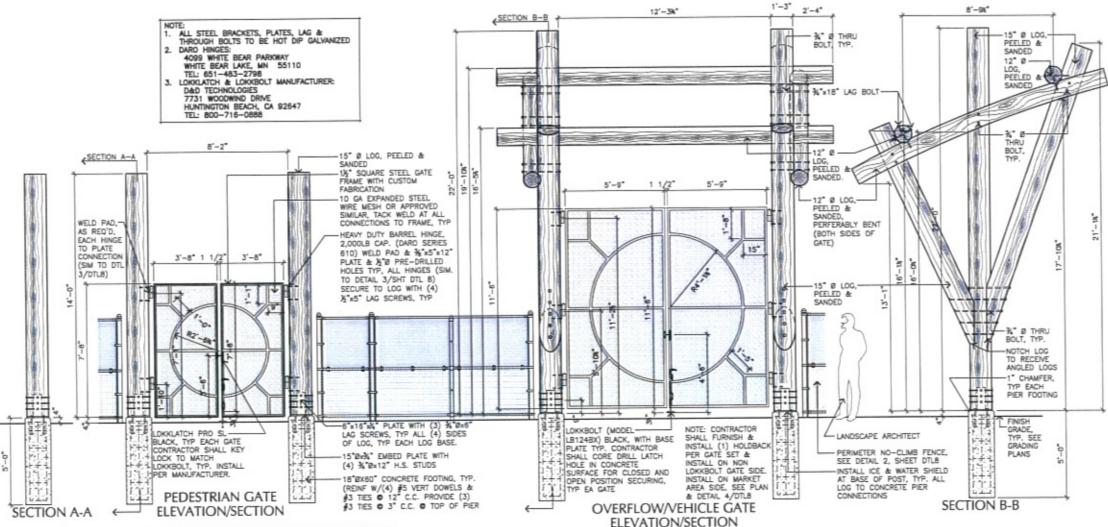

CITY OF RAPID CITY GROWTH MANAGEMENT DEPT DEVELOPMENT SERVICES

Рато в д поченей до дажно доготнатал и до догодо доветности додення, егралить, егралить довет и образовать и

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MDF / PHW CMW / AKW FEB. 2010 02-26-10 05113.2 Surveyed By: Survey Date: FMG, Inc. AUG, 2009

> ∞ POWWOW GARDENS ART MARKE

SITE DETAILS

DTL9 at 32

SCALE: 3/8" = 1'-0"

SCALE: 3/4" = 1'-0"

ELEVATION / SECTION: TYPICAL SIGNAGE DETAIL

SCALE: 3/4" = 1'-0"

STEEL, SLAT WASTE CONTAINER WITH CONCRETE BASE, ITEM NUMBER WS-302, OR APPROVED EQUAL, PAINTED COLOR "S3". (31 GAL. PLASTIC TRASH LINER INCLUDED WITH GAL PLASTIC TRASH LINER INCLIDED WITH EACH LINIT.) MANUFACTURED BY:
MALSAU TILE INC.
PO BOX 1520 WALSAU, WI 54402-1520
9001 BUS. HBY 51 ROTHSCHILD, WI 54474
PHONE: (715) 359-3121
TOLL FREE: (800) 388-8728
FAX: (715) 355-4827
GENERAL E-MAL: With@wousoudle.com
WEBSITE: www.wousoudle.com

SCALE: 3/4" = 1'-0"

CONTRACTOR SHALL INSTALL A 30"X30" SO, CONC. SLAB FOR ALL CONTAINERS LOCATED IN TURF AREAS, SEE PLANS FOR LOCATIONS.

 ADD RECYCLING PACKAGE TO STANDARD TRASH RECEPTACLE FOR RECYCLING RECEPTACLE. (4 W/ RECYCLING PACKAGE; 5 STANDARD)

ALTERNATE BID ITEM #5

PLAQUE SIZE AND HOLE PLACEMENT-MAY VARY BETWEEN RECEPTACLES. CONTACT MANUFACTURER FOR DETALS. 🧱 Recycle 📆  $5/8^{\circ}$  DIA, STEEL RING, WELD PLATES TO RING AT INTERIOR SIDE

2'-ON" -TYPICAL ALUM, TRASH CAN TOP STEEL TRASH CAN PANEL 'A' -STEEL TRASH CAN STEEL TRASH CAN PANEL 'A' PANEL 'B' 1"-54" MODIFIED 31 GAL. PLASTIC TRASH LINER -MAINTAIN 1" GAP BETWEEN PANELS, TYP. -1" WIDE 11 GA. STRAP RING AT INTERIOR OF TRASH CAN, WELD EVERY PANEL TO RING, TYP. 3/8" DIA. STAINLESS STEEL CAP BOLT FASTENING STEEL PANEL "A" TO CONCRETE BASE AT REVEALS, AS INDICATED

TYPICAL CONCRETE BASE TYPE "C", BY MANUFACTURER ATTACH WASTE CONTAINER CONC. BASE TO CONC. SLAB PER MANUFACTURER'S RECOMMENDATIONS, SEE NOTES STEEL SLAT RECEPTACLE WITH CONCRETE BASE

-SUPPORT LEG SUPPORT LEG -SUPPORT LEG-

% "B HOLE-1"-8%" -1°2 STL BAR **BOLTING DETAIL** 

NOTES:

1. ALL STL. MEMBERS COATED W/ ZINC RICH EPOXY THEN FINISHED W/
POLYSTIER POWDER COATING (SEE COLOR OPTIONS).

2. ½": 3½" PLTD. EXPANSION ANCHOR BOLTS PROVIDED

3. BENCH IS SHEPPED LIMISEDMELED.

4. BENCH ITEM #62-24-80/3-2. OR APPROVED EQUAL, SUPPLIED BY:
DUNCR, INC., OR APPROVED EQUAL
P.D. BOX 142 MEFELNITOWN, PA 17059-0142
PHONE: BOO-598-4018

CIRCULAR BENCH QTL19 SCALE: 3/4" = 1'-0"

II HUNTER GREEN

S DEEP RED

□ GREEN

<u>6 TOTAL BENCHES:</u>
ALTERNATE DEEP RED AND BLACK COLDR BENCH IN PLAZA AREA — SEE PLANS

COLOR OPTIONS:

E BLACK

□ BLUE

☐ OTHER


□ BRONZE

ALTERNATE BID ITEM #5

CITY OF RAPID CITY GROWTH MANAGEMENT DEPT. DEVELOPMENT SERVICES

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Des Engineerig fan east COMMENTS

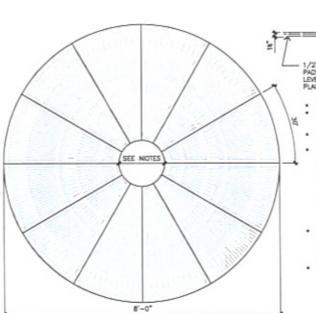

1/2" x 1" x 1/4" THICK GRINDING PADS FOR LEVELING - TYP. 4 OR MORE PLACES.

NOTES: TREE GRATE #M9601-1 STYLE: STARBURST SERIES 1, OR APPROVED EQUAL

. GRATE SUPPLIED IN 12 SECTIONS.

SLOT WIDTH IS 1/4" MAXIMUM, MEETS ADA COMPLIANCE GRATE CAST FROM GRAY IRON TREE OPENING SIZE 15, 18", OR 28" STEEL ANGLE FRAME REQUIRED FOR INSTALLATION USE MODEL M9601F OUTER FRAME DIM. IS 3/4" ± 1/8" GREATER THAN GRATE.

. SUPPLIED BY, OR APPROVED EQUAL: RONSWITH 41-701 CORPORATE WAY, #3 PALM DESERT, CA 92260 1.800.338.4756

**ROUND TREE GRATE 8' DIAMETER** 

SCALE: 3/4" = 1'-0"

∞ŏ POWWOW GARDENS **ART MARKET** 

Inc.

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Designed By Drawn By MDF / PHW CMW / AKW

Surveyed By: Survey Date: FMG, Inc. AUG, 2009


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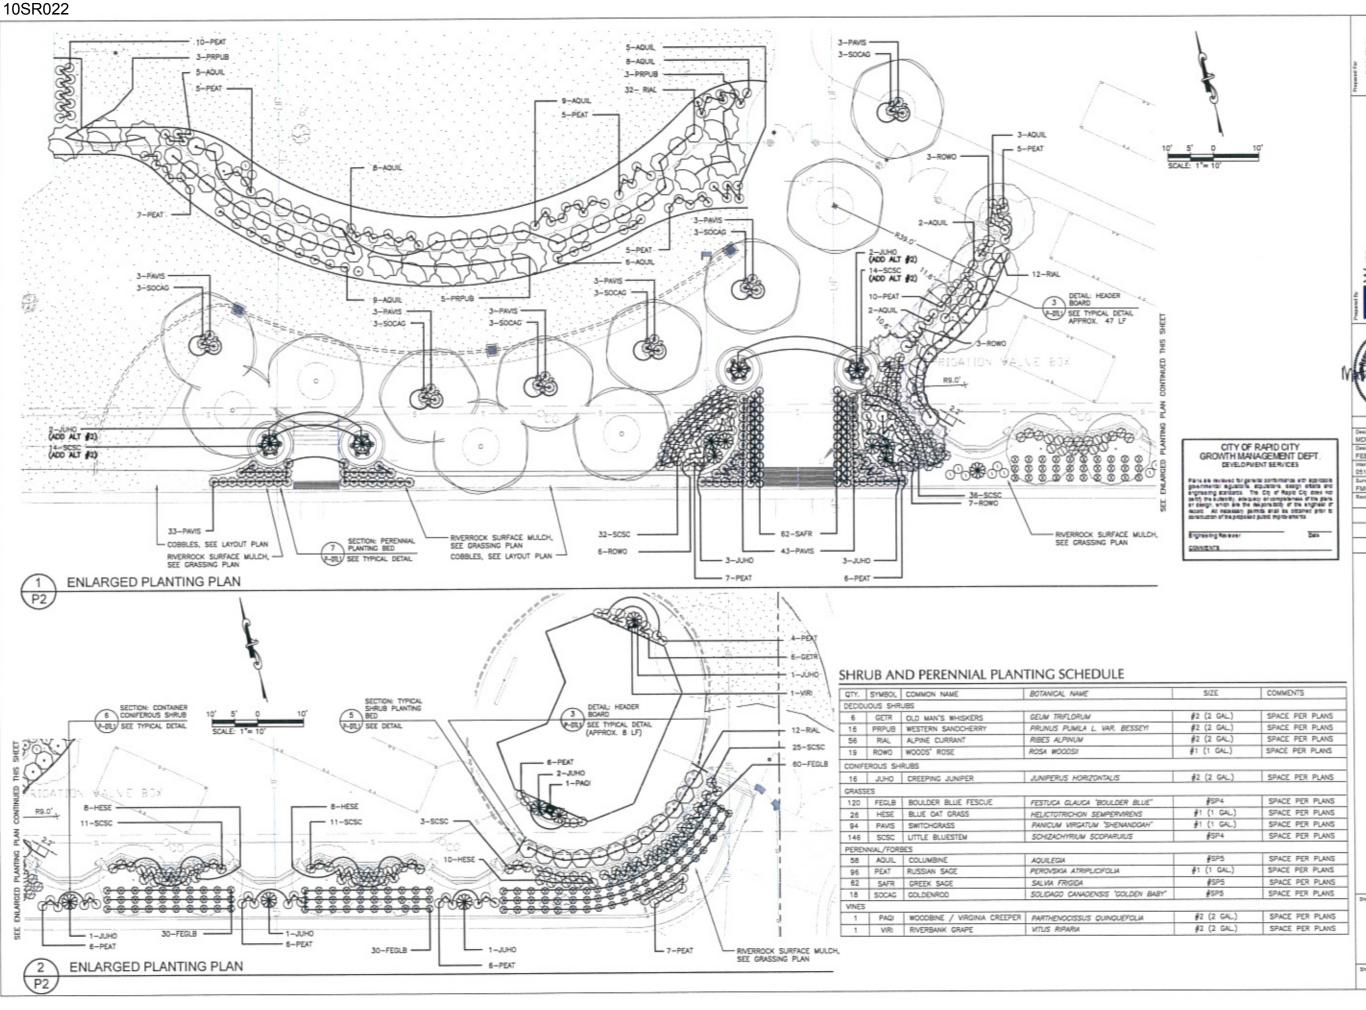
Design Date: FEB, 2010

05113.2

SITE DETAILS

DTL10 of 32



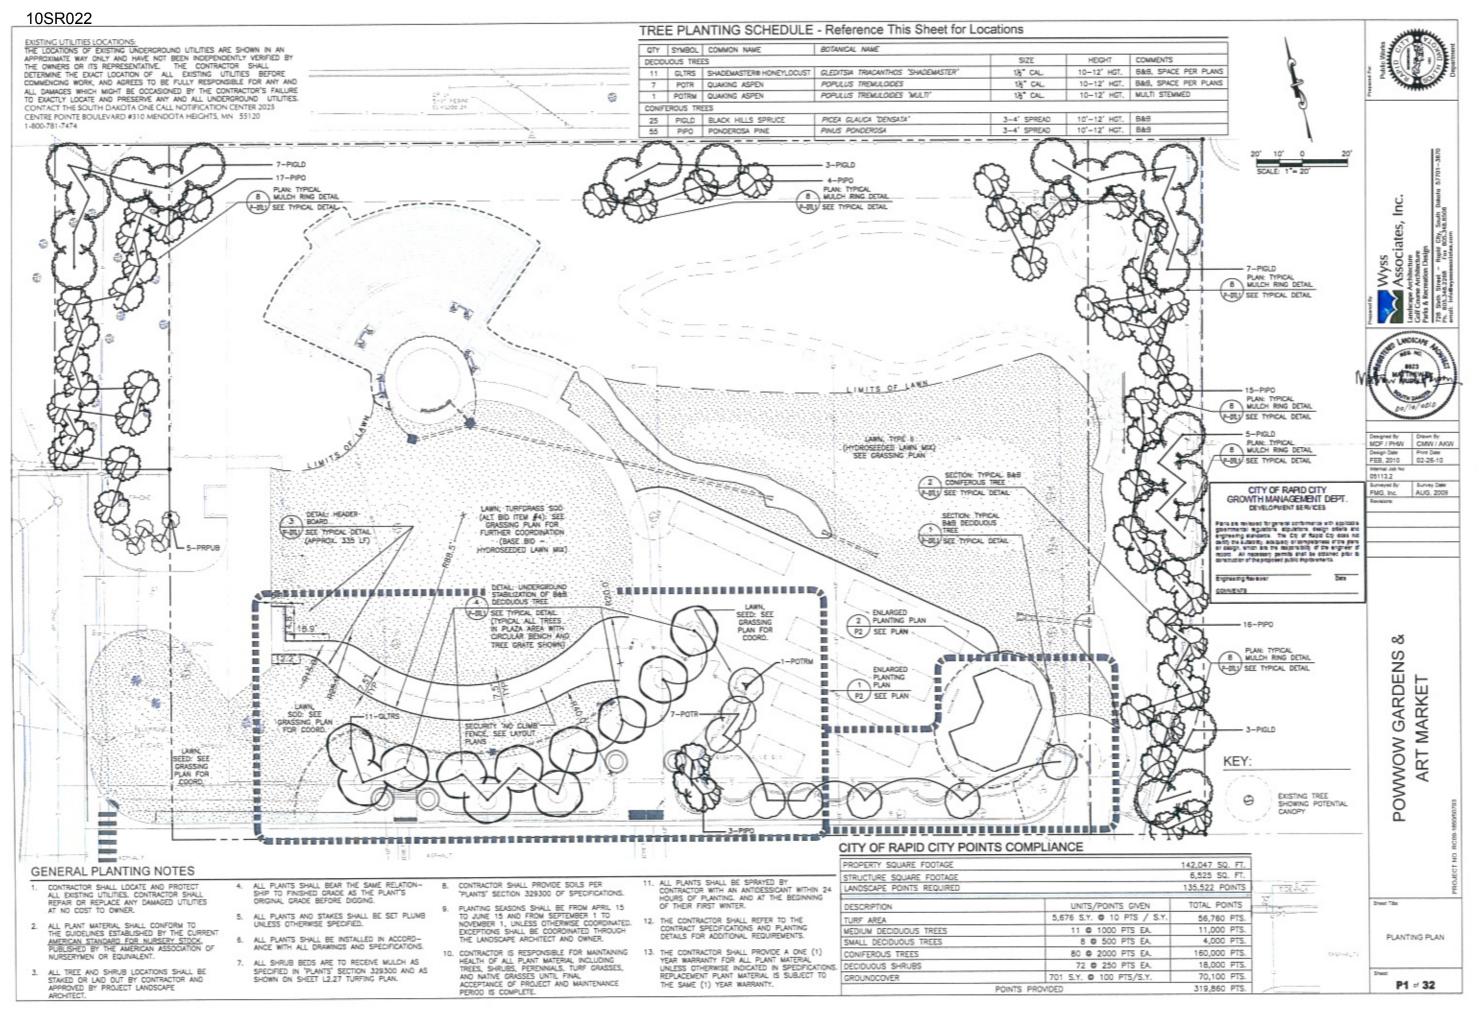







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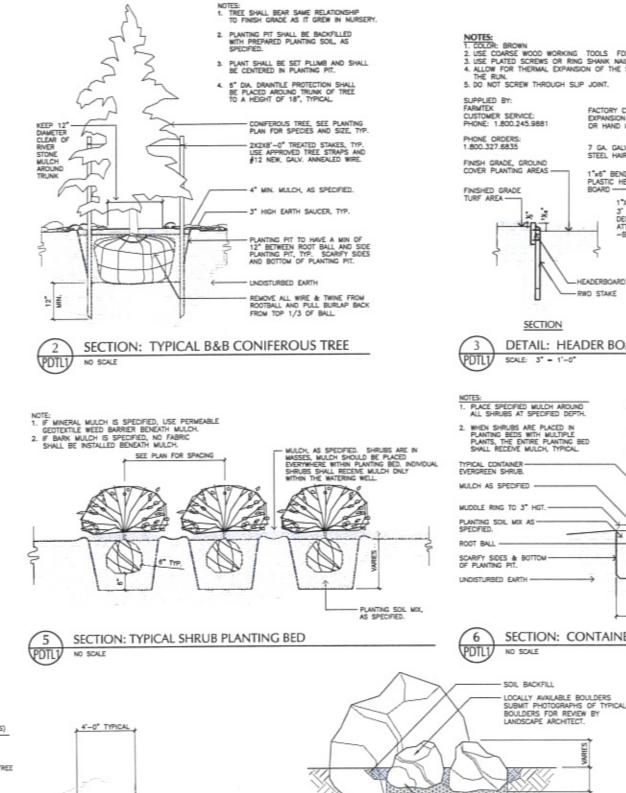
∞ŏ POWWOW GARDENS ART MARKET


ENLARGED PLANTING PLAN

P2 of 32




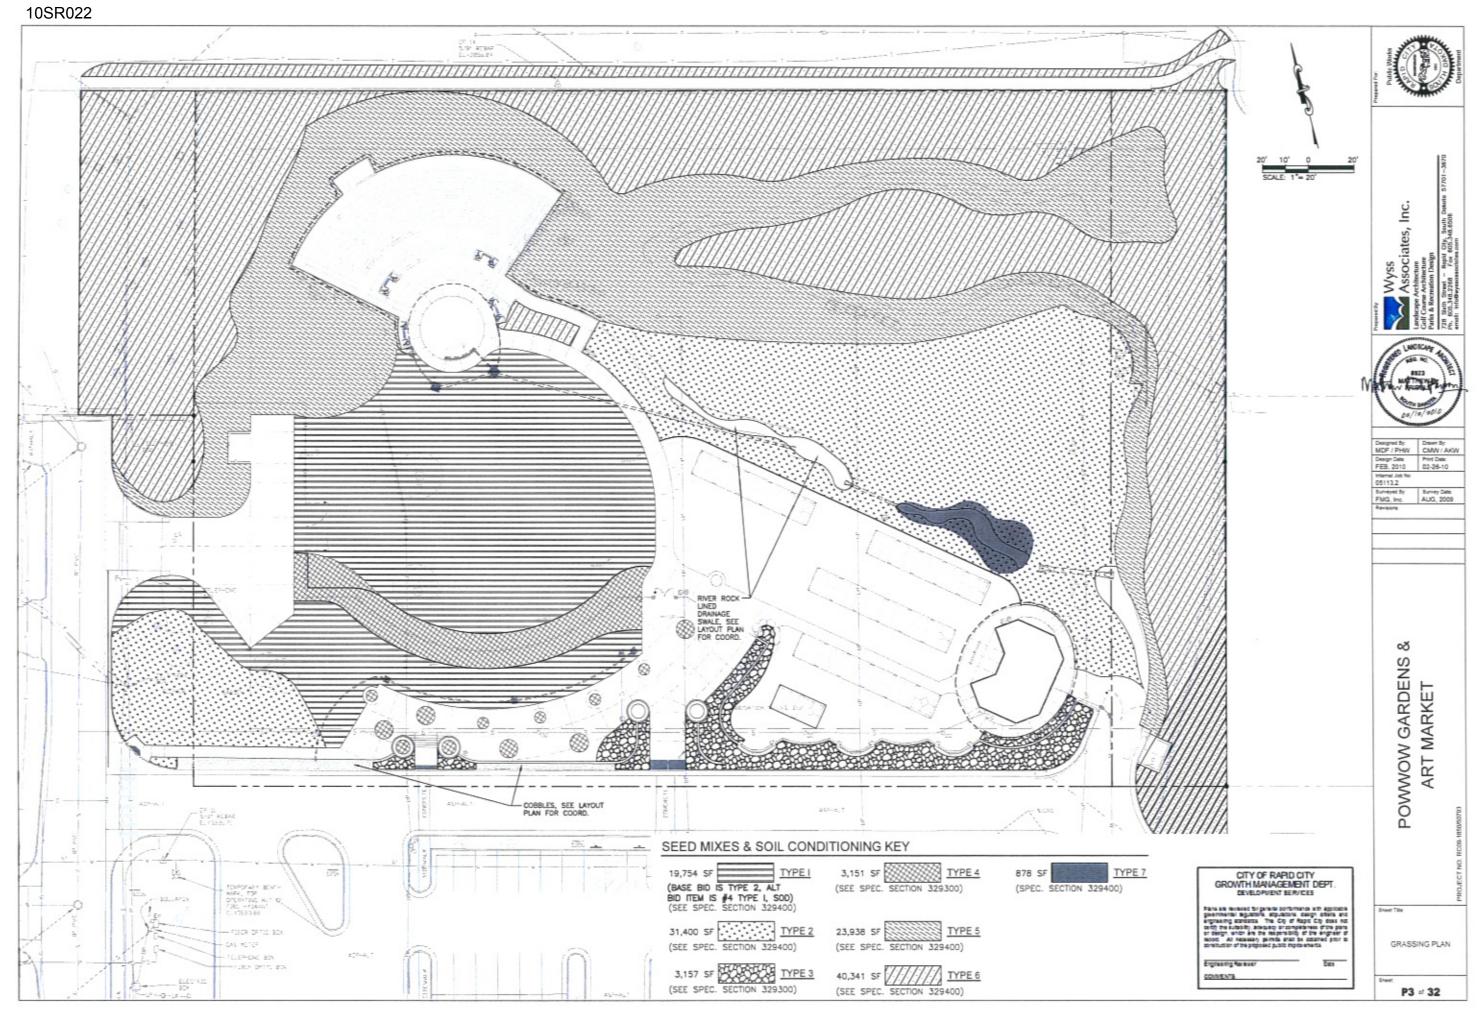

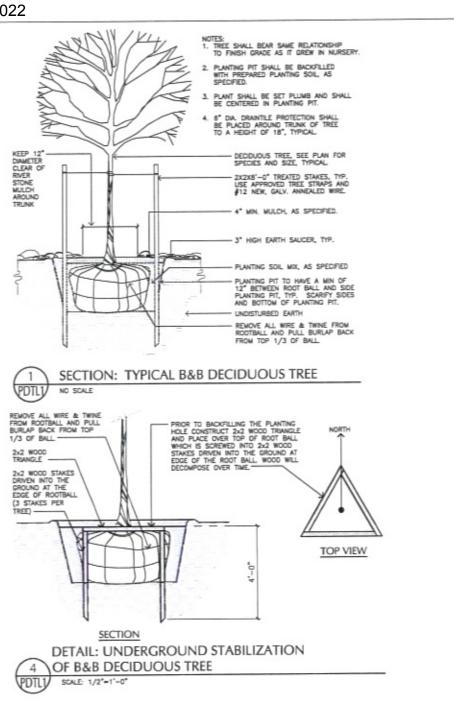


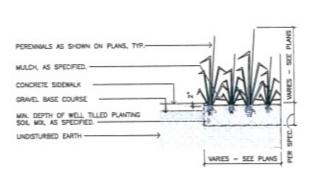

SECTION: PERENNIAL PLANTING BED DETAIL SCALE: 1/2" = 1'-0"

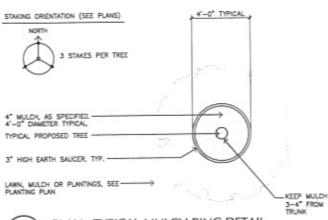

PLAN: TYPICAL MULCH RING DETAIL SCALE 1/4" = 1'-0"

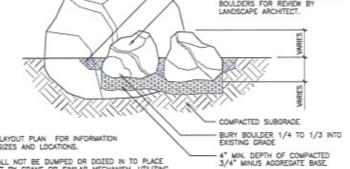

NOTES: REFER TO LAYOUT PLAN FOR INFORMATION ON ROCK SIZES AND LOCATIONS.


ROCKS SHALL NOT BE DUMPED OR DOZED IN TO PLACE BUT BE SET BY CRANE OR SIMILAR MECHANISM, UTILIZING SUNGS OR TONGS. CARE SHOULD BE TAKEN NOT TO DAMAGE EXPOSED SURFACES OF STONES. DAMAGED SURFACES SHALL BE REPAIRED AS APPROVED BY THE OWNER'S REPRESENTATIVE.

LANDSCAPE BOULDER PLACEMENT SCALE: 1" = 1'-0"

2 USE COARSE WOOD WORKING TOOLS FOR CLITTING AND DRILLING.

2. USE PLATED SCREWS OR RING SHANK NAILS TO JOIN BOARDS.

4. ALLOW FOR THERMAL EXPANSION OF THE SLIP BY LEAVING GAPS IN JOINTS OR AT THE END OF THE RUN.

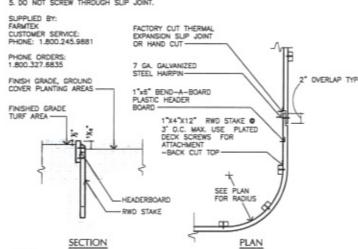

DETAIL: HEADER BOARD

 SHRUB PIT SHALL COMPLY WITH WIDTHS AND DEPTHS AS FOUND IN SPECIFICATIONS. IF MINERAL MULCH IS SPECIFIED, USE GEOTEXTILE WEED BARRIER BENEATH MULCH. IF BARK MULCH IS SPECIFIED, NO FABRIC SHALL BE INSTALLED BENEATH MULCH. MULCH CLEAR OF

SECTION: CONTAINER CONIFEROUS SHRUB

VARIES -- SEE SPECS.



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Wyss Associates, I


MDF / PHW CMW / AKW FEB. 2010 02-26-10 05113.2 Surveyed By

8923

FMG, Inc. AUG. 2009

∞ŏ POWWOW GARDENS RT MARKE


PLANTING DETAILS

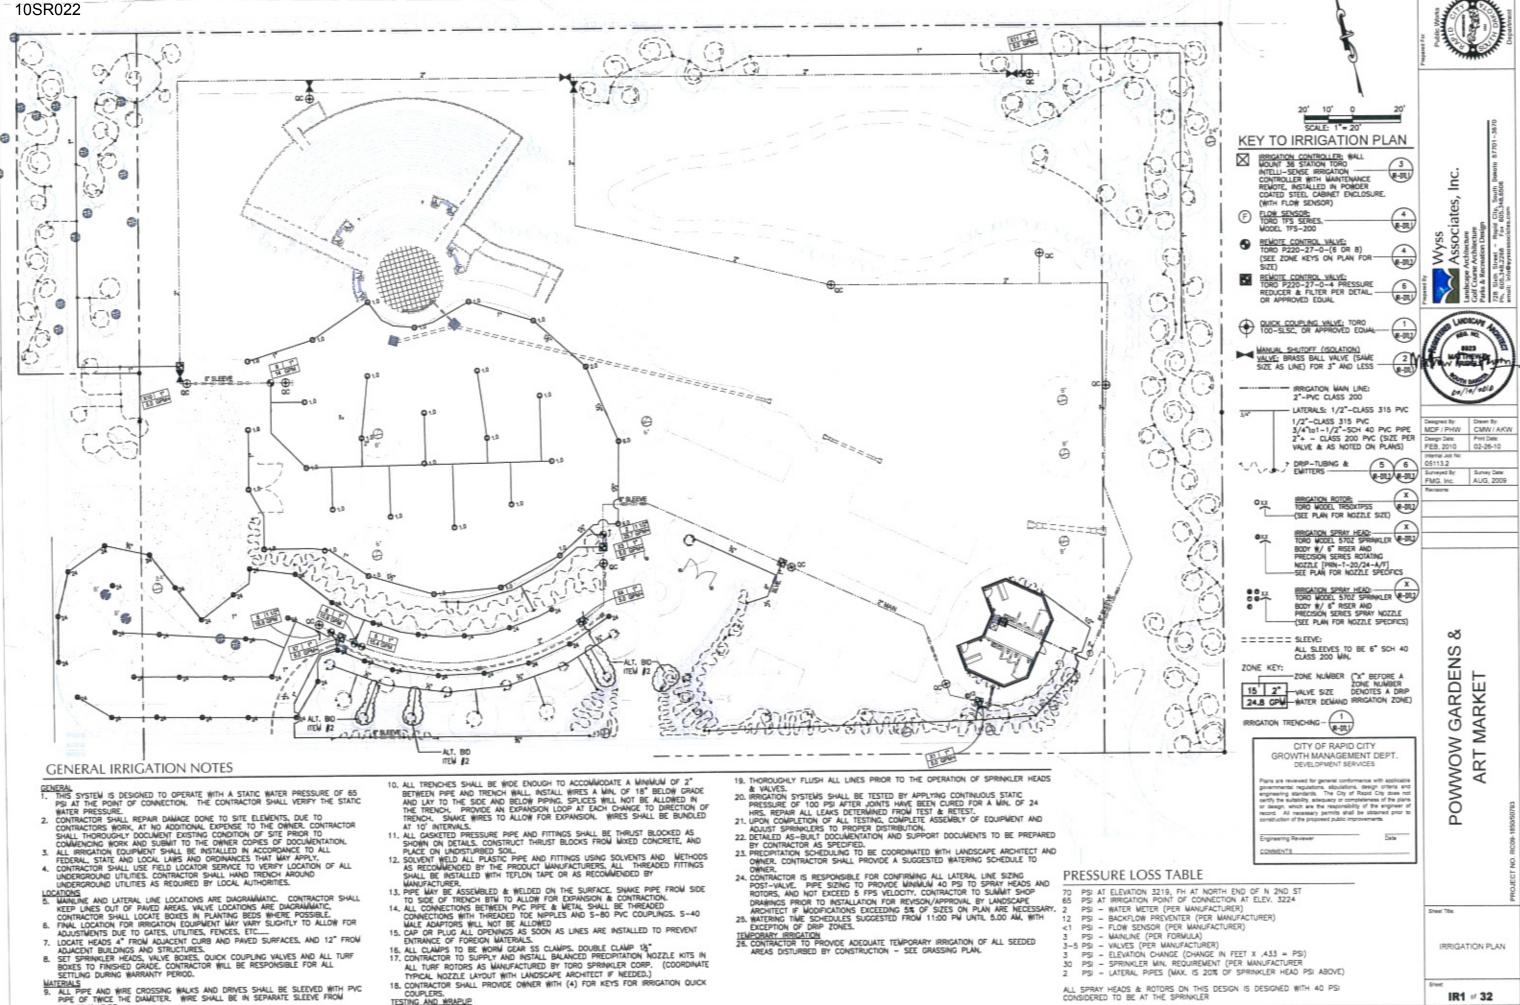

COUPLERS.

TESTING AND WRAPUP

IR1 of 32

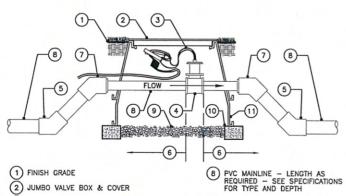

- 1) FINISH GRADE
- 2 JUMBO VALVE BOX & COVER
- 3 CONTROL WIRES WITH 12" MIN. SERVICE COIL AND WATERPROOF WIRE SPLICE CONNECTORS WIRE COLORS PER SPECIFICATIONS
- (4) FLOW SENSOR PER SPECIFICATIONS
- (5) PVC 45 DEGREE ELL (TYP.)
- 6 MINIMUM 10x PIPE DIAMETER UPSTREAM & MINIMUM 5x PIPE DIAMETER DOWNSTREAM OF STRAIGHT PIPE
- 7) PVC 45 DEGREE ELL (TYP.) BUSH DOWN TO FLOW METER SIZE AS NECESSARY
- NOTES:
  1. INSTALLATION TO BE COMPLETED IN ACCORDANCE WITH MANUFACTURERS SPECIFICATIONS.
  2. DO NOT SCALE DRAWINGS.




SCALE: NOT TO SCALE

(9) GRAVEL (1 CU. FT.)

(10) CONTINUOUS BRICK SUPPORTS 11) VALVE BOX EXTENSIONS AS REQUIRED


SEE PLANS, LEGEND AND SPECIFICATIONS FOR ADDITIONAL INSTALLATION NOTES.

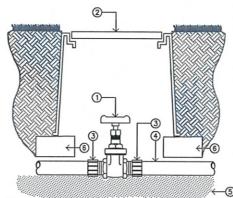


(1) BALL VALVE AS SPECIFIED
(2) 10" ROUND PLASTIC VALVE BOX AND LID
(3) MALE ADAPTER
(4) MAINLINE PIPE
(5) 2 C.F. DRAIN ROCK SUMP (3/4" WASHED)
(6) 1 0F 2 BRICKS SET PARALEL TO LINE (NOT 1 OF 2 BRICKS SET PARALEL TO LINE (NOT ABOVE PIPE)




ISOLATION VALVE DETAIL

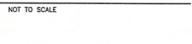

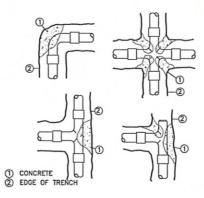

MAINLINE 2" AND LARGER

NOT TO SCALE

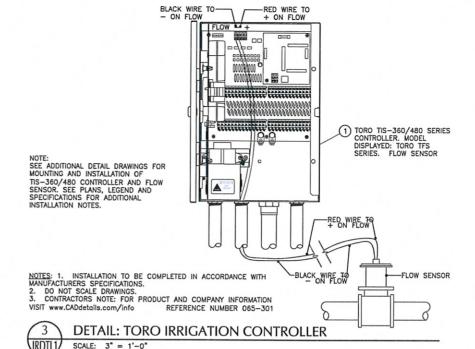

FINISH GRADE.
CONTROL WIRES WITH 36" SERVICE COIL AND WATER PROOF WIRE CONNECTIONS, DBY OR EQUAL
RECTANGULAR PLASTIC VALVE BOX. HEAT BRAND STATION NUMBER ON LID IN 2" HIGH CHARACTERS.

PVC MAINLINE PER SPECIFICATIONS (LENGTH AS REQUIRED).


SCH 40 PVC ELL (SxS)

NATIVE SOIL PER SPECIFICATIONS.
CONTROL WIRES TO CONTROLLER.
PVC MAINLINE FITTING.
TORO EZF-26-04 INLINE VALVE (\*).

TORO 150 MESH Y-FILTER (\*).
TORO 25 PSI LOW FLOW PRESSURE REGULATOR (\*).

SCH 40 PVC MALE ADAPTER SCH 40 PVC BALL VALVE (\*). SCH 80 PVC CLOSE NIPPLE (\*).

PEA GRAVEL SUMP, MINIMUM 6" DEEP

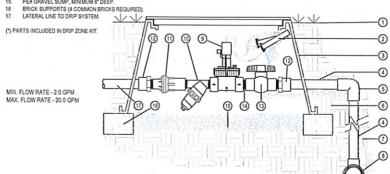

DETAIL: DRIP IRRIGATION CONTROL VALVE

NOT TO SCALE

CITY OF RAPID CITY GROWTH MANAGEMENT DEPT DEVELOPMENT SERVICES

Pans are reviewed for general confirmance with applicable governmental regulations, situations, cetting criteria and exphaneing standards. The Cop of Apac City, one and cetting the sustailing, accounting the sustailing, accounting on comparables of the pans of design, and has the resignate of memory of the pansage of personal and the control of the pansage of the

Engineering Reviewer COMMENTS

IR-DTL1of 32

Associates, Inc.

UNDSCLOP 8923 MATTHEWAR V ARIDEL

Designed By: MDF / PHW Drawn By: CMW / AKW Design Date: FEB, 2010 Print Date: 02-26-10 05113.2 FMG, Inc. AUG, 2009

∞ŏ GARDENS **ART MARKET** POWWOW

sheet Title

IRRIGATION DETAILS


**DETAIL: QUICK COUPLING VALVE** SCALE: 3"=1'-0"

FINISH GRADE TORO ANGLE REMOTE CONTROL VALVE WITH FLOW CONTROL MODEL # P220, PER PLAN PVC MAIN LINE -CONTROL WIRES WITH 12" MIN. CONTROL SERVICE SOIL AND WATERPROOF WIRE SPLICE CONNECTORS. PVC ELBOW · PVC LATERAL IRRIGATION LINE PVC MALE ADAPTER VALVE BOX EXTENSION, WHEN NEEDED CONTINUOUS BRICK SUPPORTS GRAVEL (1 CUBIC FOOT) SCH 40 PVC TEE OR ELBOW IRRIGATION MAIN LINE

SECTION: TORO PLASTIC VALVE P-220 SERIES (ELECTRIC)

SCALE: 1 1/2" = 1'-0"

VRDTL2

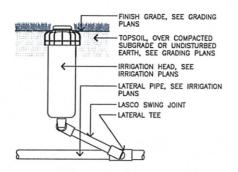

**DETAIL: TORO TR50XT TURF ROTOR** VRDTL2 SCALE: 3" = 1'-0"

SCALE: 1" = 1'-0"

NOZZLE, SEE IRRIGATION LEGEND AND PLAN FOR TYPE AND SIZE SCHAND STEERING IN FINISH GRADE, SEE GRADING PLANS - TOPSOIL, OVER COMPACTED SUBGRADE OR UNDISTURBED EARTH, SEE GRADING PLANS TORO 570Z-6P SPRINKLER BODY (6" POP-UP), SEE IRRIGATION PLANS LATERAL PIPE, SEE Ш -LATERAL TEE -LASCO SWING JOINT

DETAIL: TORO 570Z 6" RISER SCALE: 3" = 1'-0"

TORO BLUE STRIPE DISTRIBUTION HOSE PLANTS, SMALLER THAN 2-GALLONS: (1) EMITTER PER PLANT TIE DOWN STAKE: IPS1500 — SECURE HOSE TO FINISHED GRADE AS REQ'D. (10' SINGLE OUTLET EMITTER: TURBO-SC PLUS (0.5 GPH FOR SHRUBS) ALL PLANTS 2 GAL AND LARGER, (2) EMITTERS PER PLANT. COMPRESSION TEE FITTING: TORO LOC-EZE FITTING PER SIZE TREE, SEE PLANTING PLANS - INSTALL (4) TURBO-SC PLUS EMITTERS PER TREE (1.0 GPH EA) PLACE EMITTERS AT EDGE OF ROOT BALL. TORO MICROLINE FLUSH VALVE (0.8 GPM) - CONNECTION TO LATERAL PVC PIPE PER MANUFACTURERS RECOMMENDATIONS SON THE ES -LATERAL PIPE, SEE PLAN FOR SIZE AND TYPE OF PIPE PLAN: TYPICAL MICRO IRRIGATION INSTALLATION LAYOUT

NOTES:

1. REFER TO LANDSCAPE SPECIFICATIONS FOR DETAILED INSTALLATION INSTRUCTIONS. FINISHED GRADE 1/2" XERI TUBING PER KEY COMPRESSION FITTING 1/2" TEE 1/2" RISER LATERAL PER PLAN

**DRIP TUBING CONNECTION** VRDTL2 NOT TO SCALE

> CITY OF RAPID CITY GROWTH MANAGEMENT DEPT. DEVELOPMENT SERVICES

MULCH

Pans are reviewed for general confirmance with applicable governmental applicable, structural, cestign criteria and emphasing standards. The Copy of Rayar City oces not carrily the suitable, adoptably processing for set of design, which as the esponsibility of the emphasis of design, which as the esponsibility of the emphasis of design with a time the control of the optable of the control of the proposed public maps carried.

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IR-DTL2 of 32

Inc.

Associates, 8923


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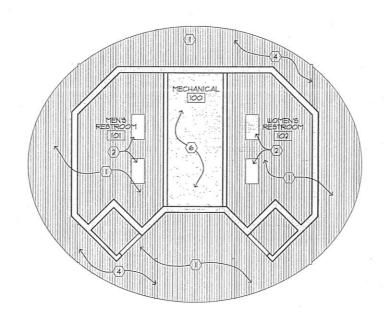
AUG, 2009


Internal Job N 05113.2 FMG, Inc.

> ∞ POWWOW GARDENS **ART MARKET**

IRRIGATION DETAILS




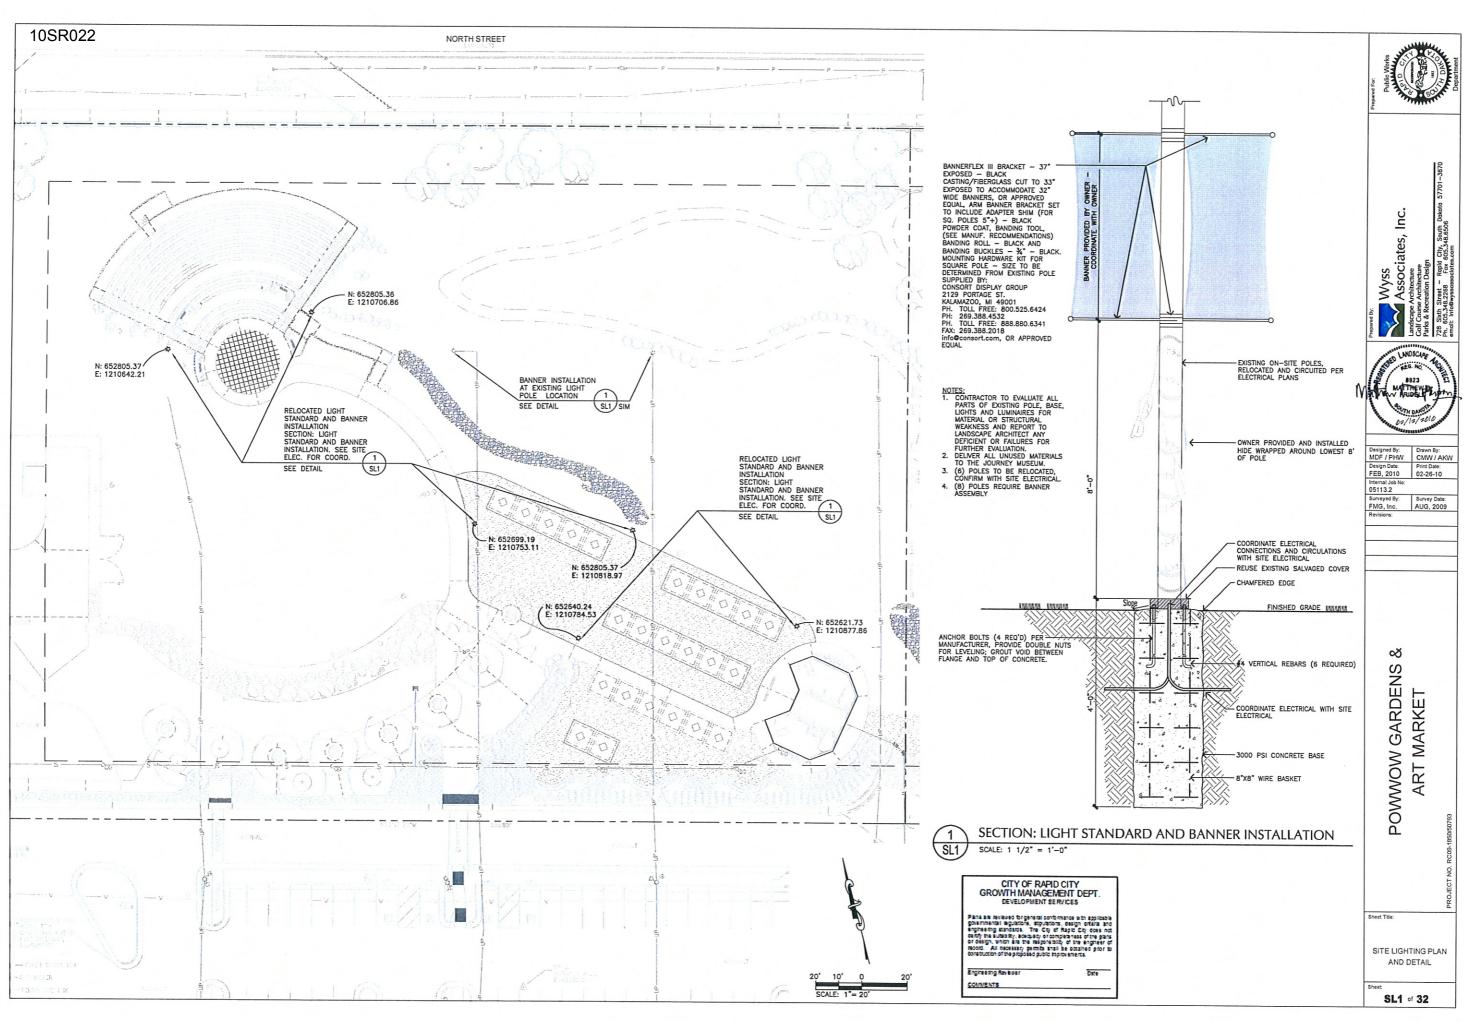

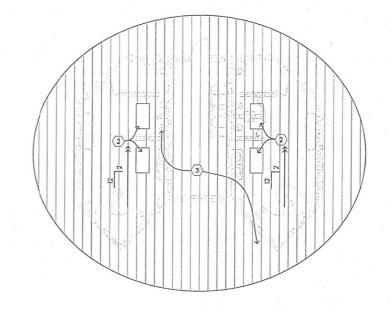





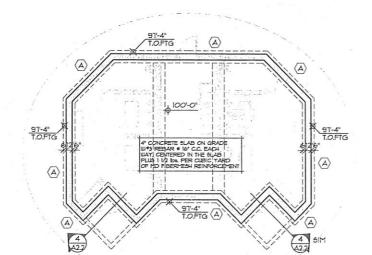

FOUNDATION PLAN

	FOOTING SCHEDULE						
MARK	SIZE W x L x D	REINFORCING					
(A)	2'-0" x CONTINUOUS x 1-0"	(3)45 CONTINUOUS (W/CORNERS)					

- TONGUE AND GROOVE DECKING
- 2 2'-2" x 4'-2" PRISMATIC SKYLIGHTS TYPICAL OF 4
- (3) METAL ROOF WITH 40 MIL I CF/WATER SHIELD UNDERLAYMENT.
- (4) GLU LAM STRUCTURE
- GUTTER/DOUNSPOUTS, PROVIDE DOUNSPOUTS AS REQUIRED. COORDINATE DOUNSPOUTS LOCATION WITH LANDSCAPE DRAINAGE PLAN
- (6) GYPBD CEILING ATTACHED TO STRUCTURE ABOVE

GENERAL NOTES:

- 1) COORDINATE LOCATION OF ALL MECHANICAL AND ELECTRICAL EQUIPMENT WITH MECHANICAL ELECTRICAL DRAWINGS
- STAIN AND SEAL ALL EXPOSED WOOD STRUCTURE AND DECKING. COLOR TO BE DETERMINED.






TYPICAL 8" CMU INTERIOR WALL

ALL INTERIOR WALLS ARE TYPE I UNLESS NOTED OTHERWISE. COORDINATE INTERIOR GLAZING/PAINTING OF BLOCK WITH INTERIOR ELEVATIONS AND FINISH SCHEDULE.




EXTERIOR WALL

8" SPLITFACE/BURNISHED BLOCK SYSTEM. SEE EXTERIOR ELEVATIONS FOR BLOCK

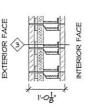

EXTERIOR/INTERIOR WALL

SPLITFACE/BURNISHED BLOCK SYSTEM. SEE EXTERIOR AND INTERIOR ELEVATIONS FOR BLOCK COURSING.

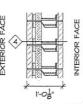

EXTERIOR/INTERIOR WALL

9PLITFACE/BURNISHED BLOCK 9YSTEM. EXTERIOR SPLITFACE/BURNISHED BLOCK WITH EXPOSED INTERIOR BLOCK. SEE EXTERIOR AND INTERIOR ELEVATIONS FOR BLOCK COURSING.



HITECTURE INTERNATIONAL 

Associates, Wyss

95% SUBMITTAL


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> ంర POWWOW GARDENS **ART MARKET**

Sheet Title:

1 of 3

BRINGING ARCHITECTURE TO YOUR WORLD



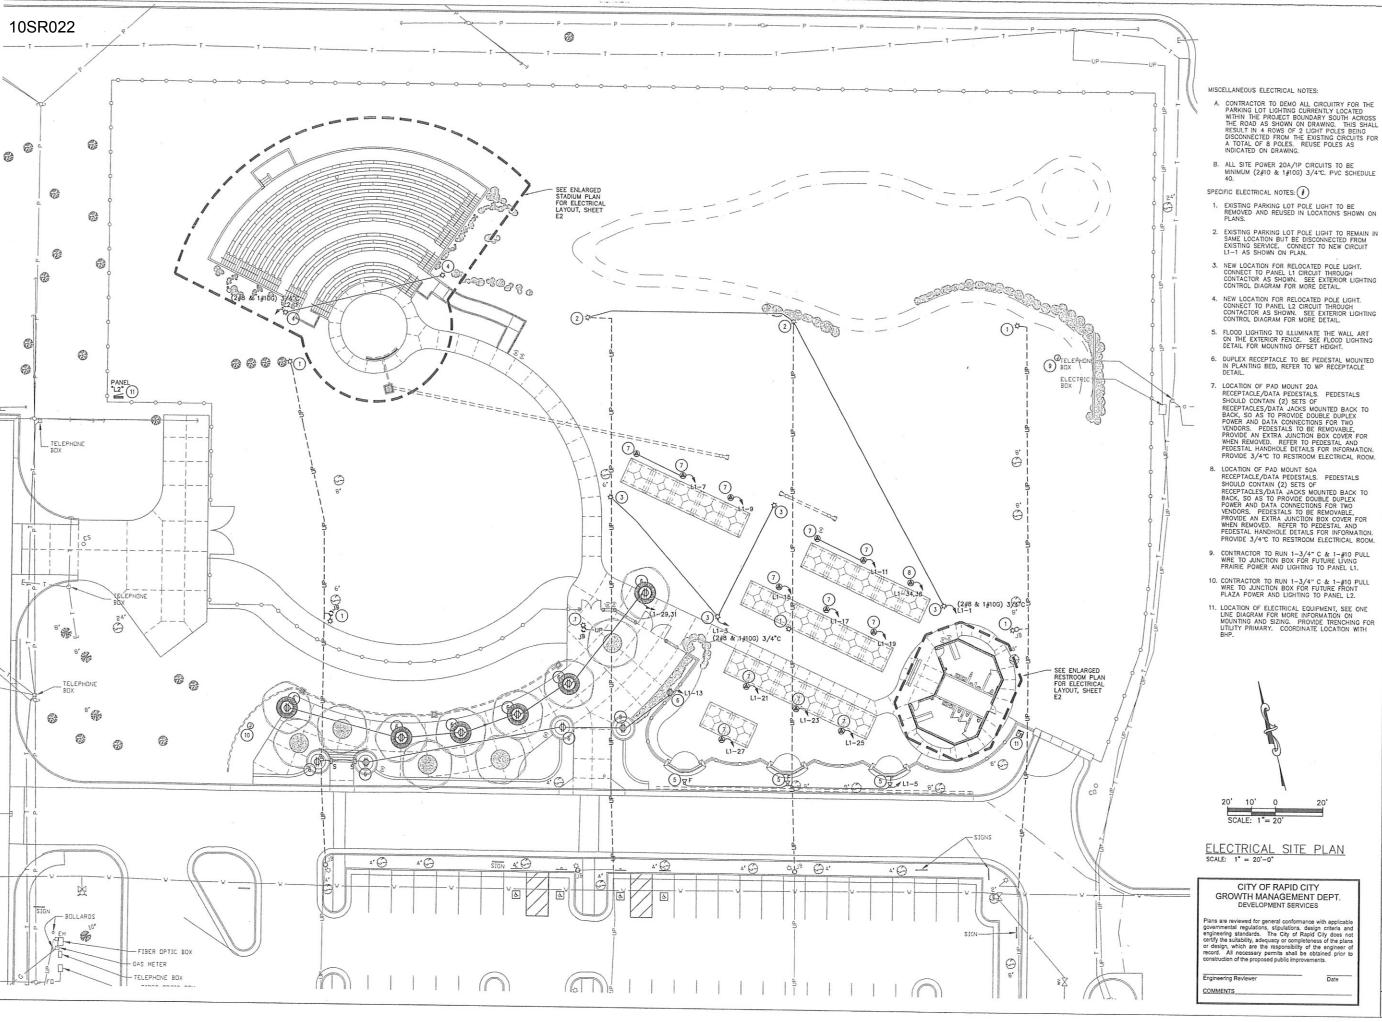

Not for

Construction Designed By: Print Date:

FEB, 2010 xx-xx-xx Internal Job No WPE#R09061 irveyed By: FMG, Inc. AUG, 2009

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POWWOW GARDENS

ART MARKE

ELECTRICAL SITE PLAN

E1 of XX

FEEDER SIZES: (#)

1. 2 1/2"C. - 2 SETS(4#3/0)

5. 3/4°C.

2. 2 1/2°C. - 4#3/0 & 1#6G 3. 2 1/2°C. - 4#3/0 & 1#6G



PRELIMINARY

Not for

Construction

Designed By:	Drawn By:
Design Date:	Print Date:
EB, 2010	xx-xx-xx
nternal Job No: VPE#R0906	1
urveyed By:	Survey Date:
MG. Inc.	AUG, 2009


WOW GARDENS & ART MARKET

POWWOW

Sheet Title:
ENLARGED
ELECTRICAL

ELECTRICAL PLANS

E2 of XX

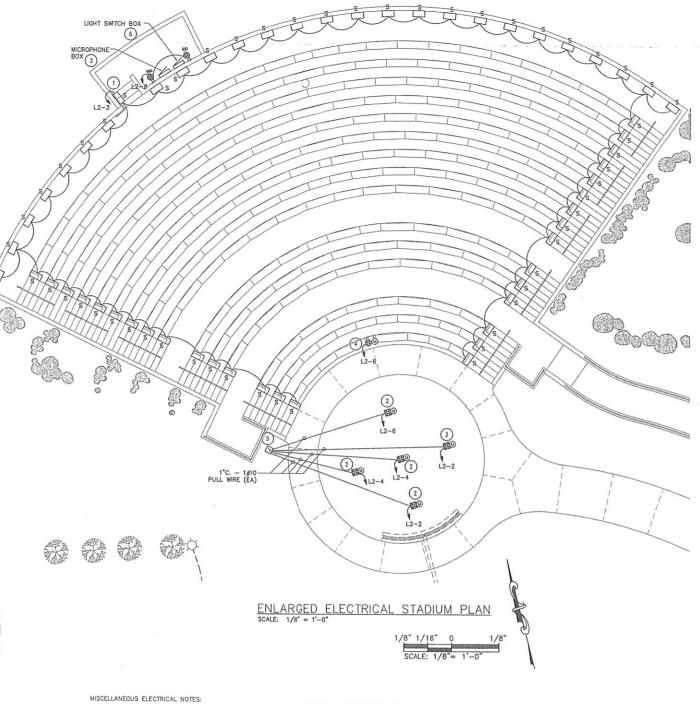

A. -.

SPECIFIC ELECTRICAL NOTES:

- CONNECT STEP LIGHTING TO PANEL L2
   THROUGH CONTACTOR AS SHOWN. SEE
   EXTERIOR LIGHTING CONTROL DIAGRAM FOR
   MORE DETAIL.
- 2. DOUBLE DUPLEX AND MICROPHONE SYMBOLS INDICATE A STAGE MICROPHONE AND RECEPTACLE BOX. COORDINATE LOCATION OF THESE BOXES WITH THE LANDSCAPE ARCHITECT. SEE THE STAGE MICROPHONE AND RECEPTACLE BOX DETAIL FOR MORE INFORMATION.
- 3. WEATHERPROOF LOCKABLE WALL BOX
  CONTAINING THE MALE ENDS OF THE 3 PIN XLR
  MICROPHONE LINES. EACH FEMALE
  MICROPHONE JACK FROM THE STAGE TO BE
  CONNECTED TO THIS LOCATION AND A MALE
  MICROPHONE JACK PROVIDED FOR EACH, (6)
  TOTAL. SEETHE STAGE MICROPHONE AND
  RECEPTACLE BOX DETAIL FOR ADDITIONAL
  INFORMATION.
- WALL MOUNT A DOUBLE DUPLEX AND FEMALE MICROPHONE JACK IN THE OPENING BETWEEN THE SEATS. MICROPHONE JACK TO CONNECT TO MICROPHONE BOX LOCATED IN THE SOUND CONTROL ROOM.
- LOCATION OF THE OFF-STAGE CONDUIT JUNCTION BOX. SEE THE DETAIL OF THE SAME NAME FOR MORE INFORMATION.

- 6. WEATHERPROOF LOCKABLE WALL BOX CONTAINING (2) TOOGLE SWITCHES. TOOGLE SWITCHES TO CONTROL THE POLE LIGHTING CIRCUIT IN THIS AREA AND THE STADIUM STEP LIGHTING CIRCUIT, BOTH CONNECT TO PANEL L2.
- PROVIDE 120V TO MOTORIZED LOUVER FROM L1-32. INTERLOCK WITH SF-1 & EF-1.
- 8. HAND DRYER DYSON AIRBLADE, 120V.
- PROVIDE 2°C. FROM NEAREST COMMUNICATIONS PEDESTAL FOR SERVICE. PROVIDE 3'X3' PAINTED PLYWOOD FOR TELEPHONE TERMINAL BOARD.

CITY OF RAPID CITY
GROWTH MANAGEMENT DEPT.
DEVELOPMENT SERVICES

Plans are reviewed for general conformance with applicable governmental regulations, stipulations, design criteria and engineering standards. The Cty of Rapid City does not certify the suitability, adequacy or completeness of the plans or design, which are the responsibility of the engineer of reconstruction of the proposed public improvement profits that the construction of the proposed public improvement.

Engineering Reviewer

MENTS

ONE—LINE DIAGRAM
NO SCALE

(1)

CABINET  $\left(\frac{1}{2}\right)$ M2 (O) □ 11-2.4 D L1-14,16 (F) L1-18 11-2.4 3 T (H) M2 L1-24,26 L1-39\_ PANEL 11-28,30 (A) (F) 11-28,50 L1-18 7 L1-20 HAND DRYER (8)


ENLARGED ELECTRICAL RESTROOM PLAN


200A PNL L1

(3)


200A PNL L2

1/4" 1/8"

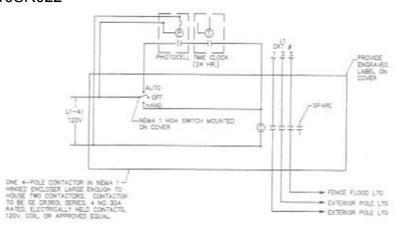


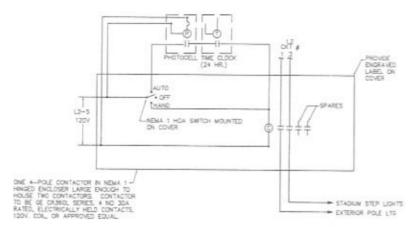


EXTERIOR LIGHTING CONTROL DIAGRAM

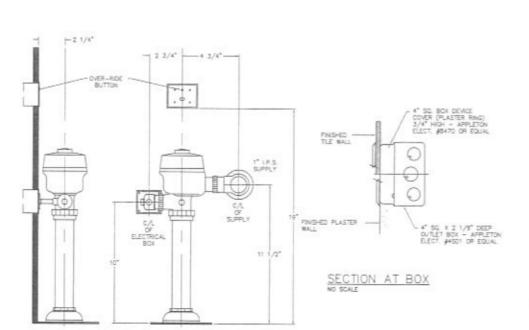


ROUGH-IN DETAIL AT EACH WATER CLOSET

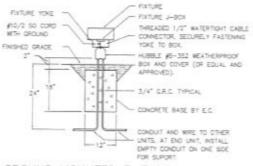


GROUND MOUNTED FIXTURE DETAIL

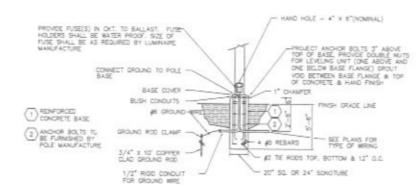


POLE BASE DETAIL FOR RELOCATED POLES

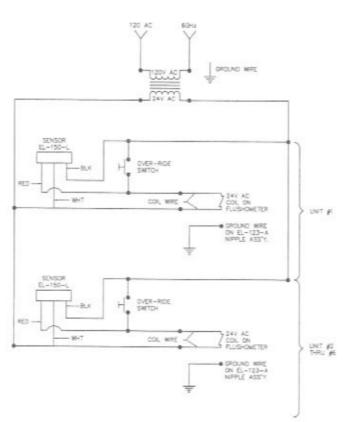

WIRING DIAGRAM - AUTO SENSING WATER CLOSETS

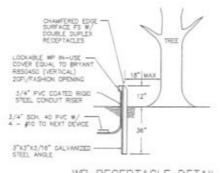

WP RECEPTACLE DETAIL

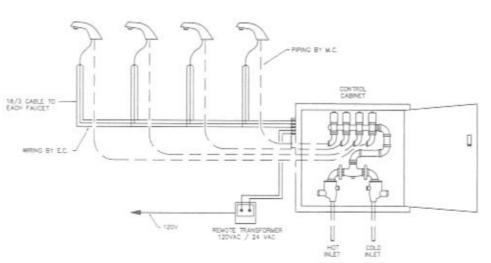

WIRING DIAGRAM -- AUTO SENSING FAUCETS

CITY OF RAPID CITY GROWTH MANAGEMENT DEPT. DEVELOPMENT SERVICES

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PRELIMINARY Not for Construction

Design Date: Prot Date: FEB, 2010 ISHOHO WPE#R09061 Sunsy Date: Sunsy Date: FMG, Inc. AUG, 2009


> ∞ŏ POWWOW GARDENS **ART MARKET**

Sheet Title:

ELECTRICAL DETAILS


E4 = XX

## 10SR022

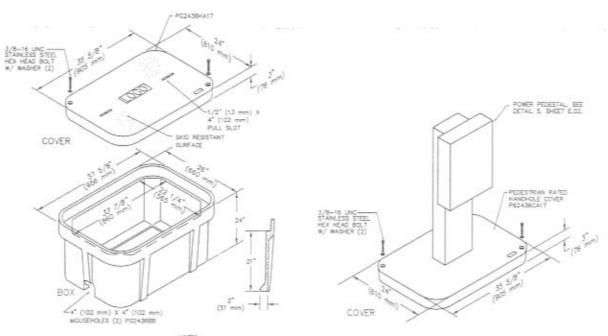


- 1. QUAZITE MODEL PG24568A24 W/ PG2436HA17 COVERS WITH SASKET.
- PROVIDE ADDITIONAL POZAMICATY COVER WITH GASKET FOR MOUNTING OF POWER PEDESTALS FOR EACH OF 6 HANDHOLES.

PEDESTAL HANDHOLE DETAIL

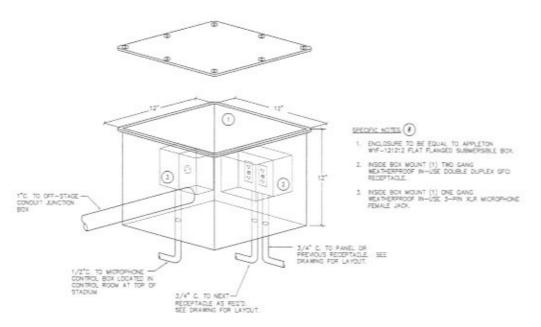

STAGE MICROPHONE AND RECEPTACLE BOX DETAIL

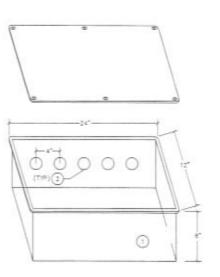

SPECIFIC NOTES (F)

- 1. ENGLOSURE TO BE EQUA, TO APPLETON WHT-241208 FLAT FLANGED SUBMERSIBLE BOX.
- 1" CONDUIT POWERACTIONS FOR 1" CONDUITS COMING FROM EACH STAGE MICROPHORE AND RECEPTACLE BOX AS SHOWN ON THE DYLARGED STACIUM PLAN.

OFF-STAGE CONDUIT JUNCTION BOX DETAIL





PRELIMINARY Not for Construction

Designed By:	Drawn By:
Design Date:	Print Date:
FEB, 2010	10-10-01
WPE#R0906	1
WPE#R0906 Surveyed By:	Survey Date:

య ART MARKET

POWWOW GARDENS

CITY OF RAPID CITY GROWTH MANAGEMENT DEPT.


DEVELOPMENT SERVICES


Flans are reviewed for general conformance with applicable governmental requisitions, absolutions, design critical sand projections and simple critical sand projections and certify the suitability, adequate or completeness of the plans or ideage, which are the respectability of the exposer of the projection of the projection of the projection of the projection of the projected public improvements of the projected public improvements.


ELECTRICAL

DETAILS

E5 d XX

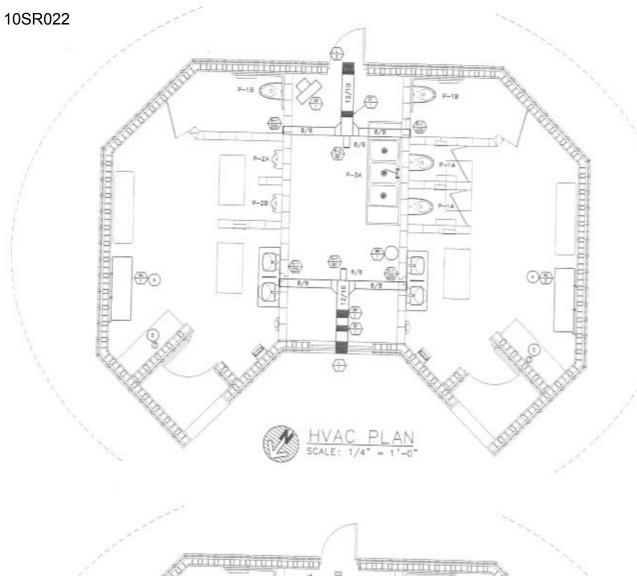

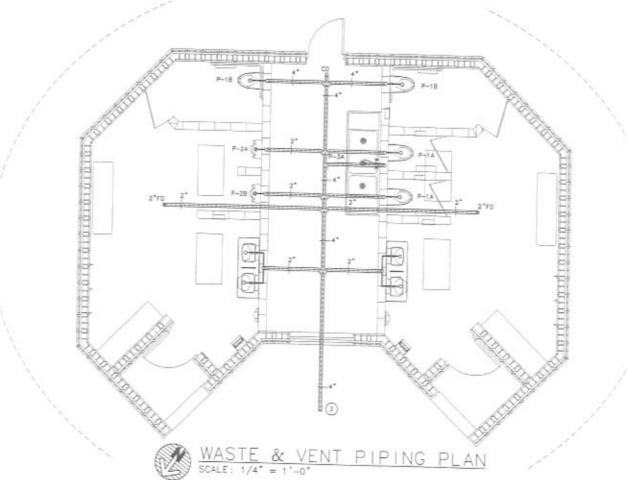

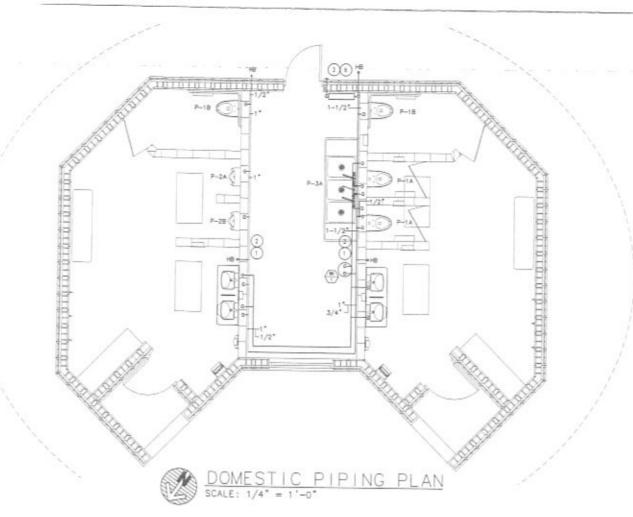

DENERAL MECHANICAL NOTES.

- A. COORDINATE LOCATIONS OF PIPING WITH OTHER TRADES.
- B. ALL PPING INSULATION SERVING DOMESTIC COLD WATER PIPING SHALL BE INSTALLED WITH UNDERDOON VAPOR BARRIERS AS PER SECONDRACTOR TO USE METAL SADDLES AND STRAINS ON EXTENSION FOR SALATION FOR SUPPORT OF PIPING AT HANGERS, UNISTRUT, ETC.
- C. ISOLATE ALL COPPER PIPE FROM BEARING ON FERROLLS MANGERS, ETC. WITH ELECTRICALLY OSCILLATING MATERIALS AS SPECIFIED. USE DELECTRIC UNIONS ON CONNECTION OF ALL COPPER PIPING TO FERROLS PIPING AS SPECIFIED.
- D. COORDINATE LOCATION OF DUCTWORK AND PIPING WITH STRUCTURE AND OTHER TRADES. INSTALL DUCTWORK AS HIGH AS POSSIBLE.

SPECIFIC MECHANICAL NOTES:

- PLUMPING

  1. PROVICE SLOAN EL-154 (120VAC/24VDC, 50VA)

  TRANSFORMER WITH 12" X 12" STANNLESS STEEL
  BOX WITH LIDOWING COVER, PROVIDE (1) BOX FOR
  EACH RESTROOM.
- 2. PROVIDE (1) TRANSFORMER FOR A MAXIMUM OF (2) FALCETS AND (3) WATER CLOSETS OR URINALS
- 3. REFER TO SITE/CIVE, PLANS FOR CONTINUATION.
- 4. MOUNT AC UNITS AT 7' AFF
- 5 FROMDE LOOKING COVER ON ALL THERMOSTATE
- 6. SEE WATER METER DETAIL

CITY OF RAPID CITY GROWTH MANAGEMENT DEPT. DEVELOPMENT SERVICES

Plans are reviewed for general conformance with applicable governments requisitions, stipulations, design orders and engineering standards. The City of Rapid City does not carefy the solutionity, adequate or completeness of the plant of design, which are the responsibility of the sequence of executed All reconsists yourself control. All reconsists yourself control.



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PRELIMINARY Not for Construction


Designed By: MSH/JHH	Drawn By
Design Date:	Presi Date:
FEB, 2010	707 103-103
Internal Job No.	
WPE#R0906	
Surveyed By:	Survey Date:
FMG, Inc.	AUG, 2009
Raydelonic	

ŏ POWWOW GARDENS ART MARKET


HVAC & PLUMBING PLANS.

M1 a XX


## 10SR022

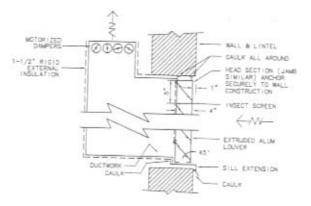



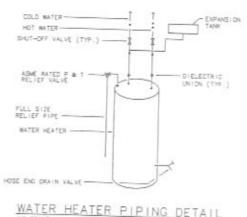

NG DETAIL	WATER METER PIPING DETAIL

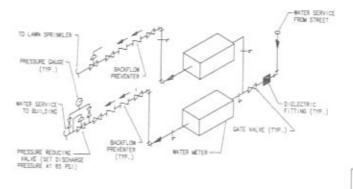

JNET	MANUFACTURER'S			SIZE		**	PRES AREA	
NO						3.5	FREE AREA	
	DESIGNATION	LOCATION	FUNCTION	W X H	CFM	(24. W.G)	VELOCITY (FPM)	REMARK
1,-1	RUSKIN ELF83750x0	MEDH ROOM	INTAKE	18" 3 18"	510	0.05	656	1.2.3
1-2	RUSKIN ELF6375010	MEDH ROOM	EXHAUST	18" x 18"	610	0.05	656	1.2.3

PROVIDE WITH BIRD SCREEN

2. ARDIFFICE TO SELECT COLOR.
3. ALUNINUS CONSTRUCTION WITH BAKED ENAMEL FINISH.

PACKAGE A		NDITIO	MINE	UN	11 5	CHEL	DULE	(HEA	T PI	JMP)
NIT MANUFACTURER'S NO DESIGNATION	HEAT		COOLING			HEATING		ELECTR		J. (*)
20. DESIGNATION 0-1 GE AZ39H120	KW	MBH	AMB	EAT	MBH	COP	DAT	V/PH/H7	MCA	
	-	11.65	-		10.9	3.4	951	208/1/90	MUA	REMARKS
C-Z GE AZ39/120	-	11.85			10.9	3.4			4.7	1,2,3
	ATT-1				10.7	2.4		208/1/60	4.7	1,2,3

NOTES: 1. PROVICE CORD AND PLUG.

2 PROVIDE WALL SLEEVE.

3. PROVIDE WITH WALL WOUNTED THERMOSTAT.

	P	LUMBIN	G FI	XTUR	RF SC	HFI	DILLE
FIXTURE MANUFACTURER'S NO DESIGNATION		FIXTURE TYPE				PLY	
P1-4	ACORN "MERDIAN"	MATER CLOSET	WASTE	VENT	CW	HW	TRIM/REMARKS
	Z140-T-1-89	Tanamarian by	4	2"	1-1/4"	-	SLONE OFTMA MODEL 152-1.5 ES-5. PROVIDE
	2.5	1.5 GHF		-		-	ACCRN BLACK OPEN FRONT SEAT (LESS COVER)
		1.0 0/7					CARRER AND SLOAN EL-154 TRANSFORMER
P1-8	ACORH "MERDIAN"	WATER A ANDERS					The state of the s
	2140-T-1-PM	WATER CLOSET (WALLHUNG PV	4"	2"	1-1/4"	-	SLONE OFTIMA MODEL 152-1.6 ES-S. PROVIDE
	MOUNT AT HE HEIGHT	1.6 GPF					ACORN BLACK OFEN FRONT SEAT (LESS COVER).
	THE PERMIT	1.6 GPF					CARRIER AND SLOAN EL-154 TRANSFORMER
P2-4	ACORN "MERIDAN			70.000			THE PARTY OF THE P
	2155~T=1-RM	URNAL	- 2"	1-1/2"	3/4"	-	SLONE OFTMA MODEL 195-0.5 E5-5
		(F¥)					MODEL DURA-WARE 2158, PROVIDE CARRIER
		0.5 GPF					AND SUDAN EL-154 TRANSFORMER
P2-8	ACORN "WERDIAN:						PAGE SCHOOL ET A 124 INVANCE CHARES
	2155-T-1-PM	LRINAL	2"	1-1/2"	3/4"	-	SLONE OPTIMA MODEL 195-0.5 85-5
	MOUNT AT HC HEIGHT	(FV)					MULE DISH MITT THE BOOK TO
-	MOUNT AT HE HEIGHT	0.5 CPF					MCDEL DURA-WARE 215M, PROVIDE CARRIEN AND SLOAN EL-154 TRANSFORMER
P3-4	- Harris						WHO SELLAN EX-104 TRANSFORMER
-	ELKAY "RIGORILY" RNS/8372-94	TRIPLE COMP. SINK	2"	1-1/2"	1/2"	1/2"	(2) DHCASE FAUGITS 540-LDL12E1WWGP
	DRS 6372.74					-	HANDI-TRAP SUPPLY/DRAIN
							PROTECTION, ADA, POMERS 6480
161							THERMOSTATIC MIXING VALVE
765	WOODFORD B65	HOSE BBB	-	-	1/2*	-	CONTENTS for the second
					- 72		CONCEALED BOX TYPE, FREEZELESS ANTI SIPHON, OFFICIAL VACUUM

		W.	ATER	HEATER	SCH	HEDUI	F			
NO	MANUFACTURER'S DESIGNATION	LOCATION	SERVES	STORAGE CAPACITY		RECOVERY	TEMP.	ELECTR	CAL	
04-1	A.O. SMITH DEL-15	MECH. RM.	- 70	15 GAL		RATE 20 GPH	RISE	208/1/60	MCA	REMARKS

NOTES 1. 3 KW NON-SMULTANEOUS OPERATION ELEMENT

		UNITE	<b>HEATE</b>	RS	CHEC	HE			
JNIT NO	MANUFACTURER'S DESIGNATION	LOCATION				ULL	MOTOR		
	BERKO HUHAA320		MBH	KW	CFM	RPM	HP	VOLTAGE	REMARKS
	100000	MECH ROOM	10	2	350	1500	1,7100	208/1/60	T-LWPANS

NOTES: 1. PROVIDE HEATING THERMOSTAT.

	E)	(PANSI	ON TA	NK SC	HEDI	I F	
NO.	MANUFACTURER'S DESIGNATION				SIZE		
	AMTROL ST-5-C	LOCATION	SERVICE	GALLONS	LENGTH	DIAMETER	REMARK
		MECH ROOM	DOM: WITE	2.1	10-3/5"	10"	numerous.

			F.A	IN SCH	HED	ULF					
LNOT NO	MANUFACTURER'S DESIGNATION			MERATION		5.P.D.	MAX	M	TOR		
₽-1	COOK GC-720	LOCATION WEDH ROOM	SERVICE DHAUST	ISOLATION	CFM	(N)	RPM	HP	ELEC	SONES	REMARKS
	COOK (N-720	MEDI ROOM		INTERNAL	530	0.75	1600	246 W	120,7,40	4.5	1,2,3,4
		MILLON ROOM	SUPPLY	INTERNAL	530	0.75	1500	246 W	120,7 /60	4.5	1.2.3.4.5
									1		

MECHANICAL SYMBOLS

NOTES: 1. SELECTED AT \$200 FT ELEVATION. PROVIDE WITH FAN SPIED CONTROL SWITCH.

2. PROVIDE WITH INVESTIGAT, STANDARD PLUG DISCONNECT, RUBBER ISOLATORS.

3. PROVIDE WITH ANDDIZED ALLMINUM DRILLE.

4. PROVIDE WITH WALL CAP OF ROOF CAP (AS NOTCATED ON PLANS) WITH BACK DRAFT DAMPER.

5. PROVIDE WITH FLIER BOX AND FLIER. FLIER SHALL BE 2" THOS WITH AREA OF \$24" X24", MERY 8 RATING.

	COLD MAT	EA FIFE		HOT MATER PURE			
	UNCENTRO COLD WAT	LND EF FIPE		UNDERGROUND HOT WATER FIRE			
-	UNDERFLO	OF WASTE PIPE		ABOVE FLOOR WASTE FIR		VENT FIFE	
_	PIPE DOM	NECTION			Δ		
	ELBOW DO		_ 🗜	FLOW ALARM		AIR VENT	
0-	ELSON UP			FLOW MEASURING DEVICE	. 9	<ul> <li>MESSIRE/TEMPERA</li> </ul>	TURE TAP
-	TEE DOWN			EXPANSION JOINT, FIFE	- P	PRESSURE GAUGE	
	PIPE FIT	CH DOWN	E	CAPPED DUTLET		STATIC PHESSURE	SENSOR
	DIRECTIO	N DF FLOW		SHUT OFF VALVE		THERMONETER	
	PIPE AND			BALANCING VALVE		STRAINER	
-0-	REDUCER (	OF INCREASER		CONTROL VALVE		STEAM TRAP	
-				3-MAY CONTROL VALVE		SO BACK FLOW PREVEN	
	FLEXIBLE	PIPE CONNECTION	-50-	PRESSURE REDUCING VAL		FLOW CONTROL VAL	VE.
WI				PRESSURE RELIEF VALVE	- 40	- STRAINER VALVE	
10.00	HOSE BIB					W- MEZZINE SENSOR	DIFFERENTIA
CO	CLEAN OU	ABOVE FLOOR		DOMESTIC MATER TEMPER		DIERMESTAT	
WCO-0-	D. FAN D.C.	AN DUT T. IN FLOOR	-	DEDI VALVE	G.	NIGHT THEMOSTAT	
foe	FLOOR DIS	ATN	0	22220	G,	DEMEST NUMBER	DO:
FSO	FL00R 519	WC.	-8-	DURB STOP	8_	HAND STAT	
100	MODE DRA		000	OVERFLOW ROOF DRAIN		FLOW SWITCH	
	PARTIE TO	* CLIMB N 1	AD 6	AREA DISKIN			
\$10-1)	THE FINAL RAD DESCRIPTION	EATION DESIGNATION	هر	CONNECT TO EXIST. SER		DEMOLITION HATE	OHING
\$10-1)	FINAL RAD		هر			(14)	CHING
\$10-1)	FINAL RAD		NT I L	CONNECT TO EXIST. SER			OHING
840-7	FINES RAD BURST LENGTH	VE	Jª NTIL/ oom)	CONNECT TO EXIST. SER	MBOLS		
840-7	FINES RAD BURST LENGTH	VE		CONNECT TO EXIST. SER	MBOLS	E DAMPER	
840-7	FINES RAD BURST LENGTH	VE supply bust (up a strupe bust (up a	DOW)	CONNECT TO EXIST. SER	MBOLS  WALL VALIM  BRANCH DUCT  BUCT ALSE ON  FE ALSE FLOW	E DAMPER	
840-7	FINES RAD BURST LENGTH	VE SUPPLY DUCT (UP & RETURN DUCT (UP & EXHIBIT DUCT (UP &	DOW)	ATION SY	MBOLS  BRANCH DUCT  BUCT SINCE ON  DUCT INSULAT  DUCT INSULAT	E DAMPER INTO SIDE OF MAIN D. DAMP IN DIRECTION ON- WIDTO & DEPTH	
840-7	FINES RAD BURST LENGTH	VE SUPLY DUCT (UP & SETURN DUCT (UP & EXHAUST DUCT (UP & STANDARD RADIUS EL R ESUAL W (WISTAM)	NTIL/	ATION SY	MBOLS  BRANCH DUCT BUCT BISE OR  DUCT BISECULT  DUCT INSULAT (SEE SPECIFIC	E DAMPER INTO SIDE OF MAIN D. DROP IN DIRECTION DN-WIDTO & DEPTH ION CATION)	ir.
840-7	FINES RAD BURST LENGTH	VE  SUPPLY DUCT (UP &  RETURN DUCT (UP &  EDWARD RADIUS &  FEDUAL W (WISHIMM  DUCT TURN WITH TURN  FUERIBLE DUCT CONN  SPIRAL DUCTRORK	NTIL/ DOWN) DOWN) DOWN) N VANCS	ATION SY	MBOLS  MANUAL VOLIM  BRANCH DUCT  DUCT RISE ON  DUCT INSULAT  ISEE SPECIFIC  DUCT TISE (NON-ADJUSTA)	E DAMPER INTO SIDE OF MAIN D. DROP IN DIRECTION DN- WIDTO & DEPTH IDN CATION S. ALE SPLIT TYPE TAK R.E.	ET EST
		SUPLY DUCT (UP & METURN DUCT (UP & METURN DUCT (UP & METURN DUCT (UP & METURN METURNAL MUCT TURN WITH TUR FLEXIBLE DUCT CONN SPIRAL DUCTRORX MAX 2" R.G. PRESEN	NTIL/	ATION SY	MBOLS  MANUAL VOLIM  BRANCH DUCT  DUCT RISE ON  DUCT INSULAT  ISEE SPECIFIC  DUCT TISE (NON-ADJUSTA)	E DAMPES INTO SIDE OF MAIN DU DROP IN DIRECTION ON A DIFF TABLE ON CATION) O AIR SPLIT TYPE TAK ON CATION, ETHAGE, OLD ON, EMAIN, ETHAGE	ET EST
\$10-1)		VE  SUPPLY DUCT (UP &  RETURN DUCT (UP &  EDWARD RADIUS &  FEDUAL W (WISHIMM  DUCT TURN WITH TURN  FUERIBLE DUCT CONN  SPIRAL DUCTRORK	NTIL/	ATION SY	MBOLS  MANUAL VOLUM  SEANOH DUCT  DUCT RISE ON  DUCT DIMENSIT  DUCT TUPN AND  (MON-ADJUSTA  SERVICE)  SERVICE  SERVICE	E DAMPER INTO SIDE OF MAIN D. DROP IN DIRECTION ON- WIDTH & DEPTH ION DATION) O AIR SPLIT THPE TAK SITE & DIFFLISER DESI ON, EMAINT, & TRANC	ET EST



Plots are reviewed for personal conformance with applicable power-mental regulations, assupations, design offers and employeeing standards. The City of Ropation City times not certify the subschillp, steepuncy or completeness of the plans or ideaps, which are the responsibility of the engineer of the plans are ideaps, which are the responsibility of the engineer of the processor personal than the engineer of the processor personal trade to extend processor and the processor of the processor public improvements.

COMMENTS



# Not for Construction

Designed By: Drawn By: MSH/JHH JPC
Design Date: Print Date: FEB, 2010 83-KSHX Memal Job No: WPE#R09061 Surveyed By: Survey Date: FMG, Inc. AUG, 2009

> ∞ŏ POWWOW GARDENS **ART MARKET**

MECHANICAL DETAILS & SYMBOLS

M2 ~ XX