# Main Street Square Site Development Rapid City, South Dakota [City Project #]



50% Construction Documents
June 23, 2010



RUNDELL ERNSTBERGER
ASSOCIATES, LLC
Land Planning + Urban Design + Landscape Architecture
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PREPARED FOR

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Public Works Department
300 Sixth Street, Rapid City, SD 57701
TE [605] 394-4165 FX [605] 355-3083

Destination Rapid City 606 Main Street, Rapid City, SD 57701 TE [605] 716-7979 FX [605] 341-6415

CONSULTANTS:

FourFront Design, Inc.
Architecture and Civil Engineering
517 Seventh Street
Rapid City, SD 57701
TE [605] 342-9470 FX [605] 342-2377

Skyline Engineering, LLC
Electrical and Mechanical Engineering
615 12th Street
Rapid City, SD 57701
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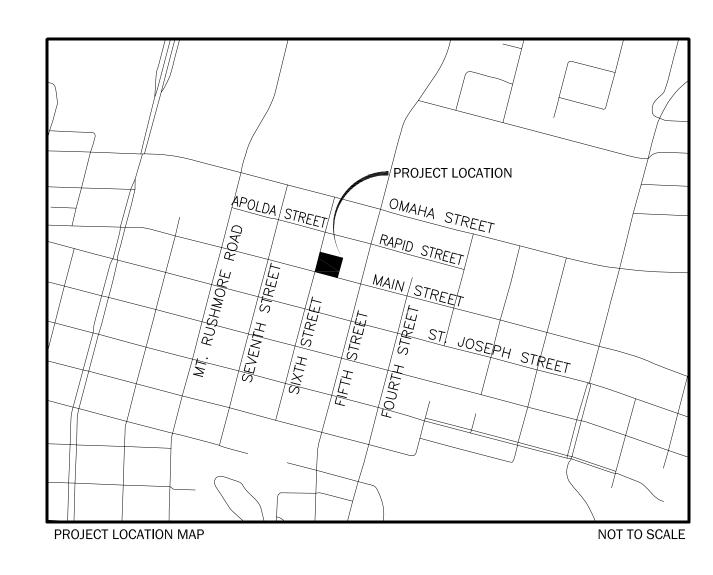
Albertson Engineering, Inc.
Structural Engineering
3202 W Main Street, Suite C
Rapid City, SD 57702
TE [605] 343.9606 FX [605] 341.7395

PROJECT:

Main Street Square Site Development Rapid City, South Dakota

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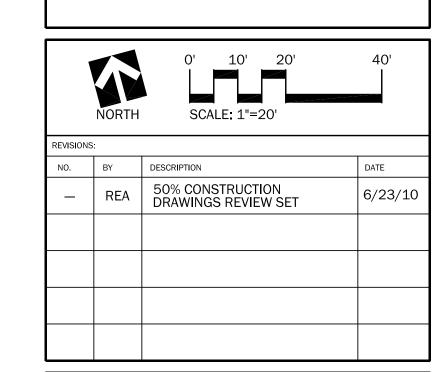
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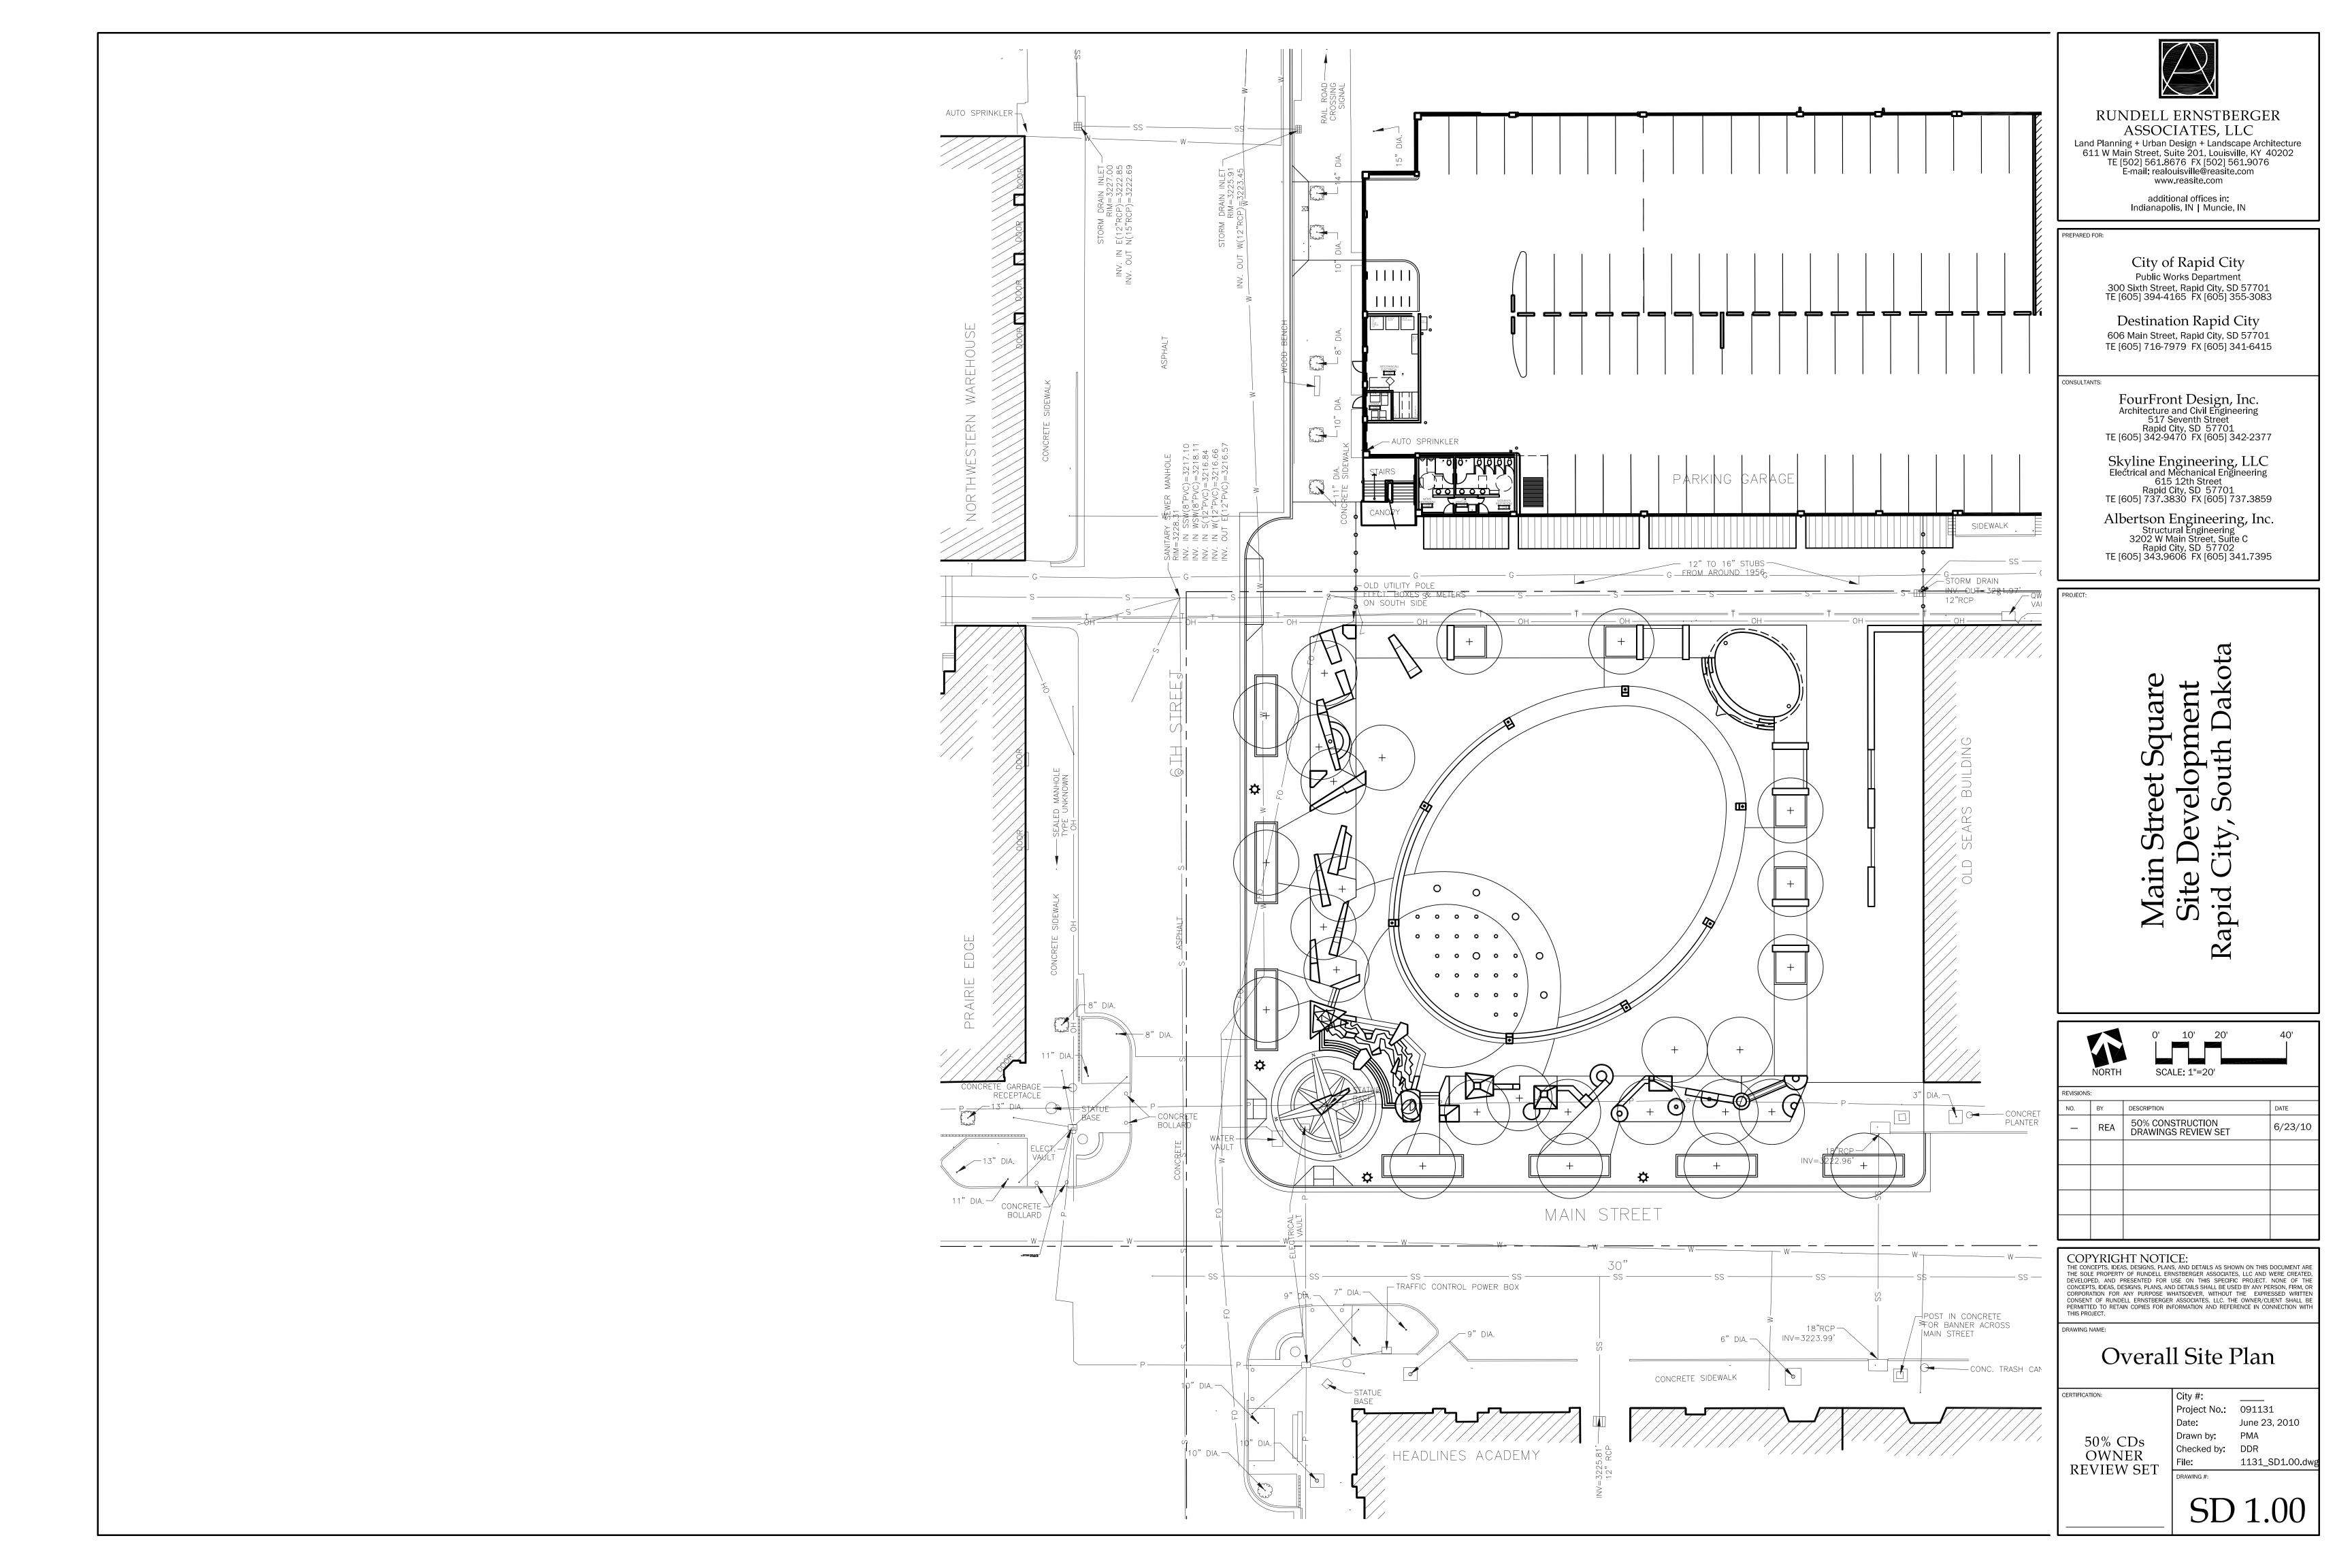
## Project Location & Index of Drawings


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Project No.: 091131
Date: June 23, 2010
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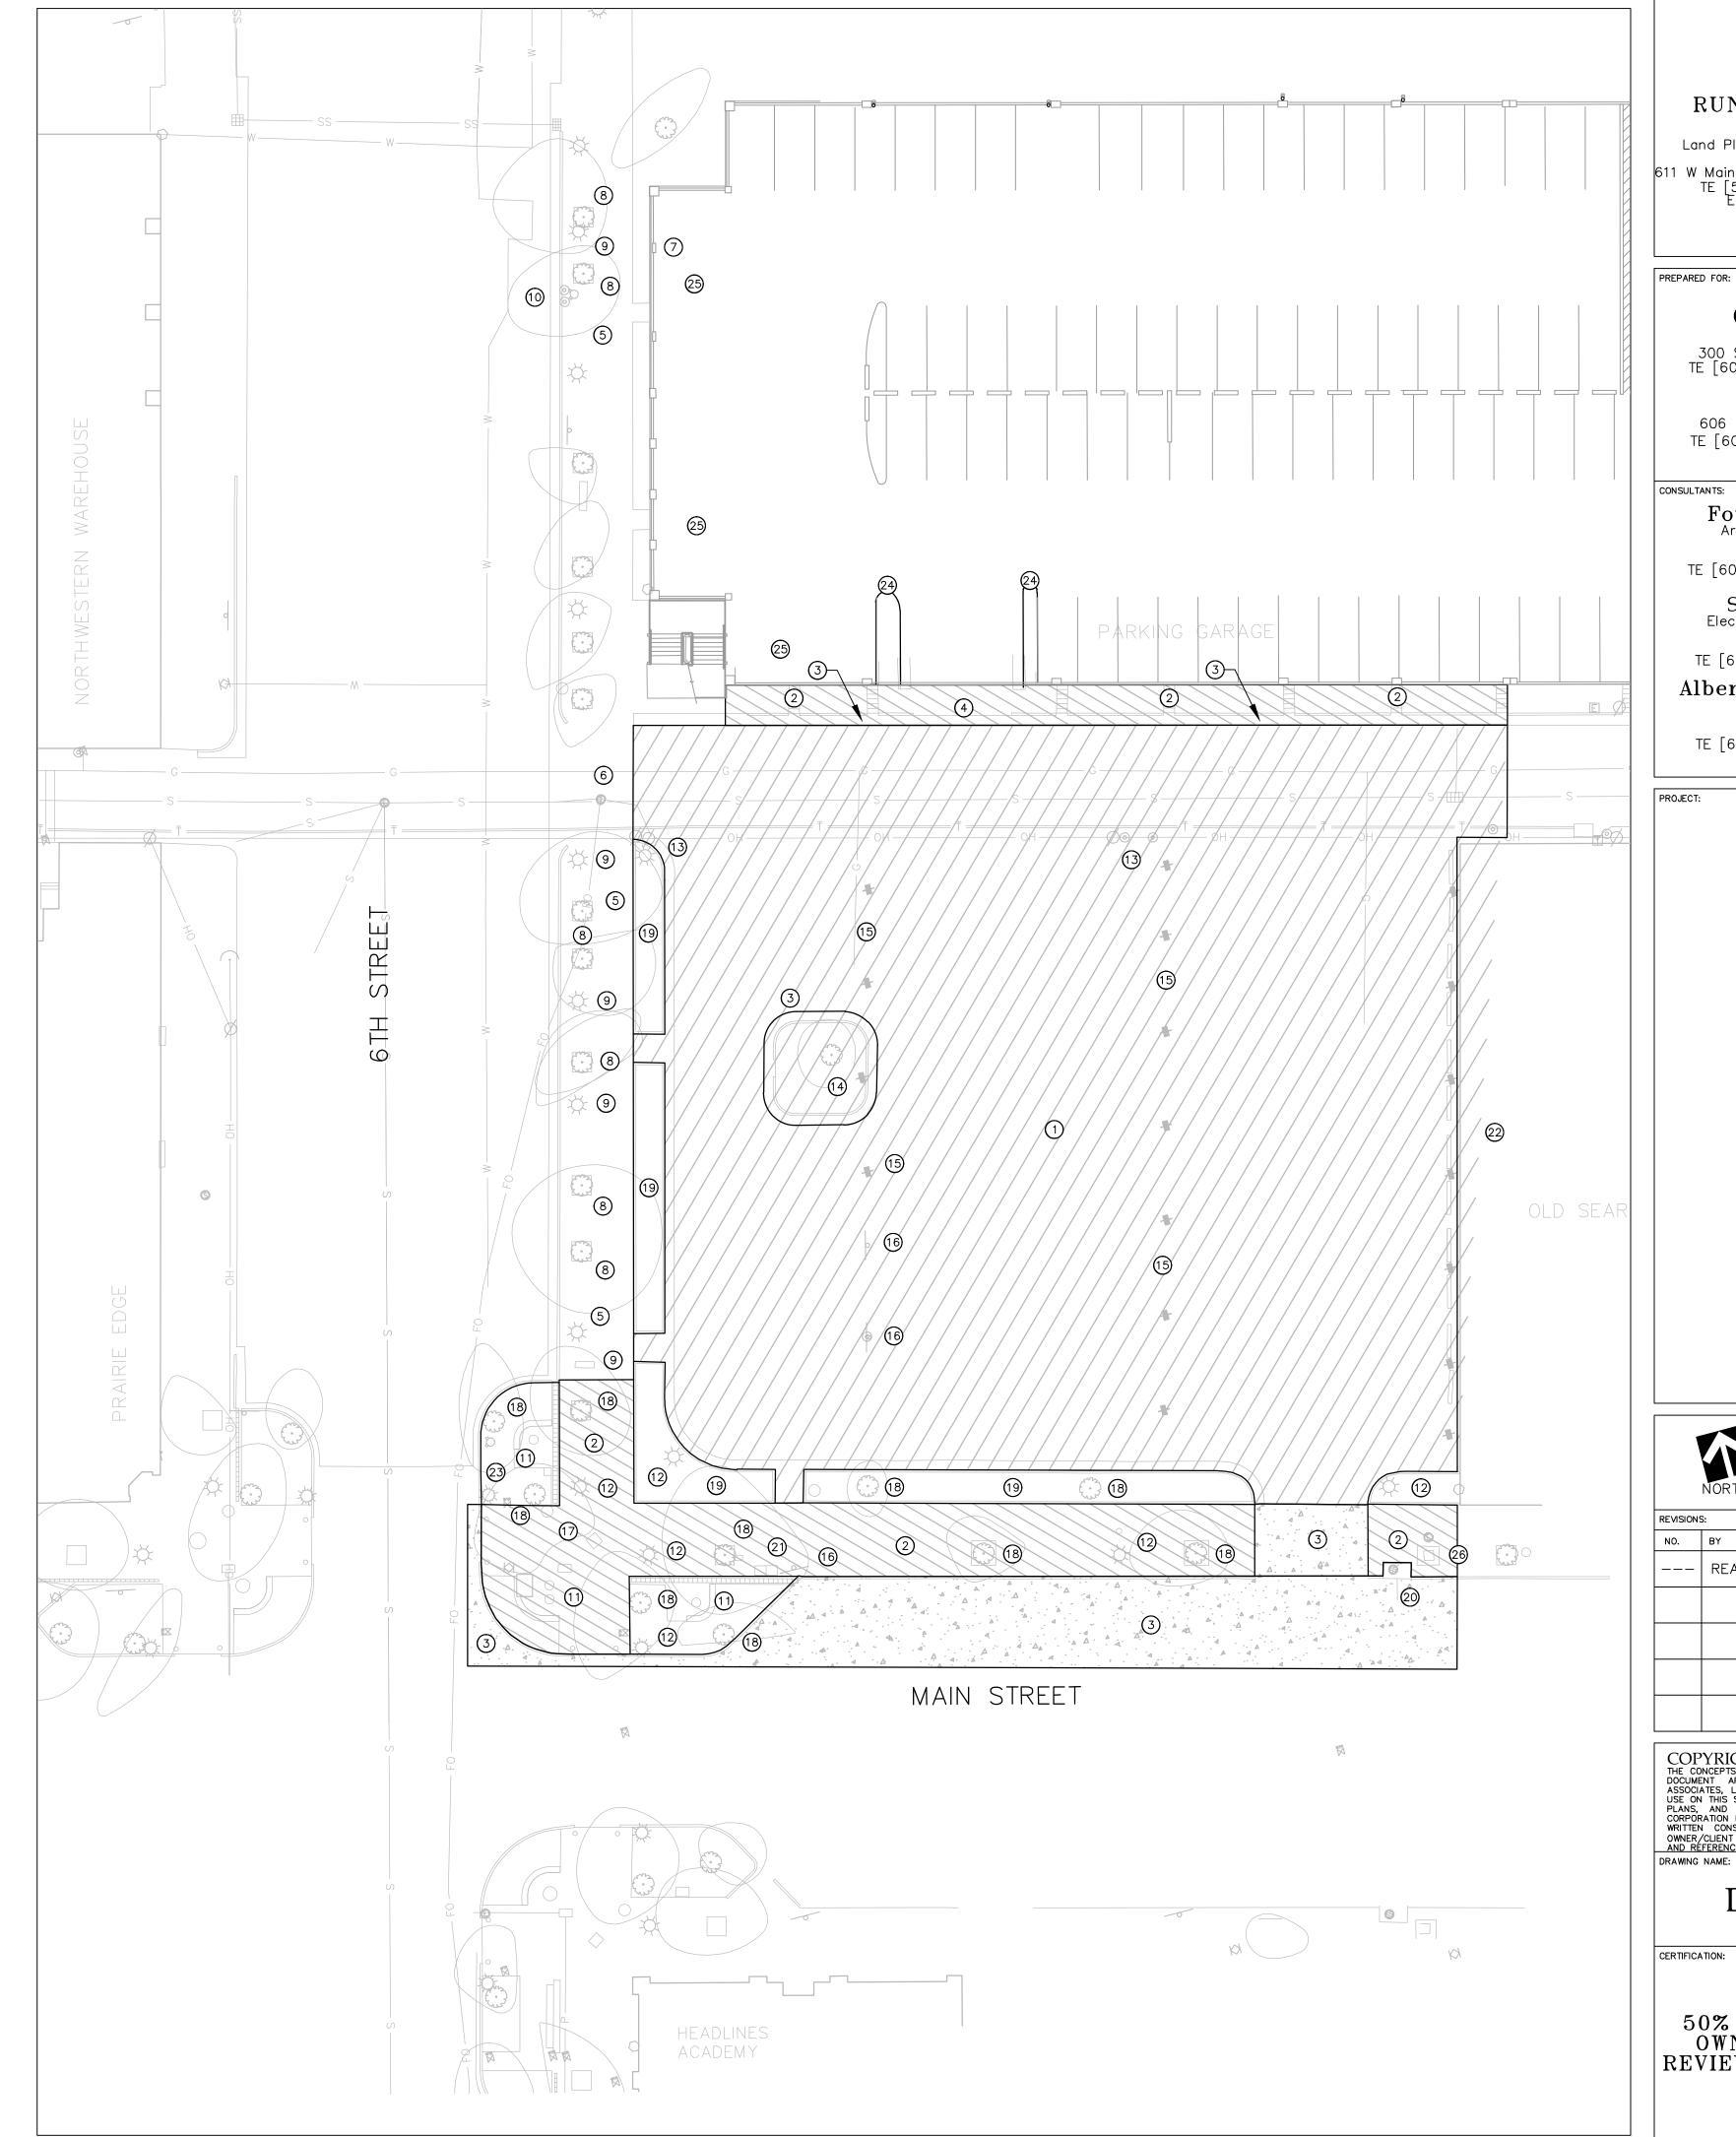
#### **GENERAL NOTES:**

- 1. THE CONTRACTOR SHALL REPORT IMMEDIATELY TO THE OWNER AND LANDSCAPE ARCHITECT ANY DISCREPANCIES BETWEEN THE EXISTING CONDITIONS SHOWN ON THESE PLANS AND ACTUAL FIELD CONDITIONS.
- 2. THE CONTRACTOR SHALL BE RESPONSIBLE FOR REPAIRING ANY DAMAGE RESULTING FROM CONSTRUCTION ACTIVITY TO EXISTING SITE ELEMENTS THAT ARE TO REMAIN.
- 3. THE CONTRACTOR SHALL SMOOTHLY SAW CUT EXISTING PAVEMENTS TO BE REMOVED FROM PAVEMENTS TO REMAIN.
- 4. OWNER SHALL HAVE FIRST RIGHTS TO ALL SALVAGED MATERIALS. COORDINATE WITH OWNER AND TRANSPORT SALVAGED ITEMS TO THE OWNER DESIGNATED STORAGE AREA, IF OWNER RETAINED. ALL OTHER ITEMS SHALL BE HAULED AND DISPOSED OF OFF-SITE BY THE
- 5. IF ANY OTHER UTILITIES ARE ENCOUNTERED BUT NOT SHOWN ON THE SITE PLAN CONTACT THE OWNER AND UTILITY COMPANY IMMEDIATELY.
- 6. COORDINATE ALL DEMOLITION OPERATIONS AND REMOVAL OF DEBRIS WITH THE OWNER.
- 7. CONTRACTOR SHALL MAINTAIN EXISTING UTILITIES AND PROTECT AGAINST DAMAGE DURING DEMOLITION OPERATIONS. ANY DISRUPTION IN SERVICE SHALL BE COORDINATED WITH THE OWNER. CONTRACTOR SHALL PROVIDE A METHOD OF TEMPORARY SERVICE DURING PERIODS
- 8. ALL EROSION CONTROL BMPs SHALL BE IN PLACE PRIOR TO
- 9. DO NOT DISTURB ANY TREES OR STRUCTURES NOT DESIGNATED TO

#### DEMOLITION ITEMS

BE REMOVED.

- (1) REMOVE EXISTING ASPHALT PAVEMENT.
- (2) REMOVE EXISTING CONCRETE SIDEWALK.
- 3 REMOVE EXISTING CONCRETE PAVEMENT, CONCRETE CURB AND GUTTER, AND
- (4) REMOVE EXISTING CONCRETE APPROACH AND P-GUTTER TO PARKING RAMP.
- 5 COORDINATE REMOVAL OF EXISTING SIDEWALKS WITH THE 6TH STREET RECONSTRUCTION
- 6 COORDINATE THE REMOVAL OF EXISTING CONCRETE APPROACH PAVEMENT WITH THE 6TH STREET RECONSTRUCTION PROJECT.
- (7) REMOVE NON STRUCTURAL COLUMN.
- (8) COORDINATE THE REMOVAL OF EXISTING TREES WITH THE 6TH STREET RECONSTRUCTION PROJECT.
- (9) COORDINATE THE REMOVAL OF EXISTING STREETLIGHTS WITH THE 6TH STREET
- COORDINATE THE REMOVAL OF EXISTING FIRE HYDRANT AND BOLLARDS WITH THE 6TH STREET RECONSTRUCTION PROJECT.
- 11) REMOVE ALL EXISTING NODE FEATURES. COORDINATE THE REMOVAL OF NODE PLANTINGS AND PEA GRAVEL WITH THE 6TH STREET RECONSTRUCTION PROJECT - COORDINATE NODE FEATURE REMOVALS WITH THE CITY OF RAPID CITY.
- 12) STREET LIGHT REMOVAL SEE ELECTRICAL SHEETS.
- (13) POWER POLE AND POWER LINE REMOVAL SEE ELECTRICAL SHEETS.
- (14) SALVAGE AND TRANSPLANT EXISTING TREE COORDINATE WITH THE CITY OF RAPID CITY.
- REMOVE AND SALVAGE EXISTING PARKING METER COORDINATE WITH THE CITY OF RAPID CITY.
- (16) REMOVE AND SALVAGE EXISTING SIGN.
- REMOVE AND SALVAGE EXISTING PRESIDENT STATUE COORDINATE WITH THE CITY OF PRESIDENTS ASSOCIATION.
- (18) REMOVE EXISTING TREE.
- (19) REMOVE EXISTING PLANTER. (20) REMOVE EXISTING INLET.
- (21) REMOVE AND SALVAGE EXISTING MAILBOXES COORDINATE WITH THE POSTAL SERVICE.
- (22) EXISTING SEARS BUILDING DO NOT DISTURB.
- (23) EXISTING TRAFFIC SIGNAL LIGHT AND POLE DO NOT DISTURB.
- (24) REMOVE EXISTING CURB AND SIDEWALK.
- (25) REMOVE EXISTING STRIPING.
- (26) EXISTING BANNER POLE DO NOT DISTURB.
- (27) REMOVE EXISTING CURB AND GUTTER.

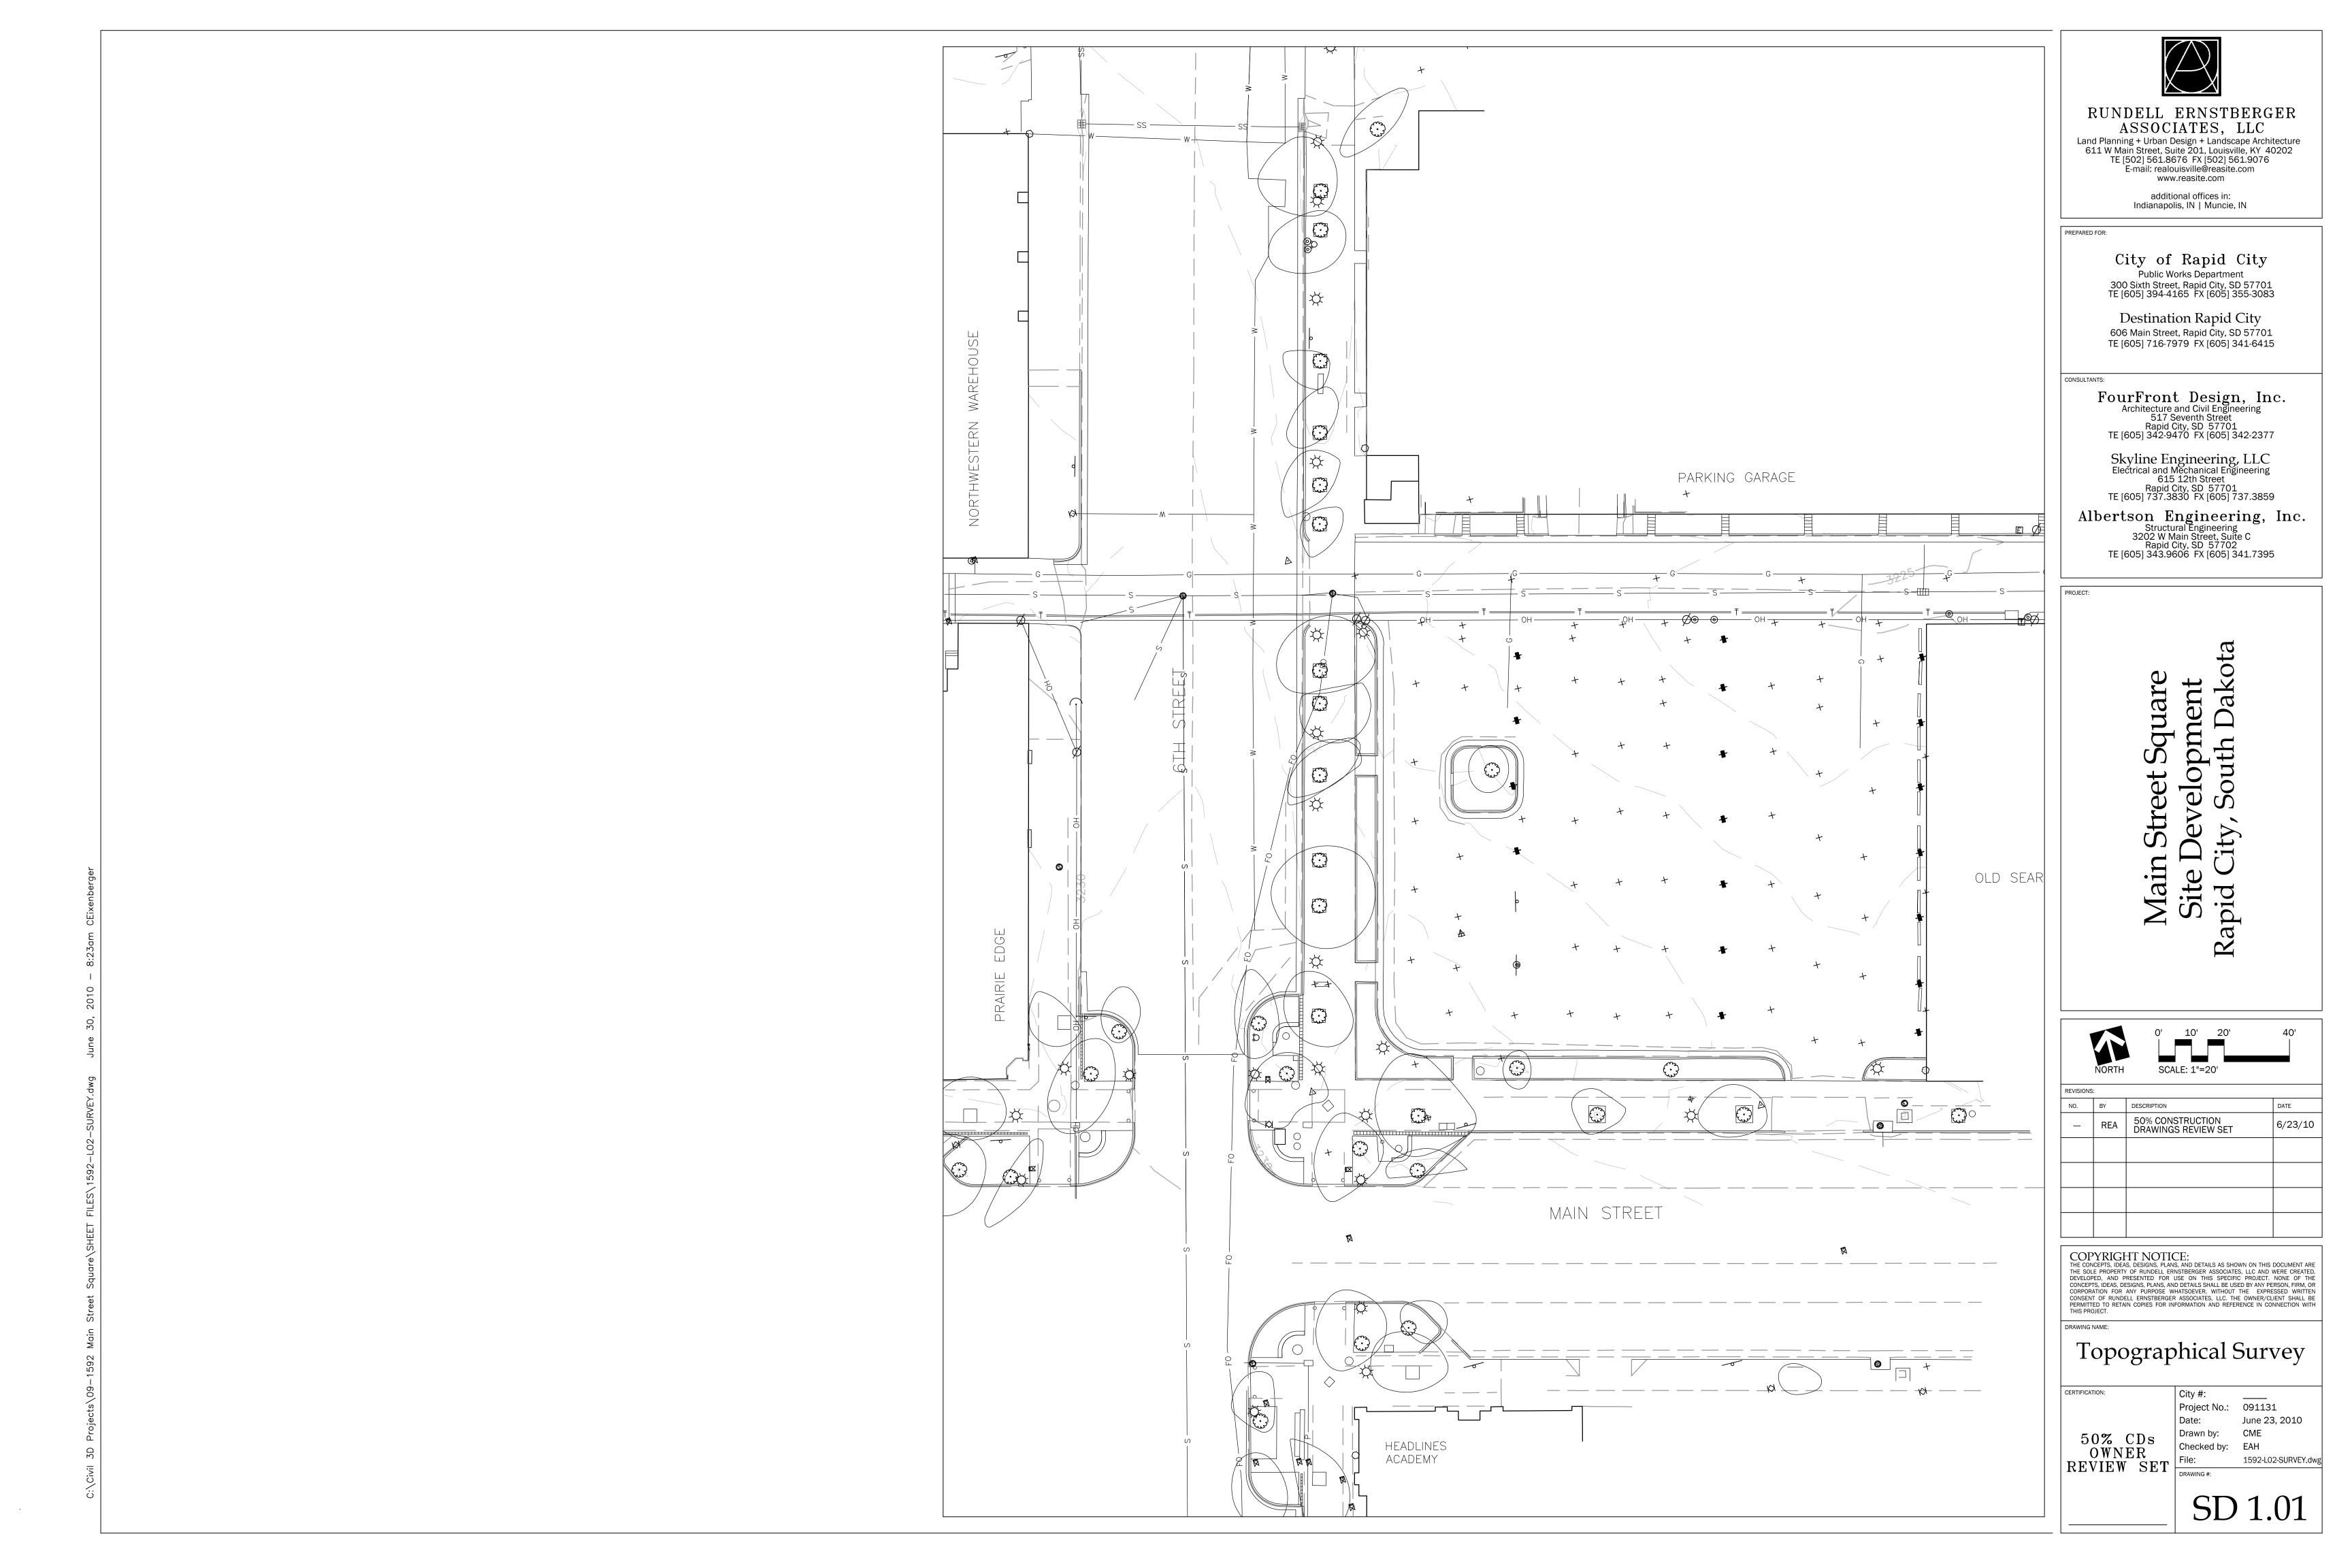



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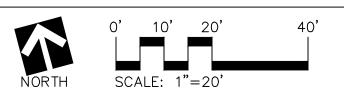
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#### Demolition Plan

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Project No.: 091131 June 23, 2010 Date: Drawn by: CME Checked by: EAH 1592-L02-DEMO01.dwg | REVIEW SET | DRAWING #:

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CONTRACTOR SHALL ADHERE TO THE RECOMMENDATIONS OF THE GEOTECHNICAL ENGINEERING REPORT FOR THIS PROJECT PREPARED BY TERRACON CONSULTING, INC. AND DATED JULY 17, 2009 AND ANY ADDENDUMS. THE CONTRACTOR SHALL CONSTRUCT THE SITE IMPROVEMENTS BASED UPON THE APPROVED PLANS AND SPECIFICATIONS. THE GEOTECHNICAL ENGINEER REPORT SHALL BE USED AS A REFERENCE ONLY. IF ANY CONFLICTS OR DISCREPANCIES OCCUR, CONTACT THE ARCHITECT/ENGINEER FOR DIRECTION.

CONTRACTOR SHALL UTILIZE THE SOUTH DAKOTA ONE CALL NOTIFICATION PROCESS TO PROVIDE ADVANCE NOTICE FOR ALL UTILITY LOCATIONS 48 HOURS PRIOR TO BEGINNING CONSTRUCTION.

ALL ASPHALT AND CONCRETE TO BE REMOVED SHALL BE SAW CUT FULL DEPTH.

ALL SALVAGED MATERIALS SHALL BE THE PROPERTY OF THE OWNER UNLESS OTHERWISE NOTED. CONTRACTOR SHALL TRANSPORT OWNER SALVAGED MATERIALS TO STORAGE AREA. ALL OTHER MATERIALS NOT WANTED BY OWNER SHALL BE HAULED AND DISPOSED OF OFF-SITE BY CONTRACTOR.

A STAGING/STOCKPILE AREA FOR MATERIALS AND/OR EQUIPMENT IS PROVIDED AND SHOWN ON THE PLANS. THE AREA ON-SITE IS VERY LIMITED AND SOME STOCKPILING OF MATERIALS MAY BE REQUIRED OFF-SITE. THE CONTRACTOR IS RESPONSIBLE FOR THE SECURITY AND PROTECTION OF ALL STORED MATERIALS. THE CONTRACTOR SHALL RECLAIM THE DISTURBED AREA(S) TO THE SATISFACTION OF THE OWNER AND ENGINEER.

CONTRACTOR SHALL MAINTAIN STORMSEWER PROFILES AS SHOWN ON THE PLANS UNLESS OTHERWISE APPROVED BY THE ENGINEER.

ALL DISTURBED AREAS SHALL BE RESTORED TO THEIR ORIGINAL CONDITION AFTER TRENCHING AND BACKFILL.

IF WATER FROM TEMPORARY DE-WATERING WILL BE DISCHARGED TO WATERS OF THE STATE DURING CONSTRUCTION, CONTRACTOR MUST FIRST GET COVERAGE UNDER THE DEPARTMENT'S GENERAL PERMIT FOR TEMPORARY DE-WATERING. FOR MORE INFORMATION CONTACT AL SPANGLER AT (605) 773-3351.

THE CONTRACTOR WILL BE REQUIRED TO OBTAIN COVERAGE UNDER THE DEPARTMENT'S GENERAL STORMWATER CONSTRUCTION PERMIT, SINCE THE PROJECT WILL DISTURB 1 ACRE OR MORE IN LAND AREA. CONTACT SD D.E.N.R. AT 1-800-737-8676 FOR INFORMATION. THE CONTRACTOR WILL ALSO NEED TO COMPLY WITH "CHAPTER 1 — EROSION AND SEDIMENT CONTROL" FROM THE CITY OF RAPID CITY'S STORMWATER QUALITY MANUAL.

ADEQUATE PROVISIONS SHALL BE MADE FOR MAINTAINING THE FLOW OF DRAINS AND WATER COURSES ENCOUNTERED DURING ANY CONSTRUCTION. CULVERTS, DITCHES AND STRUCTURES WHICH ARE DISTURBED BY THIS CONSTRUCTION SHALL BE SATISFACTORILY RESTORED TO THEIR ORIGINAL CONDITION UPON COMPLETION OF THE WORK.

TRAFFIC CONTROL SHALL BE IN ACCORDANCE WITH THE MUTCD.

ALL POROUS LANDSCAPE DETENTION AREA (PLDs) MUST BE CONSTRUCTED AFTER ASPHALT AND CURB

AND GUTTER IS COMPLETE TO PREVENT SILT FROM PLUGGING THE PLD.

#### **EXCAVATION NOTES:**

THE CONTRACTOR SHALL BE RESPONSIBLE TO INSURE THAT ALL EXCAVATION, TRENCHING AND SHORING, AND THE LIKE SHALL BE PERFORMED IN A MANNER THAT MEETS WITH THE OSHA DEPARTMENT OF LABOR, SAFETY AND HEALTH REGULATIONS FOR CONSTRUCTION AND STANDARD SPECIFICATIONS. THE CONTRACTOR SHALL PROVIDE A DESIGN PREPARED BY A REGISTERED PROFESSIONAL ENGINEER FOR A SHORING/PROTECTION SYSTEM FOR ALL EXCAVATIONS GREATER THAN 20' OF DEPTH OR WHERE EXISTING FOUNDATIONS WILL BE IMPACTED.

GRADING SHALL BE DONE AS MAY BE NECESSARY TO PREVENT SURFACE WATER FROM FLOWING INTO EXCAVATIONS AND ANY OTHER WATER ACCUMULATING THEREIN SHALL BE PROMPTLY REMOVED. UNDER NO CIRCUMSTANCES SHALL WATER BE PERMITTED TO RISE IN UNBACKFILLED TRENCHES. ANY PIPE HAVING ITS ALIGNMENT OR GRADE CHANGED AS A RESULT OF A FLOODED TRENCH SHALL BE RELAID AT NO ADDITIONAL COST TO THE OWNER.

THE BOTTOM OF THE TRENCHES SHALL BE ACCURATELY GRADED TO THE LINE AND GRADE SHOWN ON THE DRAWINGS. BEDDING MATERIAL SHALL BE COMPACTED TO PROVIDE UNIFORM BEARING AND SUPPORT FOR EACH SECTION OF THE PIPE AT EVERY POINT ALONG ITS ENTIRE LENGTH. BELL HOLES AND DEPRESSIONS FOR JOINTS SHALL BE DUG AFTER THE TRENCH BEDDING HAS BEEN GRADED, AND SHALL BE ONLY OF SUCH LENGTH, DEPTH AND WIDTH AS REQUIRED FOR PROPERLY MAKING THE PARTICULAR TYPE JOINT.

TRENCH DEPTH SHALL BE AS REQUIRED FOR THE INVERT GRADE OR PIPE BURY. CARE SHALL BE TAKEN NOT TO EXCAVATE BELOW THE REQUIRED DEPTH. UNAUTHORIZED OVER DEPTHS SHALL BE BACKFILLED WITH BEDDING MATERIAL AT THE CONTRACTOR'S EXPENSE.

WHEN SOFT OR UNSTABLE MATERIAL IS ENCOUNTERED AT THE SUBGRADE WHICH WILL NOT UNIFORMLY SUPPORT THE PIPE, SUCH MATERIAL SHALL BE EXCAVATED TO AN ADDITIONAL DEPTH AS DIRECTED BY THE ENGINEER AND BACKFILLED WITH TYPE 2 FOUNDATION MATERIAL.

#### MATERIALS NOTES:

THE CONTRACTOR SHALL FURNISH A CERTIFICATION BY THE MANUFACTURER OF THE PIPE TO BE FURNISHED ON THIS PROJECT, CERTIFYING THAT THE PIPE AND FITTINGS COMPLY WITH THE APPLICABLE SPECIFICATIONS.

ALL PIPE SHALL BE CLEARLY MARKED WITH TYPE, CLASS AND/OR THICKNESS AS APPLICABLE. LETTERING SHALL BE LEGIBLE AND PERMANENT UNDER NORMAL CONDITIONS OF HANDLING AND

THE CONTRACTOR SHALL BE RESPONSIBLE FOR ALL MATERIALS FURNISHED BY THEM AND SHALL REPLACE AT THEIR OWN EXPENSE ALL SUCH MATERIAL FOUND DEFECTIVE IN MANUFACTURE OR DAMAGED IN HANDLING AFTER DELIVERY BY THE MANUFACTURER. THIS SHALL INCLUDE THE FURNISHING OF ALL MATERIALS AND LABOR REQUIRED FOR THE REPLACEMENT OF INSTALLED MATERIAL DISCOVERED, DAMAGED OR DEFECTIVE PRIOR TO THE FINAL ACCEPTANCE OF THE WORK OR DURING THE GUARANTEE PERIOD.

#### PIPE INSTALLATION NOTES:

PIPE SHALL BE INSTALLED AND EMBEDDED IN ACCORDANCE WITH THE STANDARD SPECIFICATIONS, AND APPLICABLE MANUFACTURER'S RECOMMENDATIONS FOR INSTALLING THE TYPE OF PIPE USED UNLESS MODIFIED OR CHANGED ON THE DRAWINGS. THE CONTRACTOR SHALL PROVIDE ALL TOOLS AND EQUIPMENT INCLUDING ANY SPECIAL TOOLS DESIGNED FOR INSTALLING EACH PARTICULAR TYPE OF PIPE USED.

WHERE WATER IS ENCOUNTERED IN THE TRENCH, IT SHALL BE REMOVED DURING PIPE LAYING OPERATIONS AND THE TRENCH SO MAINTAINED UNTIL THE ENDS OF THE PIPE ARE SEALED AND PROVISIONS ARE MADE TO PREVENT FLOATING OF THE PIPE.

BEFORE INSTALLATION, THE PIPE, FITTINGS AND FITTING COATING SHALL BE INSPECTED FOR DEFECTS. ANY DAMAGE TO PIPE COATINGS SHALL BE REPAIRED WITH THE SAME MATERIALS USED FOR THE ORIGINAL COATING BEFORE LAYING THE PIPE PER MANUFACTURERS RECOMMENDATIONS FOR REPAIR.

ALL PIPE SHALL BE LAID AND MAINTAINED TO THE REQUIRED LINES AND GRADES WITH FITTINGS AND VALVES AT THE REQUIRED LOCATIONS.

EVERY PRECAUTION SHALL BE TAKEN TO PREVENT FOREIGN MATERIAL FROM ENTERING THE PIPE WHILE IT IS BEING PLACED IN THE LINE. DURING LAYING OPERATIONS, NO DEBRIS, TOOLS, CLOTHING OR OTHER MATERIALS SHALL BE PLACED IN THE PIPE. AT TIMES WHEN PIPE LAYING IS NOT IN PROGRESS, THE OPEN ENDS OF THE PIPE SHALL BE CLOSED BY A WATERTIGHT PLUG OR OTHER MEANS APPROVED BY THE ENGINEER.

**BACKFILL NOTES:** 

TYPE 2 FOUNDATION MATERIAL SHALL BE PIT RUN ROCK NO LARGER THAN THREE (3") INCH IN SIZE, PLACED BELOW THE PIPE OR CONDUIT. BEDDING MATERIAL SHALL BE PLACED IN THE TRENCH FOR ITS FULL WIDTH ON EACH SIDE SIMULTANEOUSLY. THE MAXIMUM DIFFERENCE OF ELEVATION BETWEEN EACH SIDE OF THE PIPE AT ANYTIME SHALL BE SIX (6) INCHES..

BEDDING MATERIAL SHALL BE DISTRIBUTED BY HAND IN MAXIMUM LAYERS OF SIX (6) INCHES AND THOROUGHLY COMPACTED BY TAMPING. SPECIAL CARE SHALL BE TAKEN TO ASSURE COMPLETE COMPACTION UNDER THE HAUNCHES OF THE PIPE.

THE OWNER SHALL BE RESPONSIBLE FOR PAYMENT OF ALL TESTING REQUIRED FOR CONSTRUCTION. THE CONTRACTOR SHALL BE RESPONSIBLE FOR THE COORDINATION OF ALL TESTING.

#### DE-WATERING PERMIT:

DE-WATERING OF TRENCHES AND RELATED EXCAVATIONS MAY BE REQUIRED ON THIS PROJECT. DE-WATERING ACTIVITIES SHALL BE CONDUCTED IN ACCORDANCE WITH THE STANDARD SPECIFICATIONS SECTION 11.3 AND IN ACCORDANCE WITH THE FOLLOWING ADDITIONAL REQUIREMENTS.

DE-WATERING ACTIVITIES SHALL BE CONDUCTED IN COMPLIANCE WITH THE "GENERAL PERMIT TO DISCHARGE UNDER THE SURFACE WATER DISCHARGE SYSTEM FOR TEMPORARY DE-WATERING ACTIVITIES IN SOUTH DAKOTA", SD D.E.N.R. PERMIT NO. S.D.G. 070000. THE CONTRACTOR IS REQUIRED TO FURNISH THE "REQUEST FOR AUTHORIZATION" TO SD D.E.N.R. REQUIRED UNDER THE PERMIT AND TO OBTAIN SD D.E.N.R. AUTHORIZATION AND FURNISH A COPY TO THE OWNER AND CITY PRIOR TO CONDUCTING ANY DE-WATERING ACTIVITIES.

THE CONTRACTOR SHALL BE RESPONSIBLE FOR PERFORMING SELF-MONITORING ACTIVITIES INCLUDING SAMPLING, TESTING, AND REPORTING AS MAY BE DETERMINED TO BE REQUIRED UNDER THE AUTHORIZATION TO DISCHARGE.

#### CONSTRUCTION NOTES:

FOURFRONT DESIGN, INC. SHALL PROVIDE SURVEY CONTROL FOR THIS PROJECT AND THE CONTRACTOR SHALL PROVIDE DETAILED CONSTRUCTION STAKING. A REGISTERED LAND SURVEYOR SHALL OVERSEE THE STAKING OF THE PROPOSED

THE INFORMATION ON THESE DRAWINGS CONCERNING THE TYPE, SIZE, AND LOCATION OF UTILITIES HAS BEEN BASED UPON THE BEST INFORMATION AVAILABLE. THE CONTRACTOR SHALL BE RESPONSIBLE FOR THE DETERMINATION OF THE EXACT LOCATION SIZES AN TYPE OF ALL UTILITIES PRIOR TO ORDERING MATERIALS. THE CONTRACTOR SHALL BE RESPONSIBLE FOR PROTECTION OF ALL UTILITIES IN PLACE. THE CONTRACTOR SHALL COORDINATE ALL UTILITY RELOCATIONS WITH THE APPROPRIATE UTILITY COMPANY.

ELECTRICAL, TELEPHONE, CABLE TELEVISION, AND GAS UTILITIES MAY BE ADJUSTED AND/OR RELOCATED BY THE RESPECTIVE UTILITY COMPANY UPON APPROVAL OF THE ENGINEER.

ALL UTILITY COMPANIES SHALL BE CONTACTED BY THE CONTRACTOR PRIOR TO THE COMMENCEMENT OF SUBSURFACE WORK.

UTILITIES:

SOUTH DAKOTA ONE CALL: 1-800-781-7474

1-800-573-1311

BLACK HILLS POWER & LIGHT 409 DEADWOOD AVENUE 605-342-3200

SEWER, WATER: CITY OF RAPID CITY 605 STEELE AVENUE 605-394-4163

MONTANA-DAKOTA UTILITIES 705 KANSAS CITY STREET 605-342-0160

FIBER OPTICS, CABLE **TELEVISION:** KNOLOGY 909 DEADWOOD AVENUE 605-721-2000

MIDCONTINENT COMMUNICATIONS 1301 W. OMAHA STREET 800-888-1300

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General Notes


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Project No.: 091131 Date: REVIEW SET DRAWING #:

June 23, 2010 CME Drawn by: Checked by: EAH 1592-L02-NOTE01.dwg

#### SITE DEVELOPMENT & LAYOUT NOTES

- 1. CONTRACTOR TO VERIFY EXISTING CONDITIONS. ALL EXISTING UTILITIES ARE TO BE LOCATED BEFORE ANY EXCAVATION
- 2. PROTECT ALL EXISTING IMPROVEMENTS TO REMAIN AND REPAIR BACK TO ORIGINAL CONDITION AT CONTRACTOR'S EXPENSE IF DAMAGE OCCURS RESULTANT FROM CONTRACTOR'S OPERATIONS OR NEGLIGENCE.
- 3. GENERAL CONTRACTOR'S SURVEYOR WILL BE PROVIDED WITH DIGITAL CADD FILES FOR USE IN ESTABLISHING SURVEY POINTS FOR CONSTRUCTION. SURVEYOR TO COORDINATE WITH 4FRONT DESIGN, INC. TO RECEIVE "READ ONLY" CADD FILES FOR USE IN STAKING AND/OR CONTRACTOR AS BUILTS.
- 4. GENERAL CONTRACTOR TO COORDINATE WORK ON THIS SHEET WITH ALL NECESSARY TRADES. COORDINATION WILL NOT BE THE RESPONSIBILITY OF DESIGN PROFESSIONAL.
- 5. CONTRACTOR TO COORDINATE LAYOUT AND SITE DEVELOPMENT WITH DEMOLITION PLANS AND DETAILS. (IF APPLICABLE)
- CONTRACTOR TO COORDINATE SITE DEVELOPMENT WILL ALL TEMPORARY STRUCTURES, (IF APPLICABLE) CONTRACTOR TO COORDINATE SITE DEVELOPMENT WITH ALL OTHER CONTRACT DOCUMENTS, AND COORDINATE WITH GOVERNMENTAL/JURISDICTIONAL AGENCIES DURING PERMITTING AND CONSTRUCTION PROCESS.
- 8. CONTRACTOR TO INSTALL IRRIGATION SLEEVES AS INDICATED AS WELL AS COORDINATE WITH IRRIGATION & CIVIL
- DRAWINGS AND SPECIFICATIONS AND FLAG/LOCATE THE SLEEVES FOR IRRIGATION CONTRACTOR.
- 9. CONTRACTOR TO COORDINATE SITE DEVELOPMENT WITH PLANTING PLANS AND DETAILS. (IF APPLICABLE)
- 10. CLARIFICATIONS TO BE REQUESTED IN WRITING BY DESIGN PROFESSIONAL VIA STANDARD PROTOCOLS. 11. CONTRACTOR TO PROVIDE WARRANTY PERIOD AS INDICATED IN CONTRACT DOCUMENTS ALL WORK SHOWN OR IMPLIED.
- 12. CONTRACTOR TO COORDINATE WITH OWNER/OWNER REPRESENTATIVE DURING CONSTRUCTION PERIOD.
- 13. DIGITAL INFORMATION FOR SITE LAYOUT TO BE SUPPLIED TO CONTRACTOR FOR LAYOUT PURPOSES. COORDINATION WITH CONTRACTORS SURVEYOR AND 4FRONT DESIGN, INC. TO BE FACILITATED POST BID.
- (1) PROPOSED CURB AND GUTTER
- (2) PROPOSED LOADING ZONE
- 3 PROPOSED 20' CONCRETE DRIVEWAY APPROACH INSTALL ON 6TH STREET RECONSTRUCTION PROJECT.
- (4) PROPOSED HANDICAP RAMP
- 5) PROPOSED PARKING RAMP ENTRANCE
- 6 PROPOSED 4" WATER SERVICE, COORDINATE WITH THE 6TH STREET RECONSTRUCTION PROJECT
- 7 PROPOSED 4" SANITARY SEWER SERVICE, CONNECT TO EXISTING 12" SANITARY SEWER MAIN
- 8 PROPOSED SIDEWALK AND WHEEL STOPS ADJACENT TO PARKING RAMP.
- 9 PROPOSED 18" RCP STORM SEWER CONNECT TO EXISTING STORM SEWER INLET
- 10 PROPOSED 6TH STREET IMPROVEMENTS
- (1) PROJECT LIMITS
- 12) PROPOSED SQUARE IMPROVEMENTS SEE LANDSCAPE SHEETS
- (13) EXISTING SEARS BUILDING DO NOT DISTURB
- (14) PROPOSED TYPE B INLET
- 15) PROPOSED 18" RCP W/2-45" BENDS. CONNECT TO EXISTING STORM SEWER
- (6) PROPOSED CONCRETE PAVEMENT
- 17 PROPOSED BOLLARDS
- (18) PROPOSED 12' ROW VACATION LOCATION
- (19) PROPOSED BRICK PAVERS SEE LANDSCAPE SHEETS
- (20) PROPOSED 12" PVC STORM SEWER
- (21) PROPOSED SCUPPER INLET
- (22) CONNECT 12" PVC STORM SEWER TO PROPOSED AREA INLET IN ALLEY
- 23 PROPOSED ALLEY AREA INLET
- (24) CONNECT PROPOSED 12" PVC STORM SEWER TO PROPOSED ZAMBONI DRAIN SEE MECHANICAL SHEETS



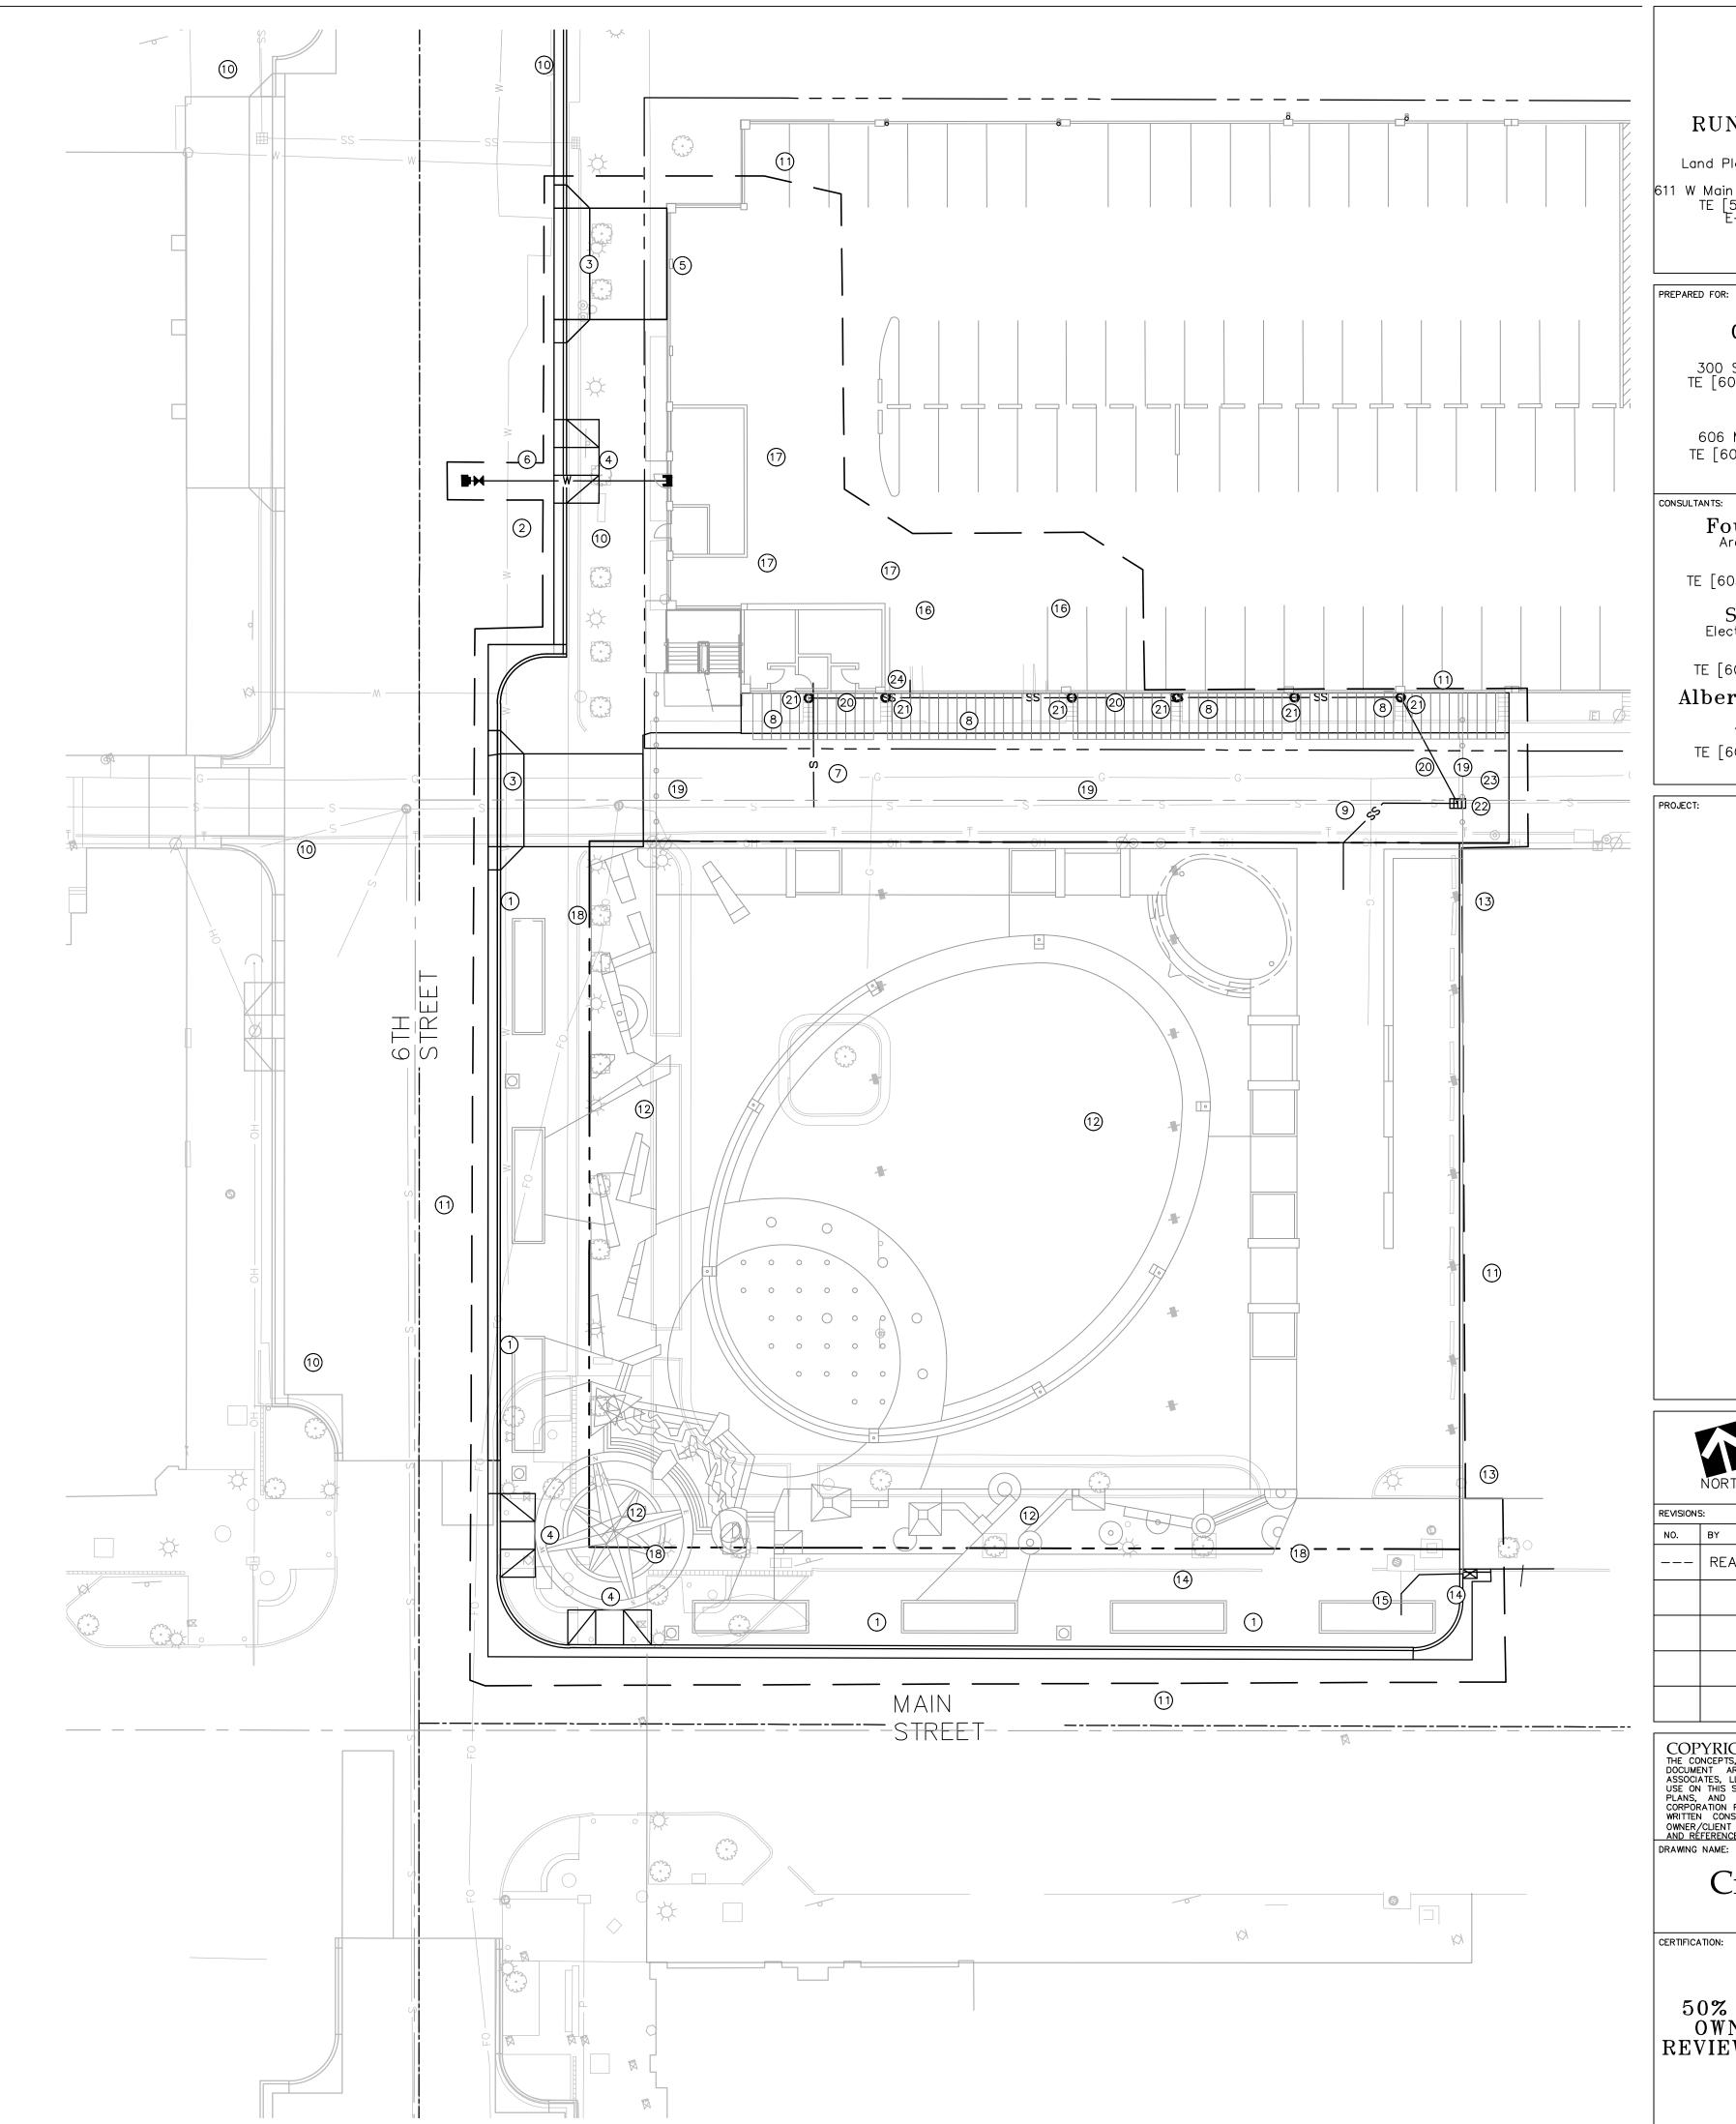

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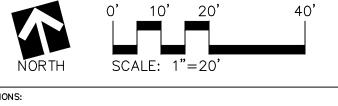
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Civil Layout Plan


Project No.: 091131 June 23, 2010  $\begin{array}{c|c} 50\% & CDs \\ OWNER \\ REVIEW & SET \end{array} \begin{array}{c} \text{Drawn by:} \\ \text{Checked b:} \\ \text{File:} \\ \\ \text{DRAWING $\#$:} \end{array}$ Drawn by: CME Checked by: EAH 1592-L02-SITE01.dwg

#### LAYOUT GENERAL NOTES:

- 1. SITE LAYOUT DATA, INCLUDING COORDINATE POINTS, IS BASED ON A SURVEY PERFORMED . REFER TO \_\_\_\_\_ FOR HORIZONTAL LAYOUT CONTROL POINTS. REPORT ANY DISCREPANCIES BETWEEN PLANS AND FIELD CONDITIONS TO OWNER AND LANDSCAPE ARCHITECT IMMEDIATELY.
- 2. UNLESS NOTED OTHERWISE, ALL DIMENSIONS ARE TO THE FOLLOWING: FACE OF WALL, FACE OF BUILDING, FACE OF GUTTER, EDGE OF PAVEMENT, CENTERLINE OF PAVEMENT
- 3. ALL EDGES OF PAVEMENTS ARE TO BE STRAIGHT (OR OF CONSISTENT RADIUS IN THE CASE OF CURVES) AS SHOWN HEREON; NO UNSPECIFIED TANGENTS OR KINKS WILL BE APPROVED.
- 4. ALL CONSTRUCTION LAYOUT STAKING IS TO BE PERFORMED BY A LAND SURVEYOR OR PROFESSIONAL ENGINEER REGISTERED IN THE STATE OF SOUTH DAKOTA. TO FACILITATE ACCURACY IN CONSTRUCTION STAKING, UPON WRITTEN REQUEST FROM CONTRACTOR, A CD CONTAINING THE ELECTRONIC DATA COMPRISING THESE SITE DEVELOPMENT DRAWINGS WILL BE FORWARDED FROM THE LANDSCAPE ARCHITECT TO THE LAND SURVEYOR OR PROFESSIONAL ENGINEER EMPLOYED TO PERFORM CONSTRUCTION STAKING.
- 5. IN ORDER TO MAINTAIN THE INTEGRITY OF HORIZONTAL AND VERTICAL CONTROL FOR THE SITE, THE SURVEYOR OR PROFESSIONAL ENGINEER EMPLOYED BY THE CONTRACTOR TO PERFORM CONSTRUCTION LAYOUT STAKING SHALL SET AND PROTECT ADDITIONAL TRAVERSE POINTS OUTSIDE THE AREAS OF CONSTRUCTION ACTIVITY.
- 6. AS SOME OF THE HORIZONTAL CONTROL POINTS SHOWN ON THESE PLANS AS EXISTING MAY HAVE BEEN REMOVED OR DAMAGED SINCE THEY WERE SET, THE CONTRACTOR SHALL, DURING THE BIDDING PROCESS, VERIFY THE EXISTENCE AND INTEGRITY OF THE HORIZONTAL CONTROL POINTS SHOWN HEREON. THE CONTRACTOR SHALL INCLUDE ANY WORK NECESSARY TO ESTABLISH RELIABLE LAYOUT CONTROL FOR THE PROJECT IN THE BID.
- 7. REFER TO SHEET SD 4.0 SITE GRADING PLAN FOR VERTICAL LAYOUT DATA.

#### LAYOUT KEYNOTES:

- PLANT BED OR LAWN AREA REFER TO SHEET SD 6.0
- CONCRETE CURB AND GUTTER REFER TO DETAIL \_, SHEET SD 5.1
- CONCRETE BARRIER CURB
  REFER TO DETAIL \_, SHEET SD 5.1
- CONCRETE PAVEMENT, VEHICULAR REFER TO DETAIL \_, SHEET SD 5.1
- BRICK PAVEMENT, VEHICULAR REFER TO DETAIL \_, SHEET SD 5.1
- 6 CONCRETE SIDEWALK REFER TO DETAIL \_, SHEET SD 5.1
- 7 PRECAST PAVERS ON SUBSLAB REFER TO DETAIL \_, SHEET SD 5.1
- 8 BRICK PAVERS ON SUBSLAB REFER TO DETAIL \_, SHEET SD 5.1
- 9 CRUSHED GRANITE PAVEMENT REFER TO DETAIL \_, SHEET SD 5.1
- BADLANDS STONE TAPESTRY
  REFER TO PLAN ENLARGEMENT, SHEET SD 3.2
- BLACK HILLS STONE TAPESTRY REFER TO PLAN ENLARGEMENT, SHEET SD 3.2
- WAYFINDING PLAZA AND CASCADE FOUNTAIN REFER TO PLAN ENLARGEMENT, SHEET SD 3.2
- STAGE REFER TO PLAN ENLARGEMENT, SHEET SD 3.2
- RETAINING WALL AT SEARS BUILDING REFER TO DETAIL \_, SHEET SD 5.2
- SEATWALL REFER TO DETAIL \_, SHEET SD 5.2
- PLANTER CURB
  REFER TO DETAIL \_, SHEET SD 5.1
- GRANITE LIGHT POLE PIER REFER TO DETAIL \_, SHEET SD 5.2
- 18 INTERACTIVE FOUNTAIN REFER TO FOUNTAIN SHEETS
- LAWN STEPS
  REFER TO DETAIL \_\_\_, SHEET SD 5.2
- CURB RAMP, TYPE 1
  REFER TO DETAIL \_\_\_, SHEET SD 5.1
- BOLLARD, EMBEDDED
  REFER TO DETAIL \_\_, SHEET SD 5.1
- BOLLARD, REMOVABLE REFER TO DETAIL \_\_, SHEET SD 5.1

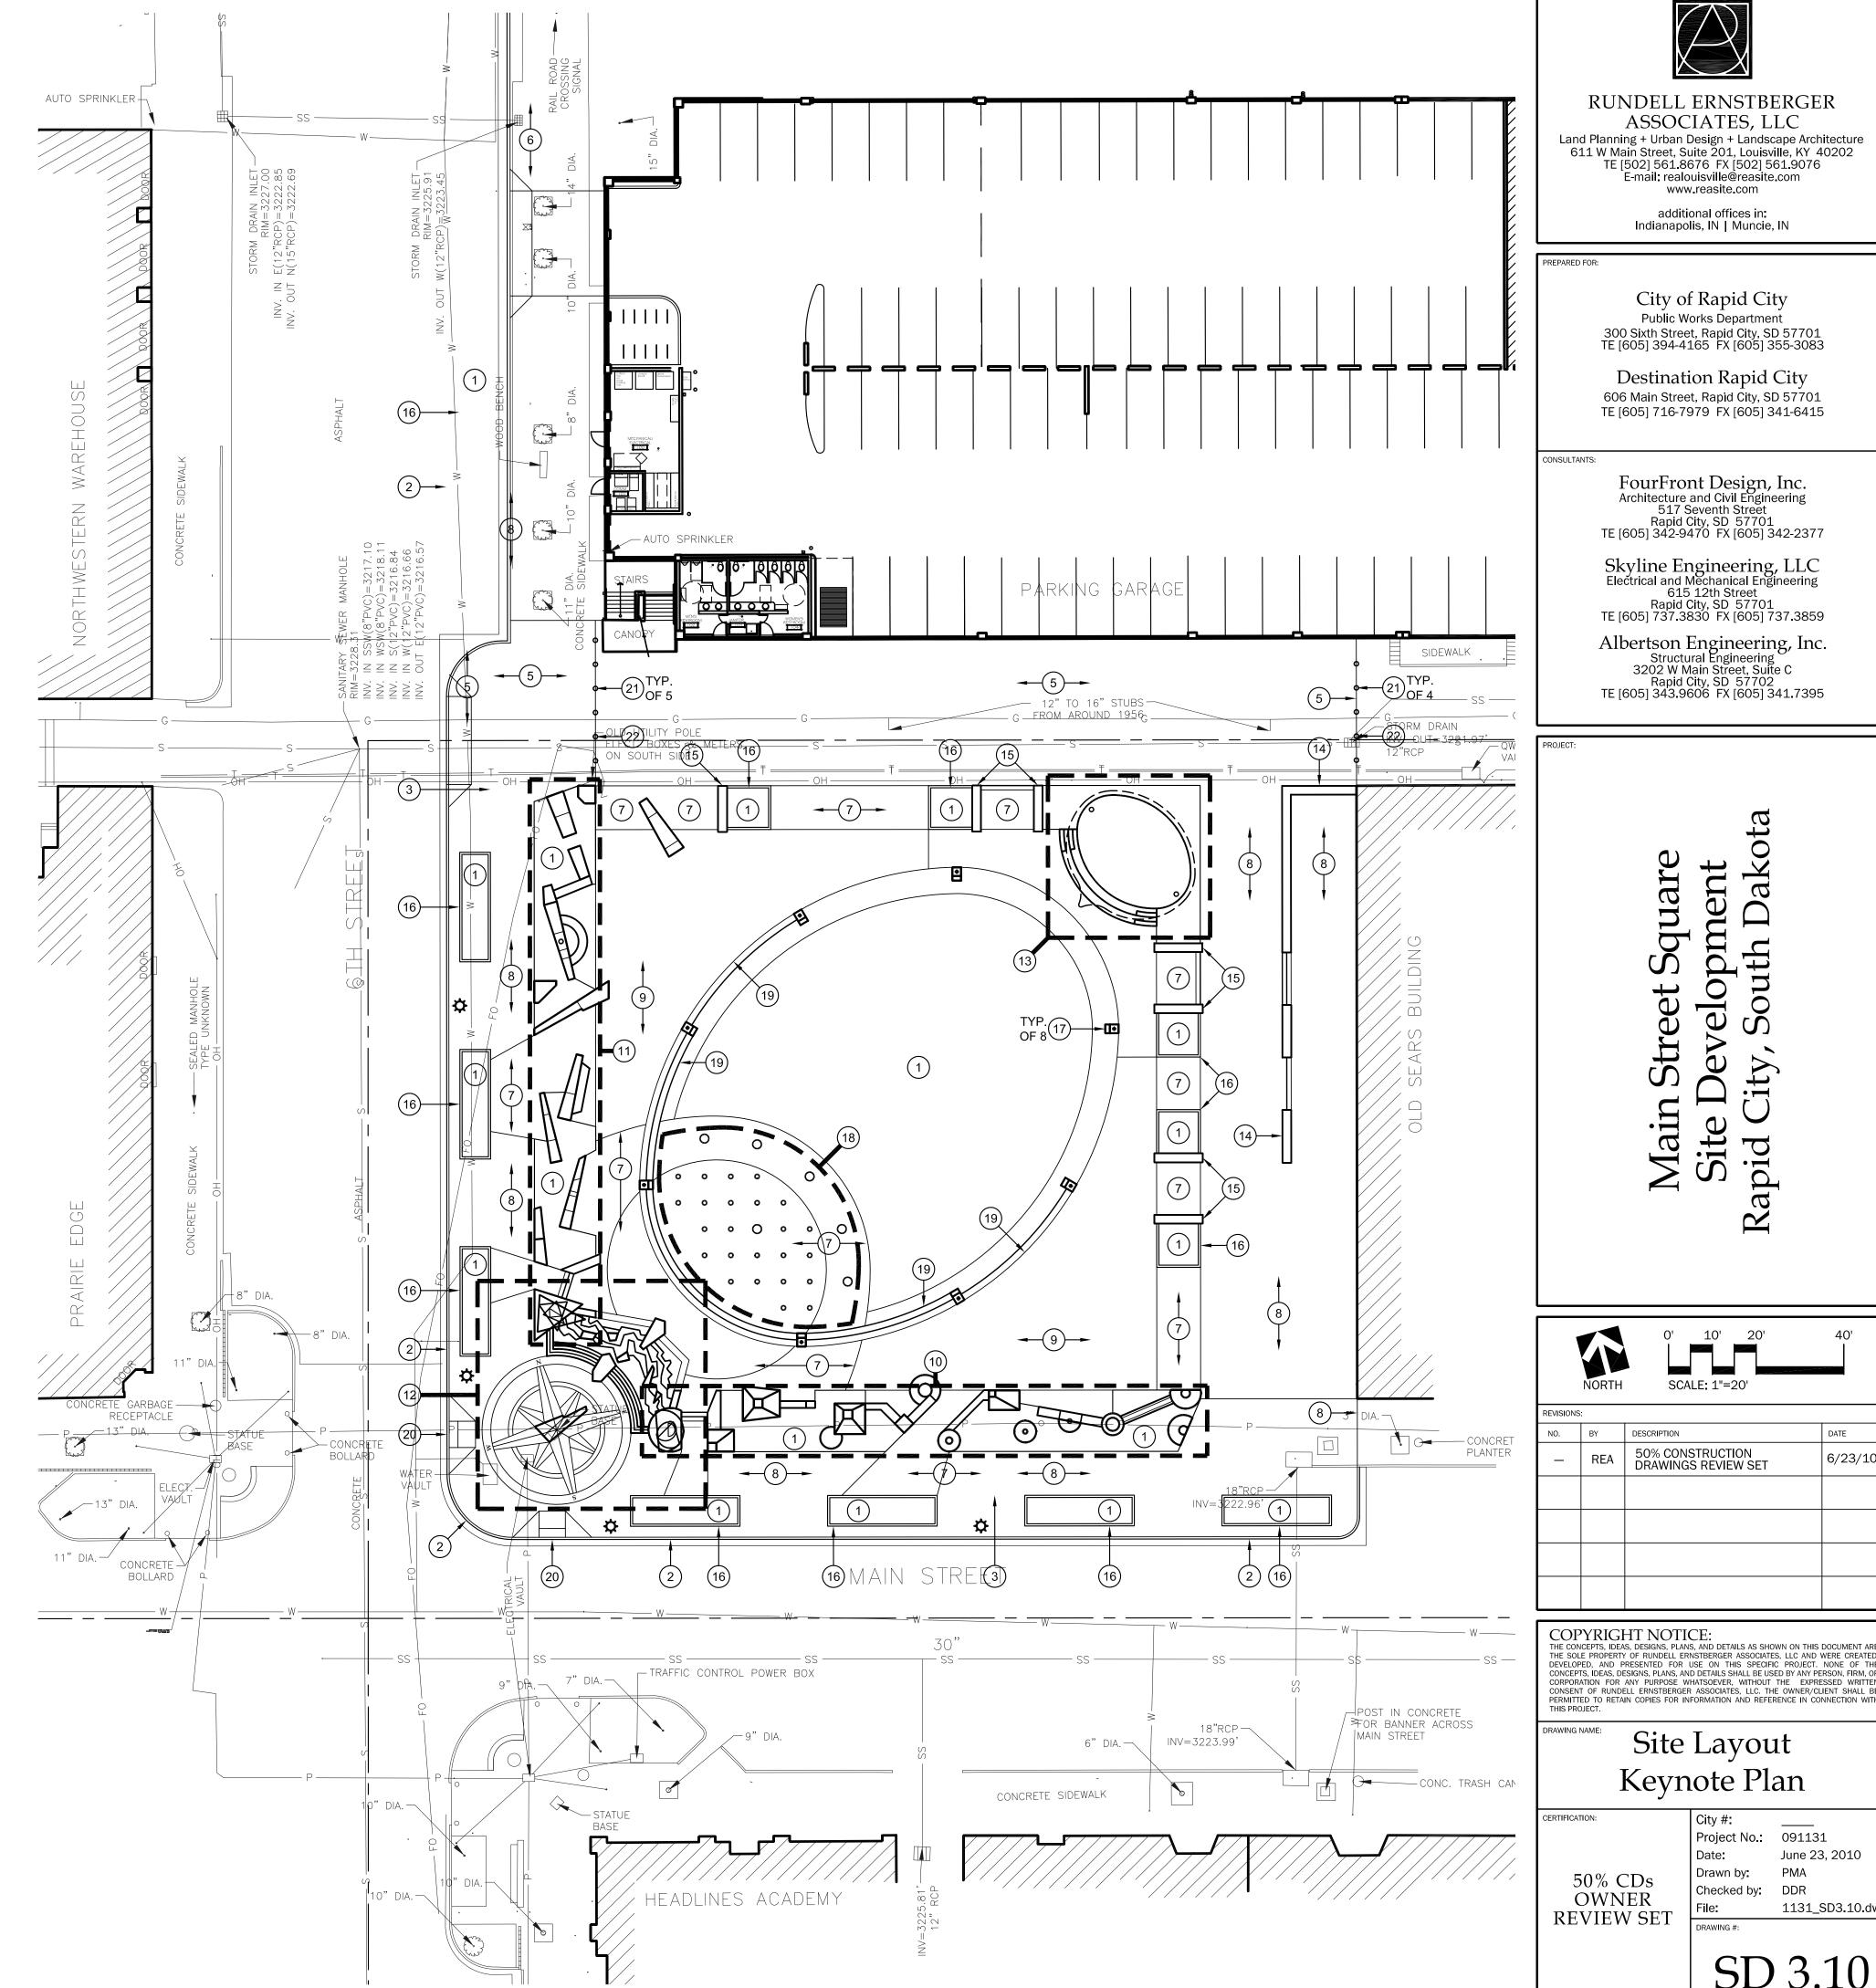



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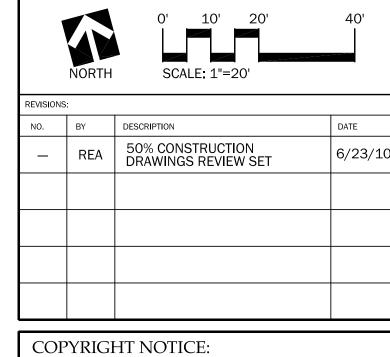
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#### LAYOUT GENERAL NOTES:

- 1. SITE LAYOUT DATA, INCLUDING COORDINATE POINTS, IS BASED ON A SURVEY PERFORMED BY \_\_\_\_\_\_. REFER TO \_\_\_\_\_ FOR HORIZONTAL LAYOUT CONTROL POINTS. REPORT ANY DISCREPANCIES BETWEEN PLANS AND FIELD CONDITIONS TO OWNER AND LANDSCAPE ARCHITECT IMMEDIATELY.
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- 7. REFER TO SHEET SD 4.0 SITE GRADING PLAN FOR VERTICAL LAYOUT DATA.



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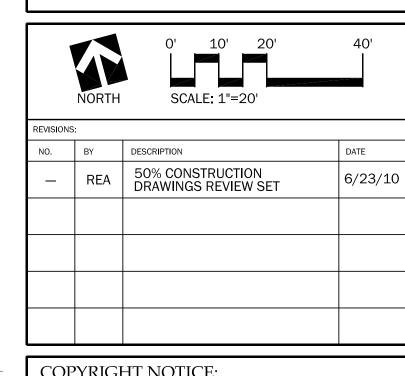
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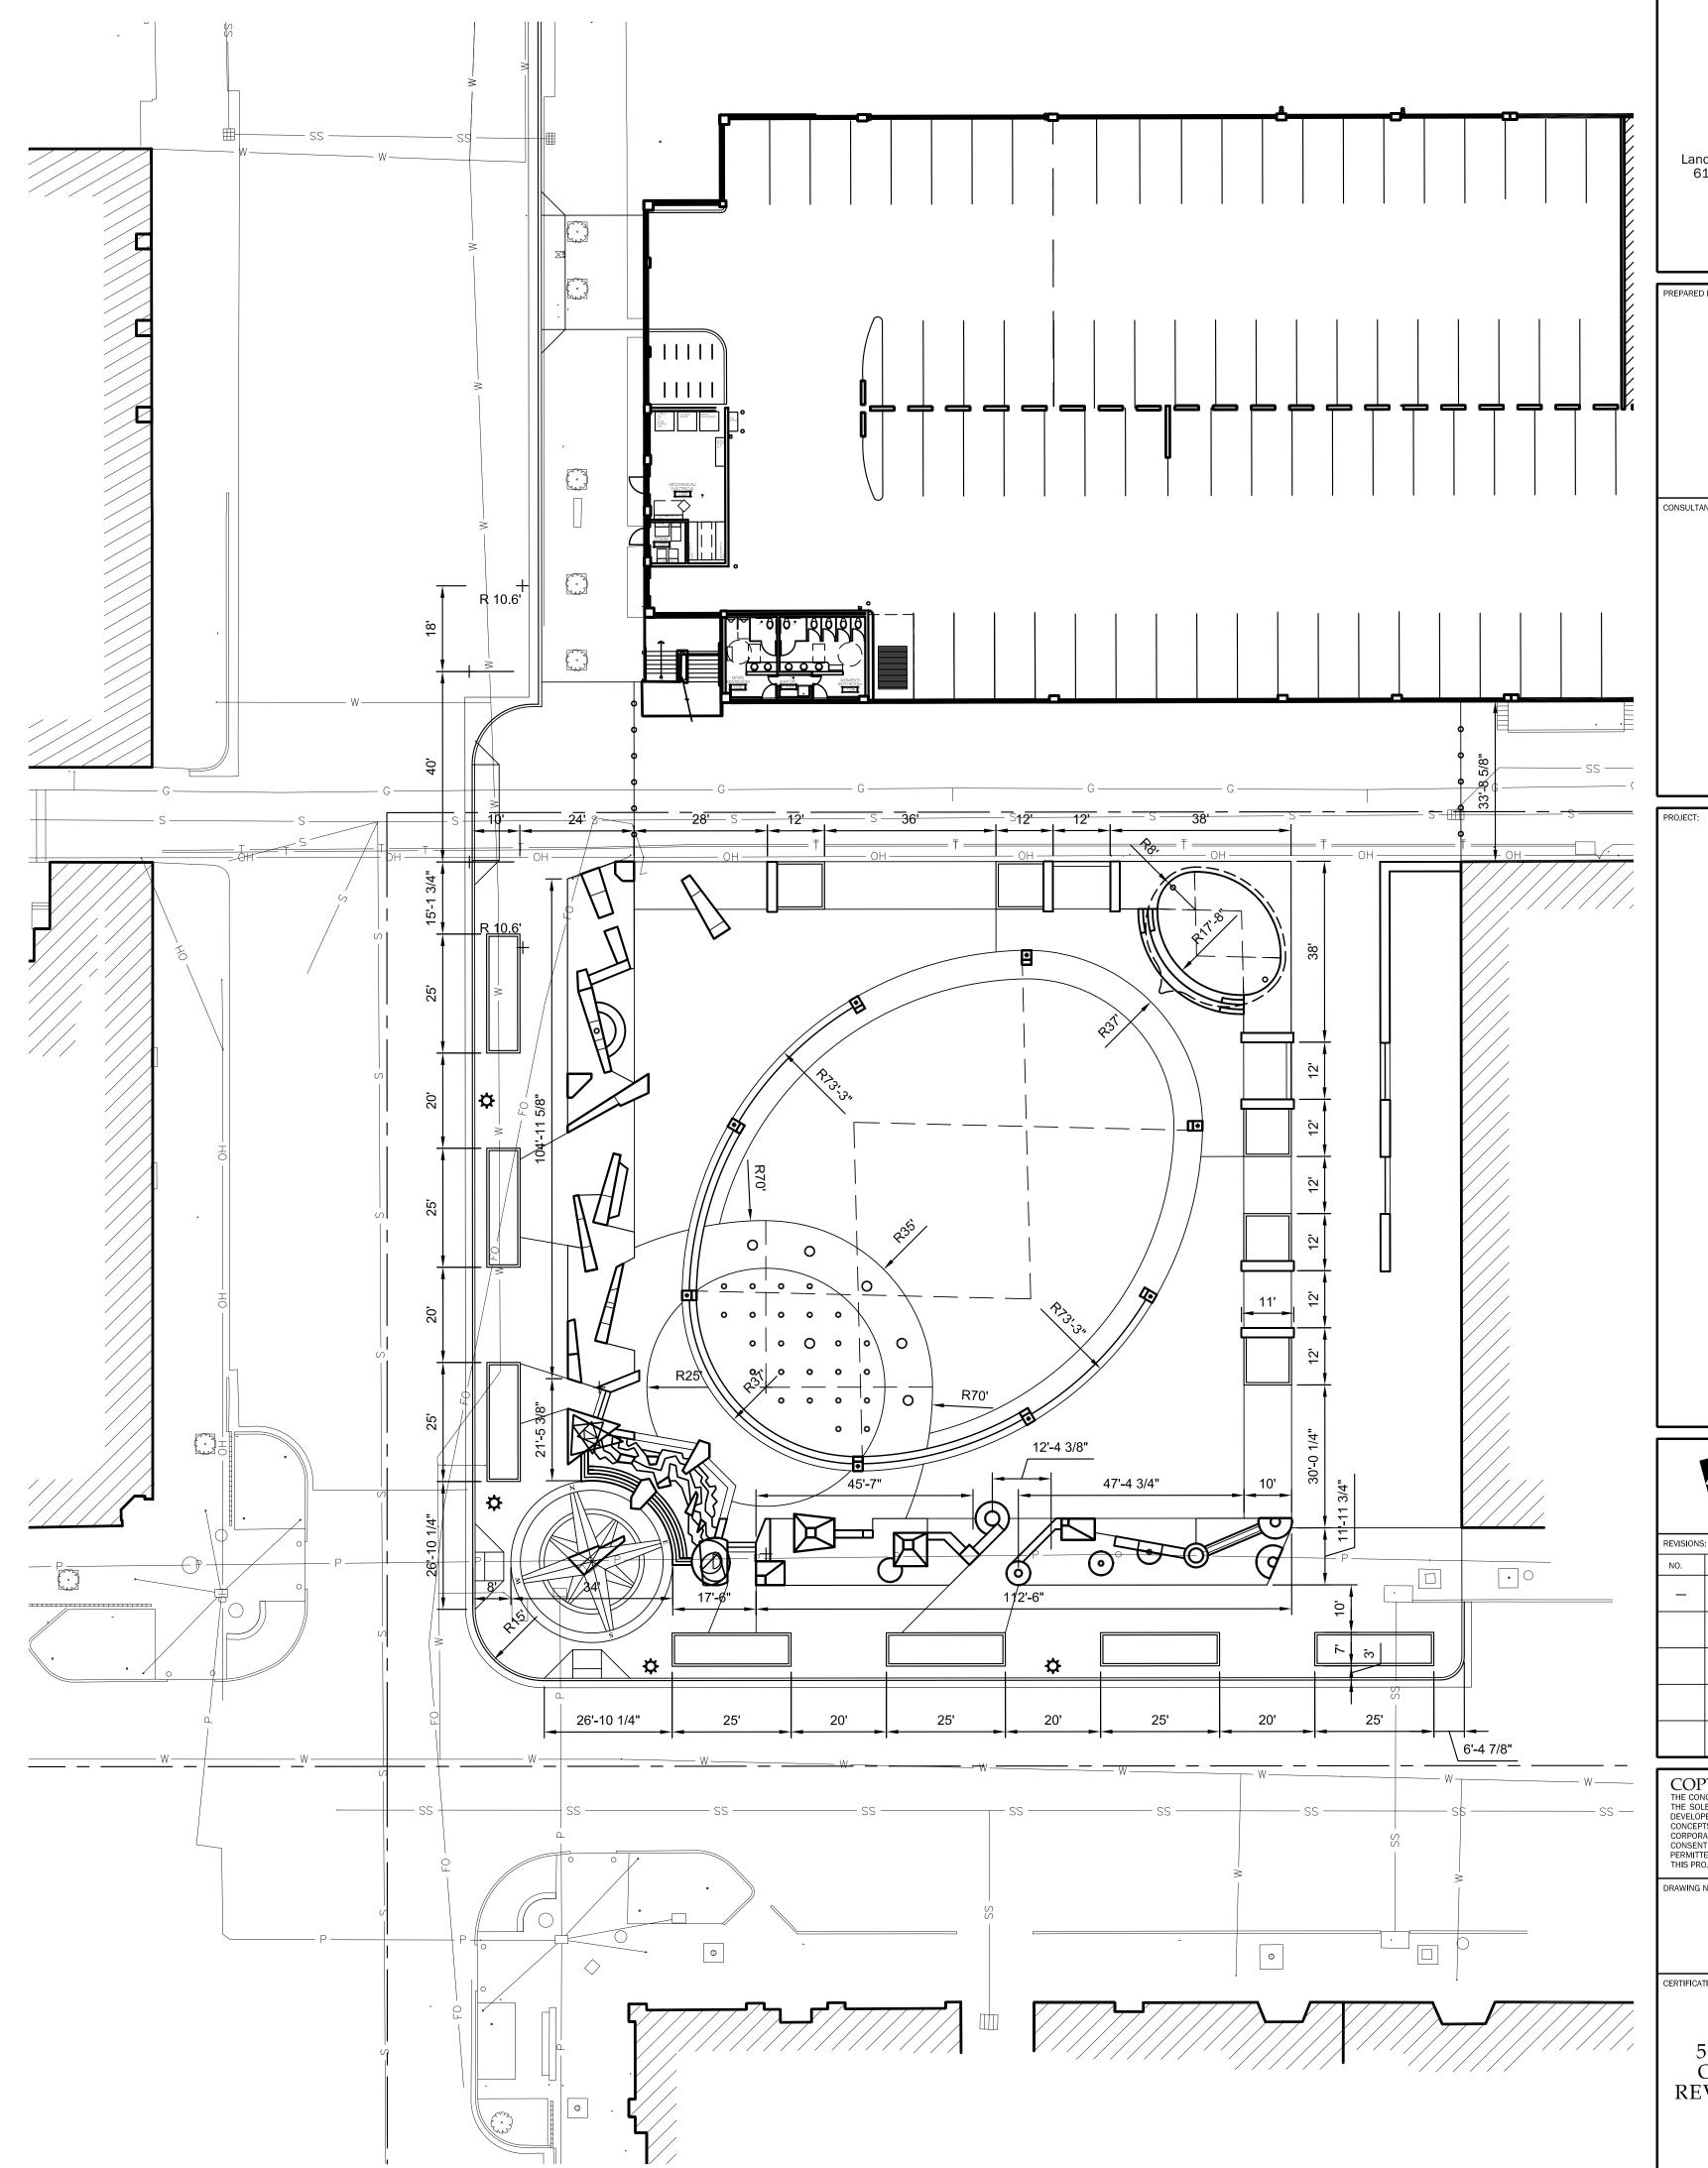



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Site Layout
Dimension Plan

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Project No.: 091131
Date: June 23, 2010
Drawn by: PMA
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Site Layout Plan

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#### GRADING LEGEND & KEY NOTES:

× 119.93 EXISTING SPOT ELEVATION

× 120.23 PROPOSED SPOT ELEVATION

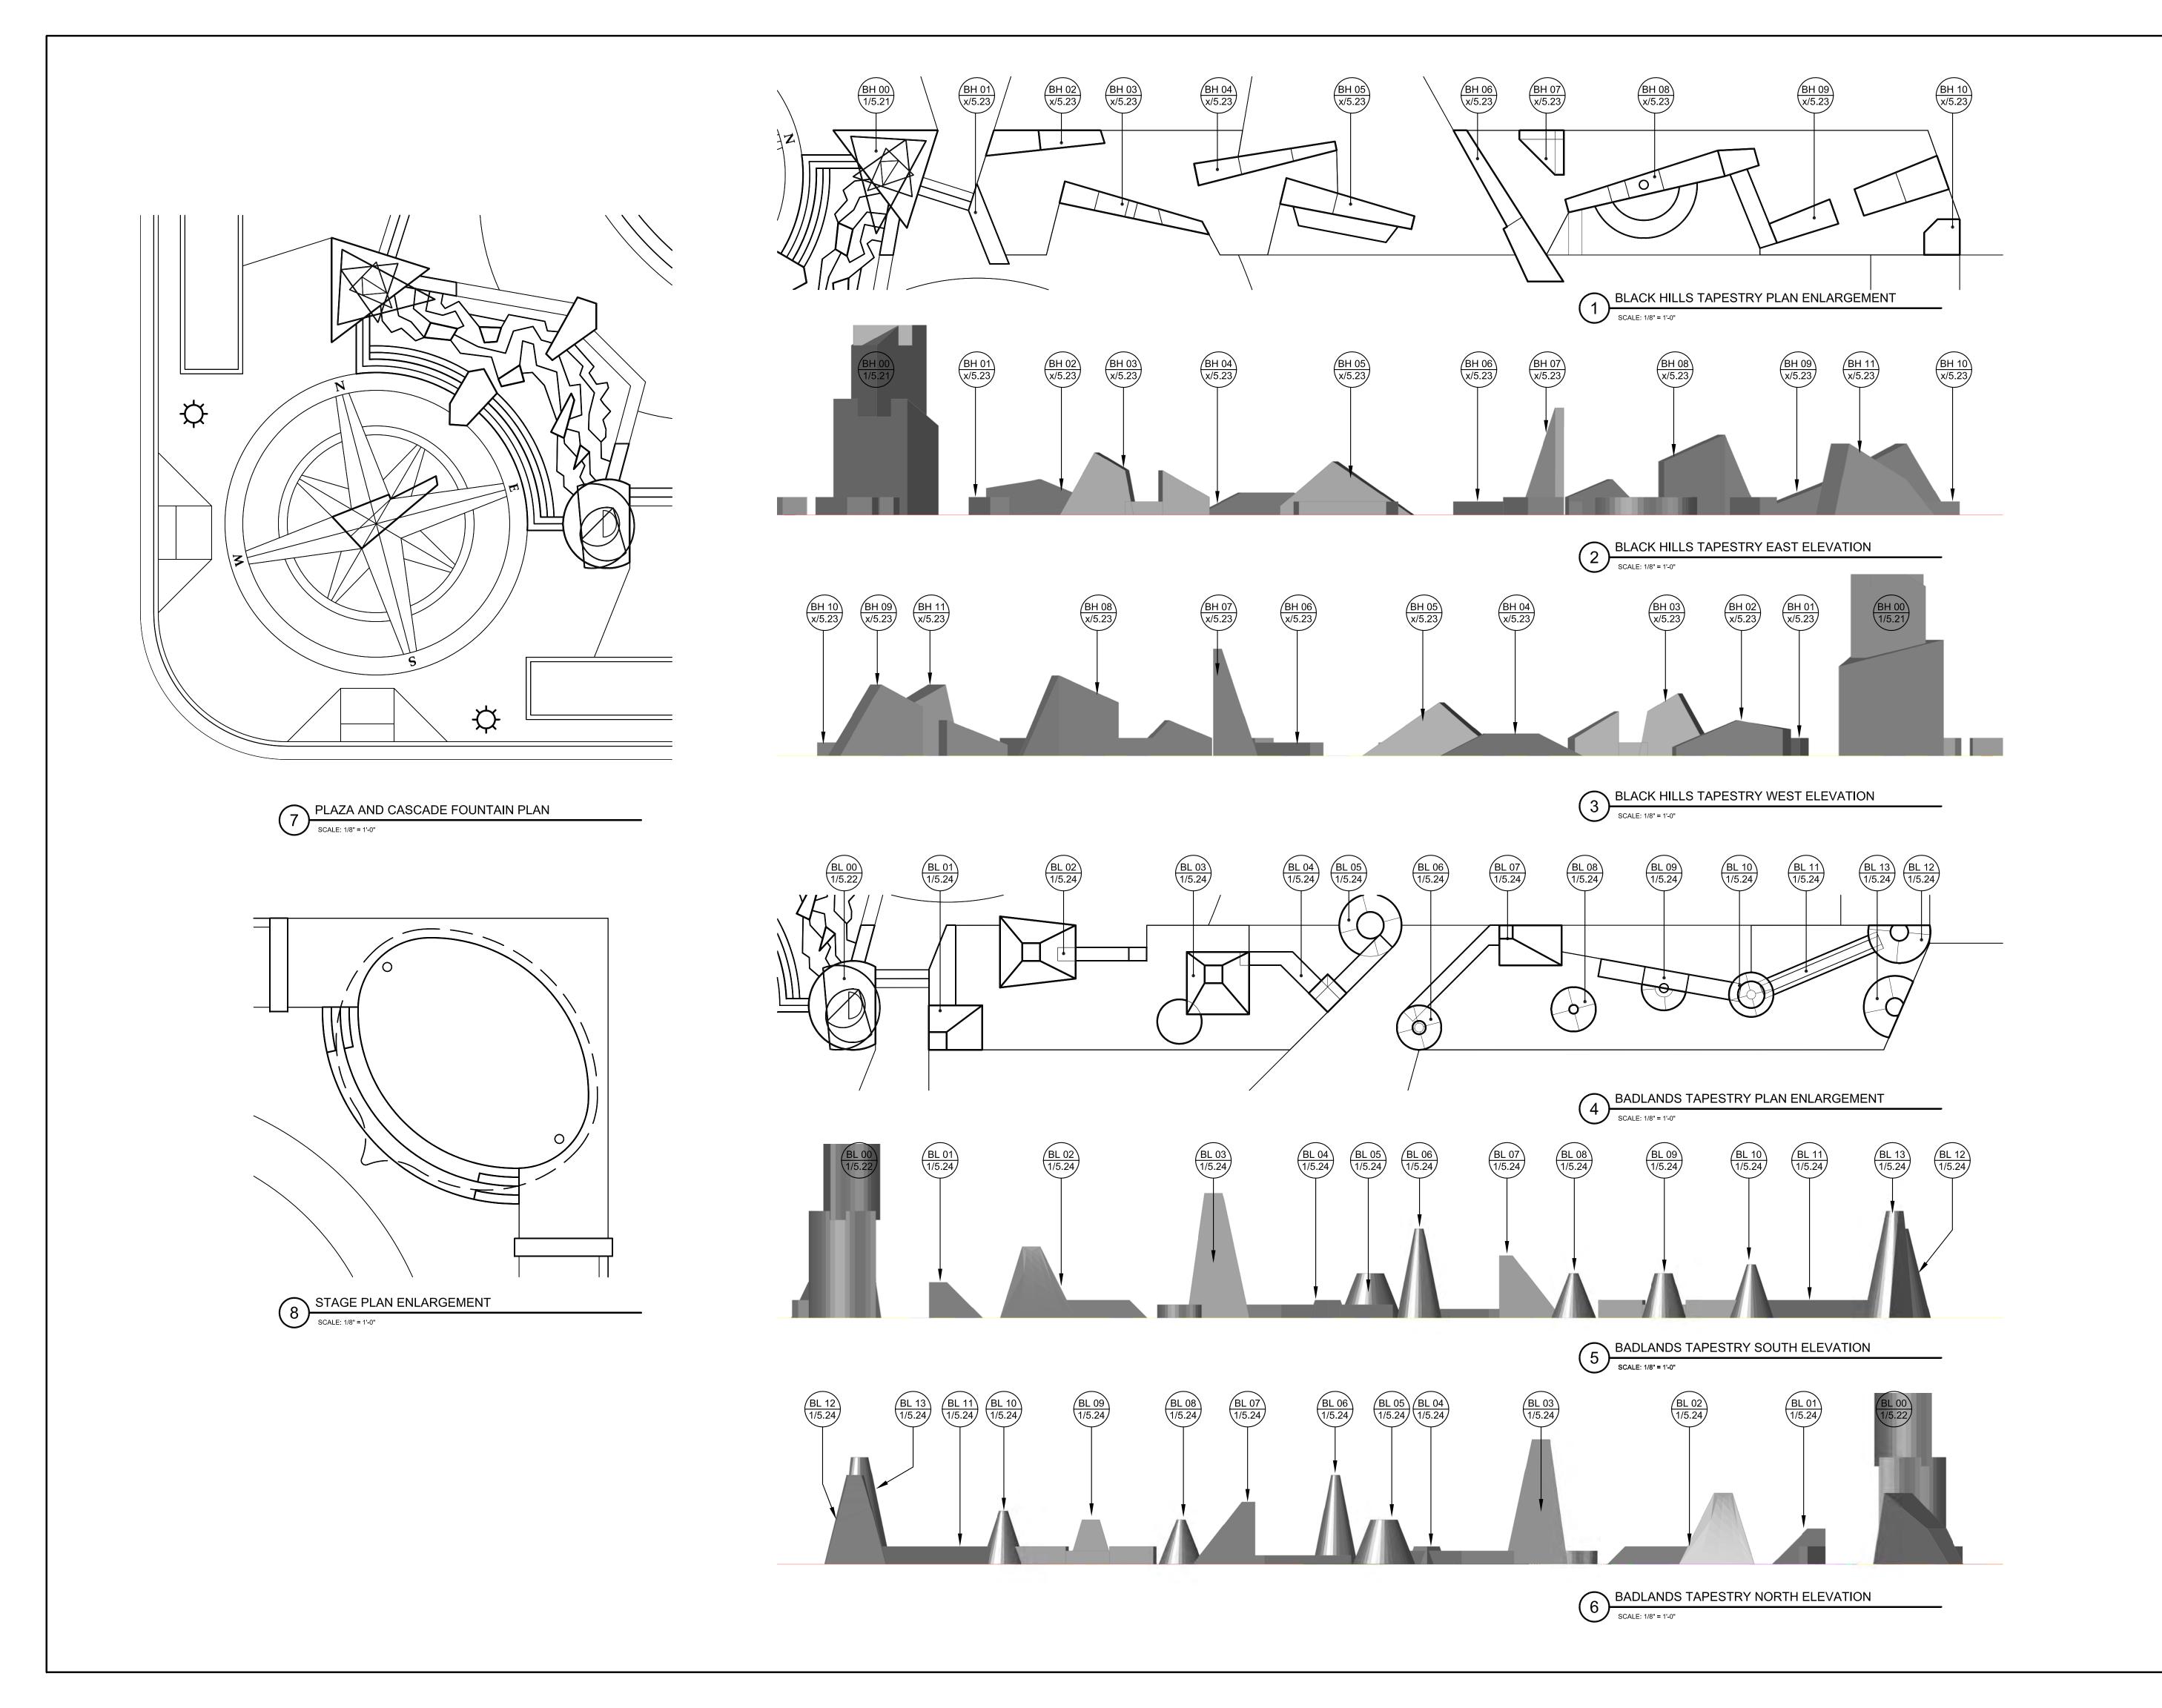PROPOSED SLOPE

LP LOW POINT
HP HIGH POINT

(i) INTERPOLATED; NO SURVEY DATA AVAILABLE

TC TOP OF CURB

MEG MATCH EXISTING GRADE

FL FLOW LINE (GUTTER)

RIM RIM ELEVATION

TR TOP OF RAMP

FV FIELD VERIFY

ADJ ADJUST CASTING TO MATCH PROPOSED GRADE

#### **GRADING GENERAL NOTES:**

1. GRADES INDICATED ARE BASED ON SURVEY DATA. REFER TO SURVEY FOR VERTICAL CONTROL POINTS AND PROJECT BENCHMARK.

2. THE CONTRACTOR SHALL REPORT IMMEDIATELY TO THE OWNER & LANDSCAPE ARCHITECT ANY DISCREPANCIES BETWEEN THE EXISTING GRADES SHOWN ON THESE PLANS AND ACTUAL FIELD

3. UNLESS NOTED OTHERWISE, PROPOSED SPOT ELEVATIONS REPRESENT FINISH GRADE OF PAVEMENTS AND GROUND. IN LAWN OR PLANT BED AREAS, PROPOSED ELEVATIONS INDICATE REQUIRED ELEVATIONS AFTER SETTLING OF SOIL.

4. ALL LAWN AREAS ARE TO RECEIVE A MINIMUM LAYER OF 6" OF TOPSOIL AND SEED. ALL PLANT BED AREAS ARE TO RECEIVE A MINIMUM LAYER OF 12" OF TOPSOIL AND MULCH. THE TOPSOIL SHALL BE TRANSITIONED INTO SUBGRADE AS SHOWN IN DETAIL 1, THIS SHEET.

5. FINISH GRADES SHALL BE HELD DOWN RELATIVE TO WALKS AS FOLLOWS: AT SEED LAWNS: 1/2", AT SOD LAWNS: 1", AND AT PLANT BEDS: 2".



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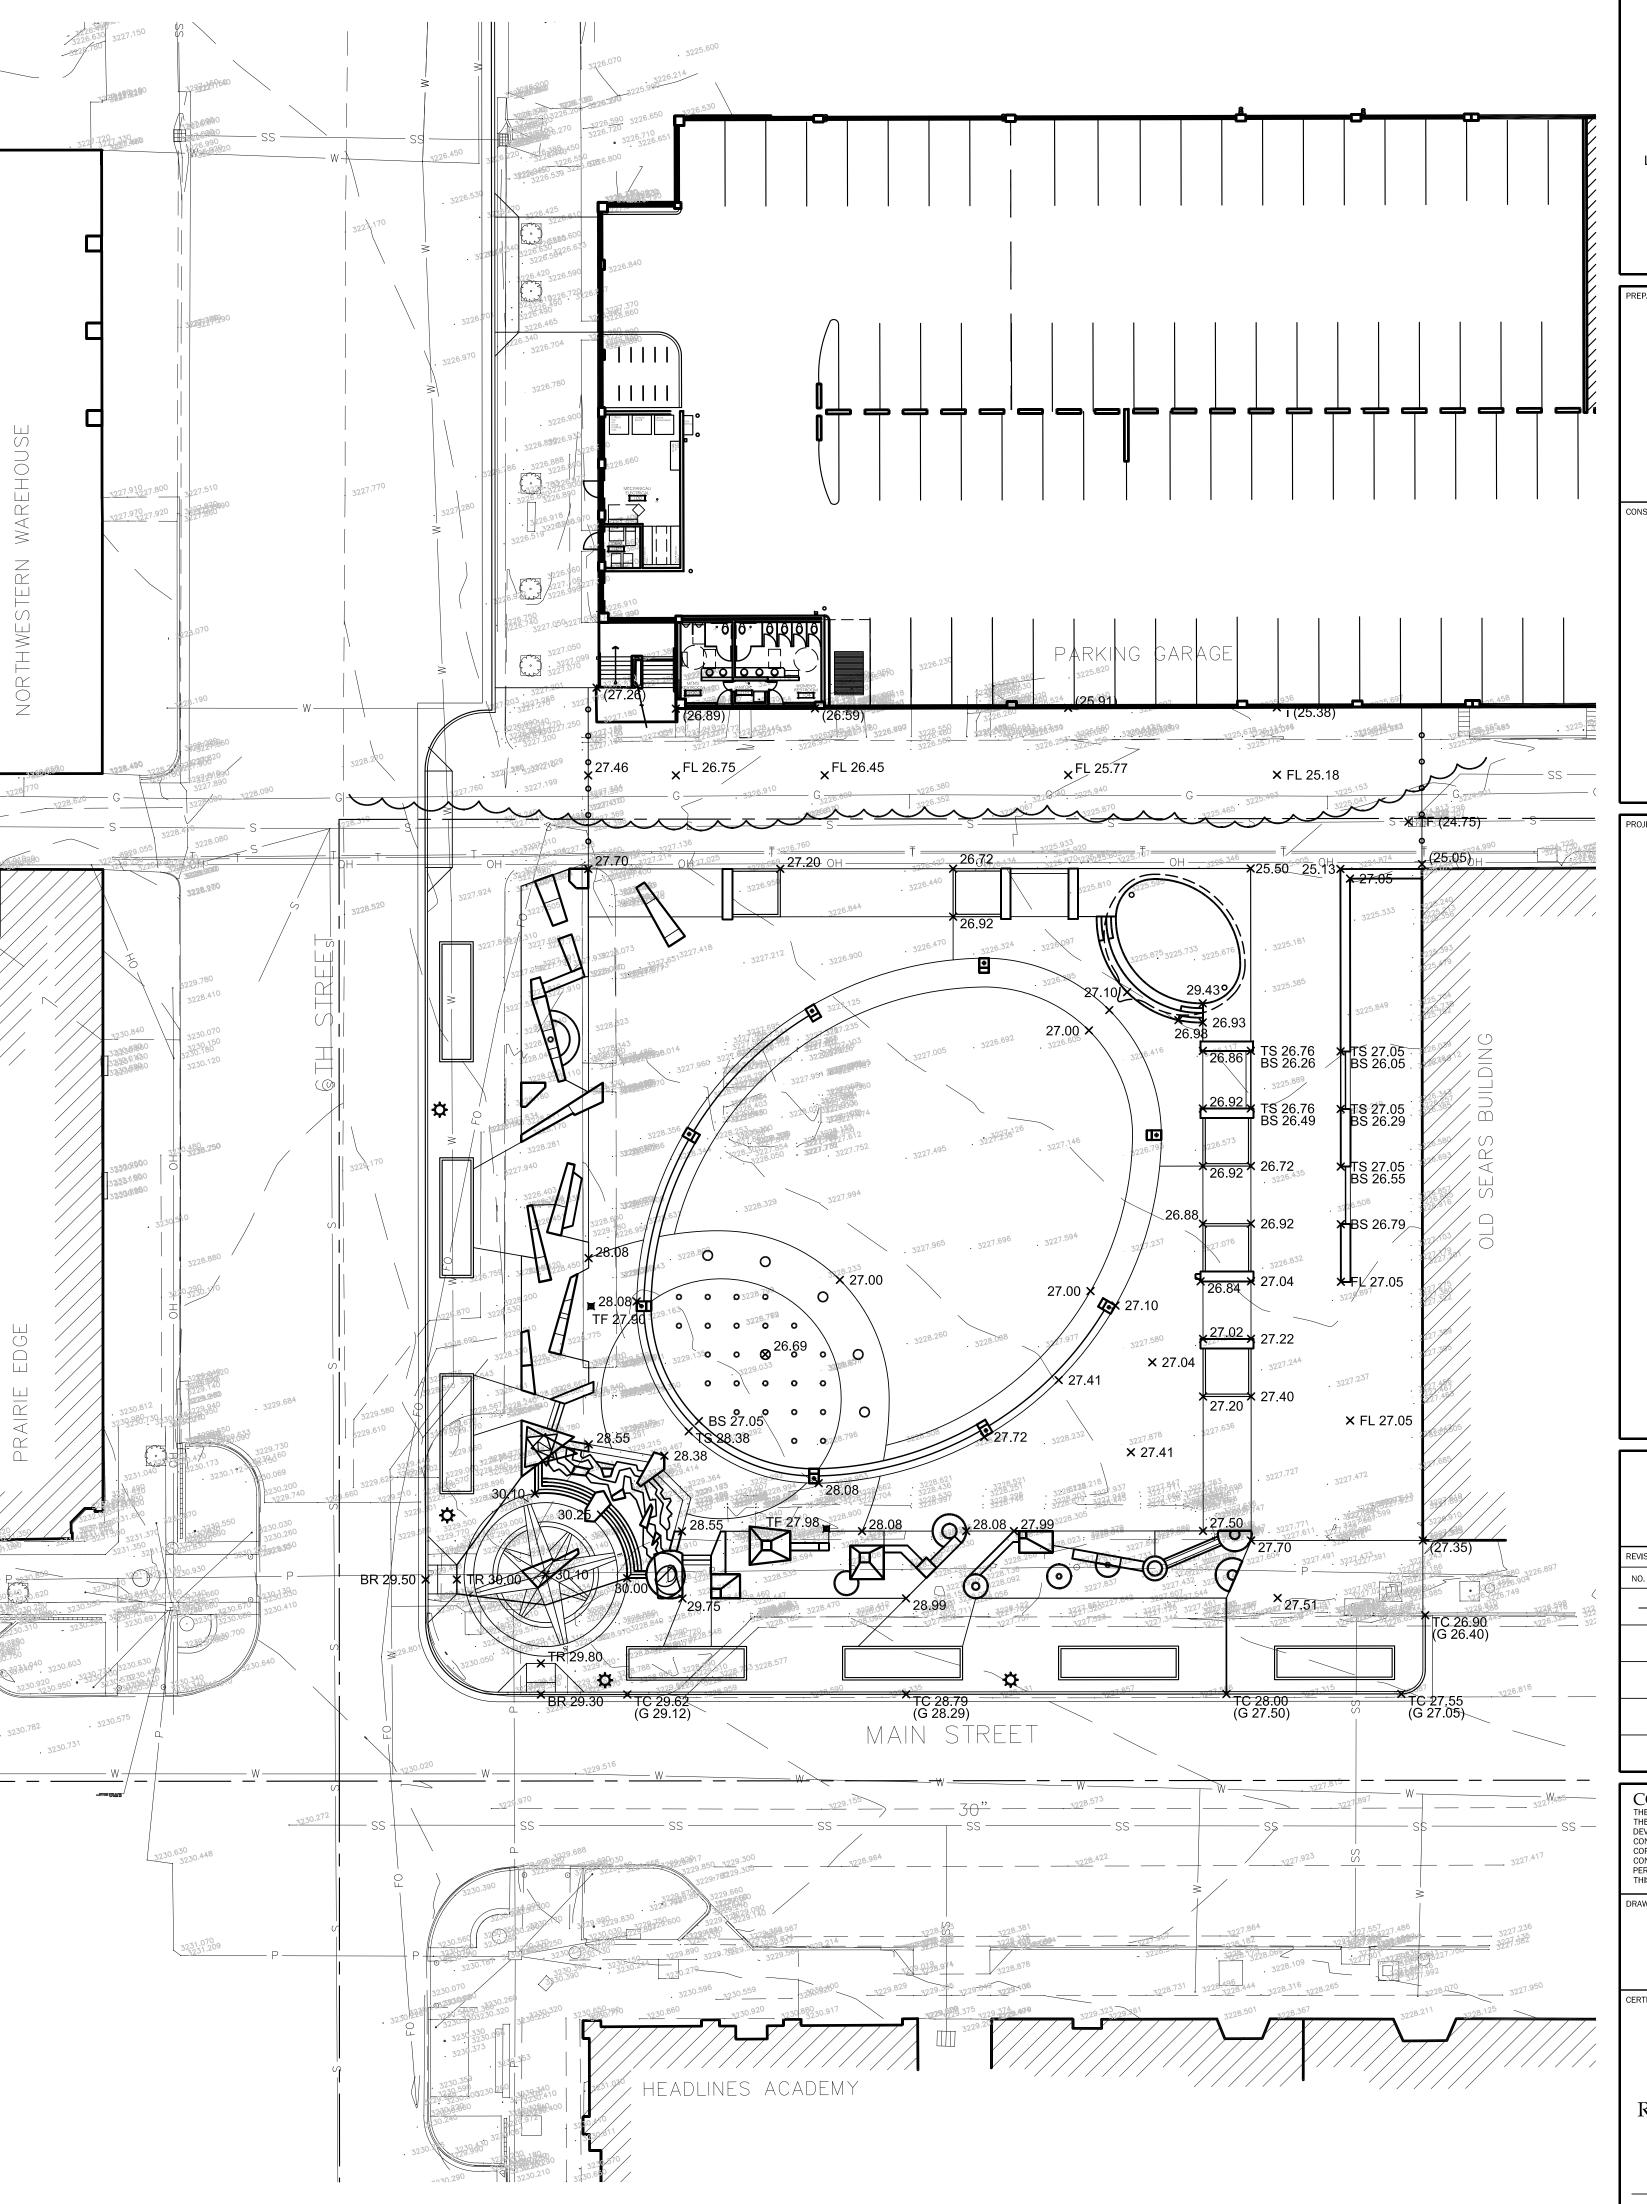
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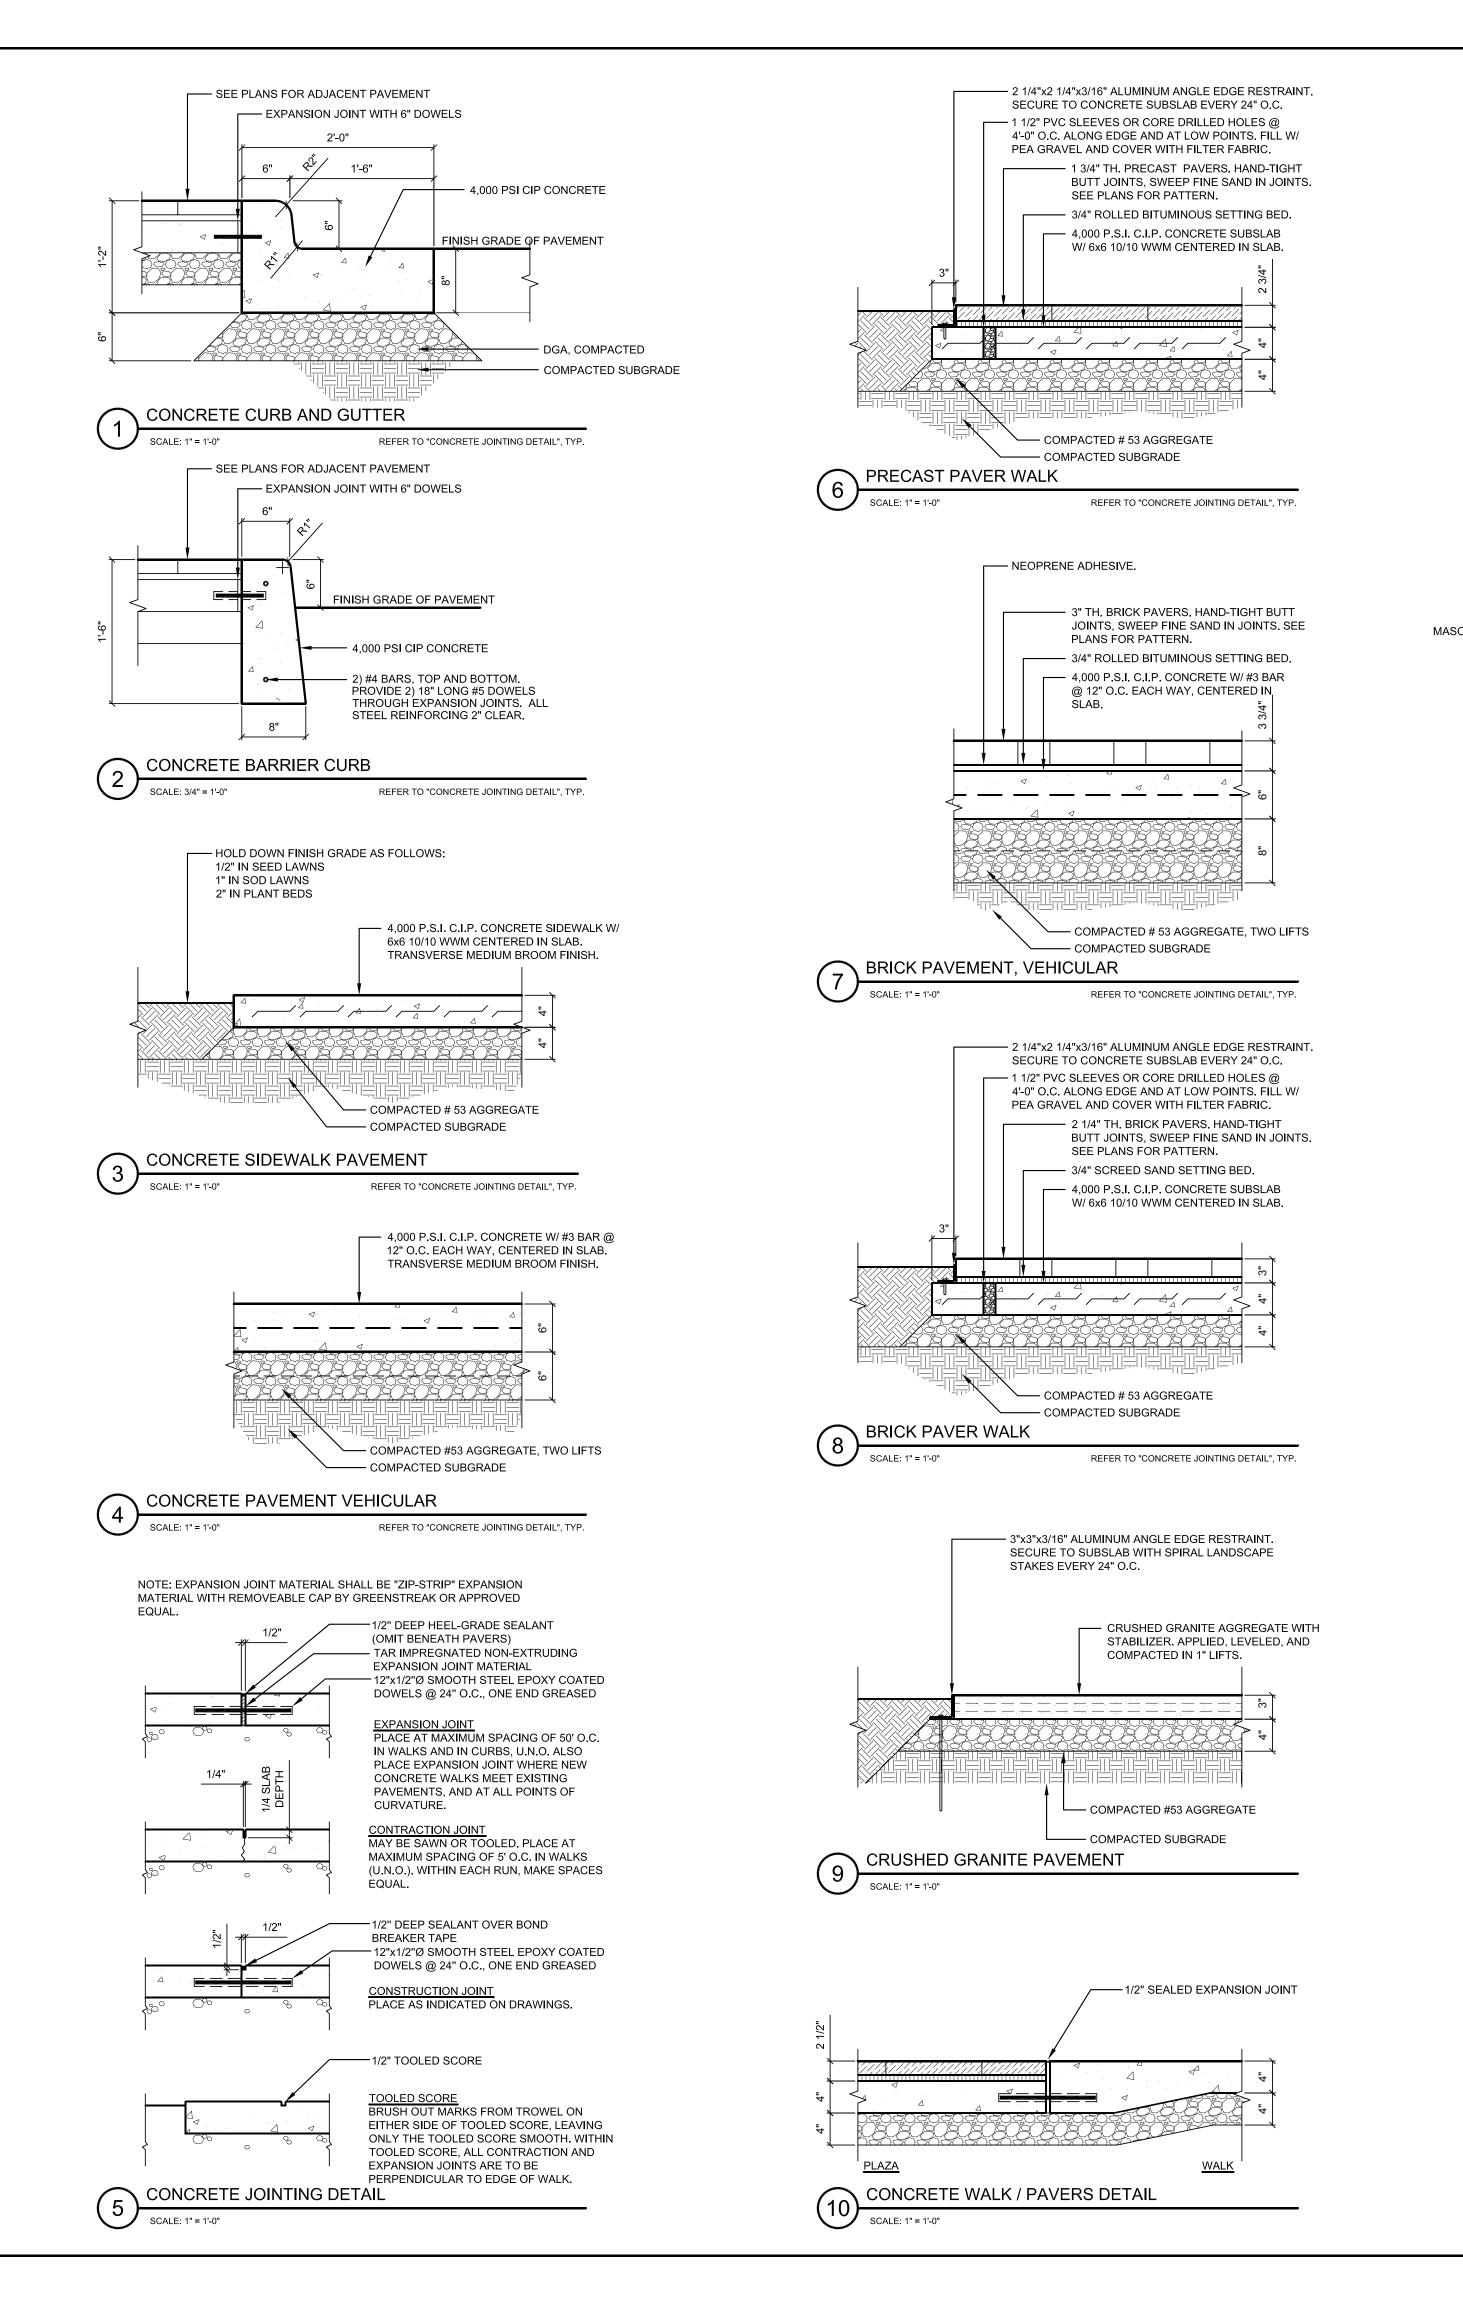
Site Grading Plan


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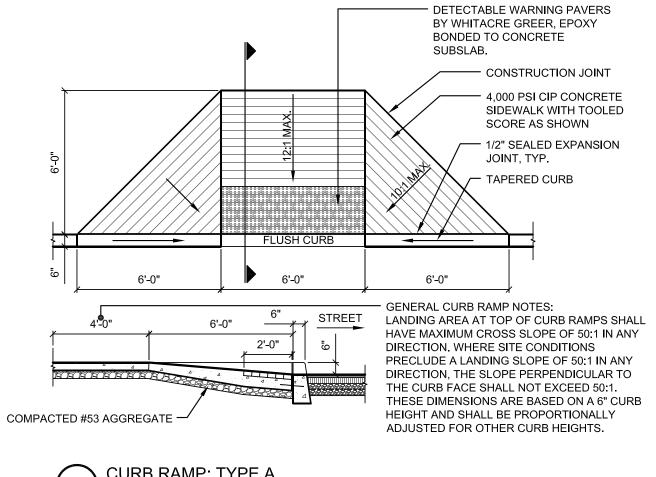
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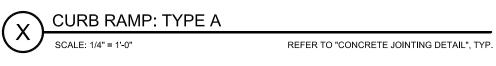
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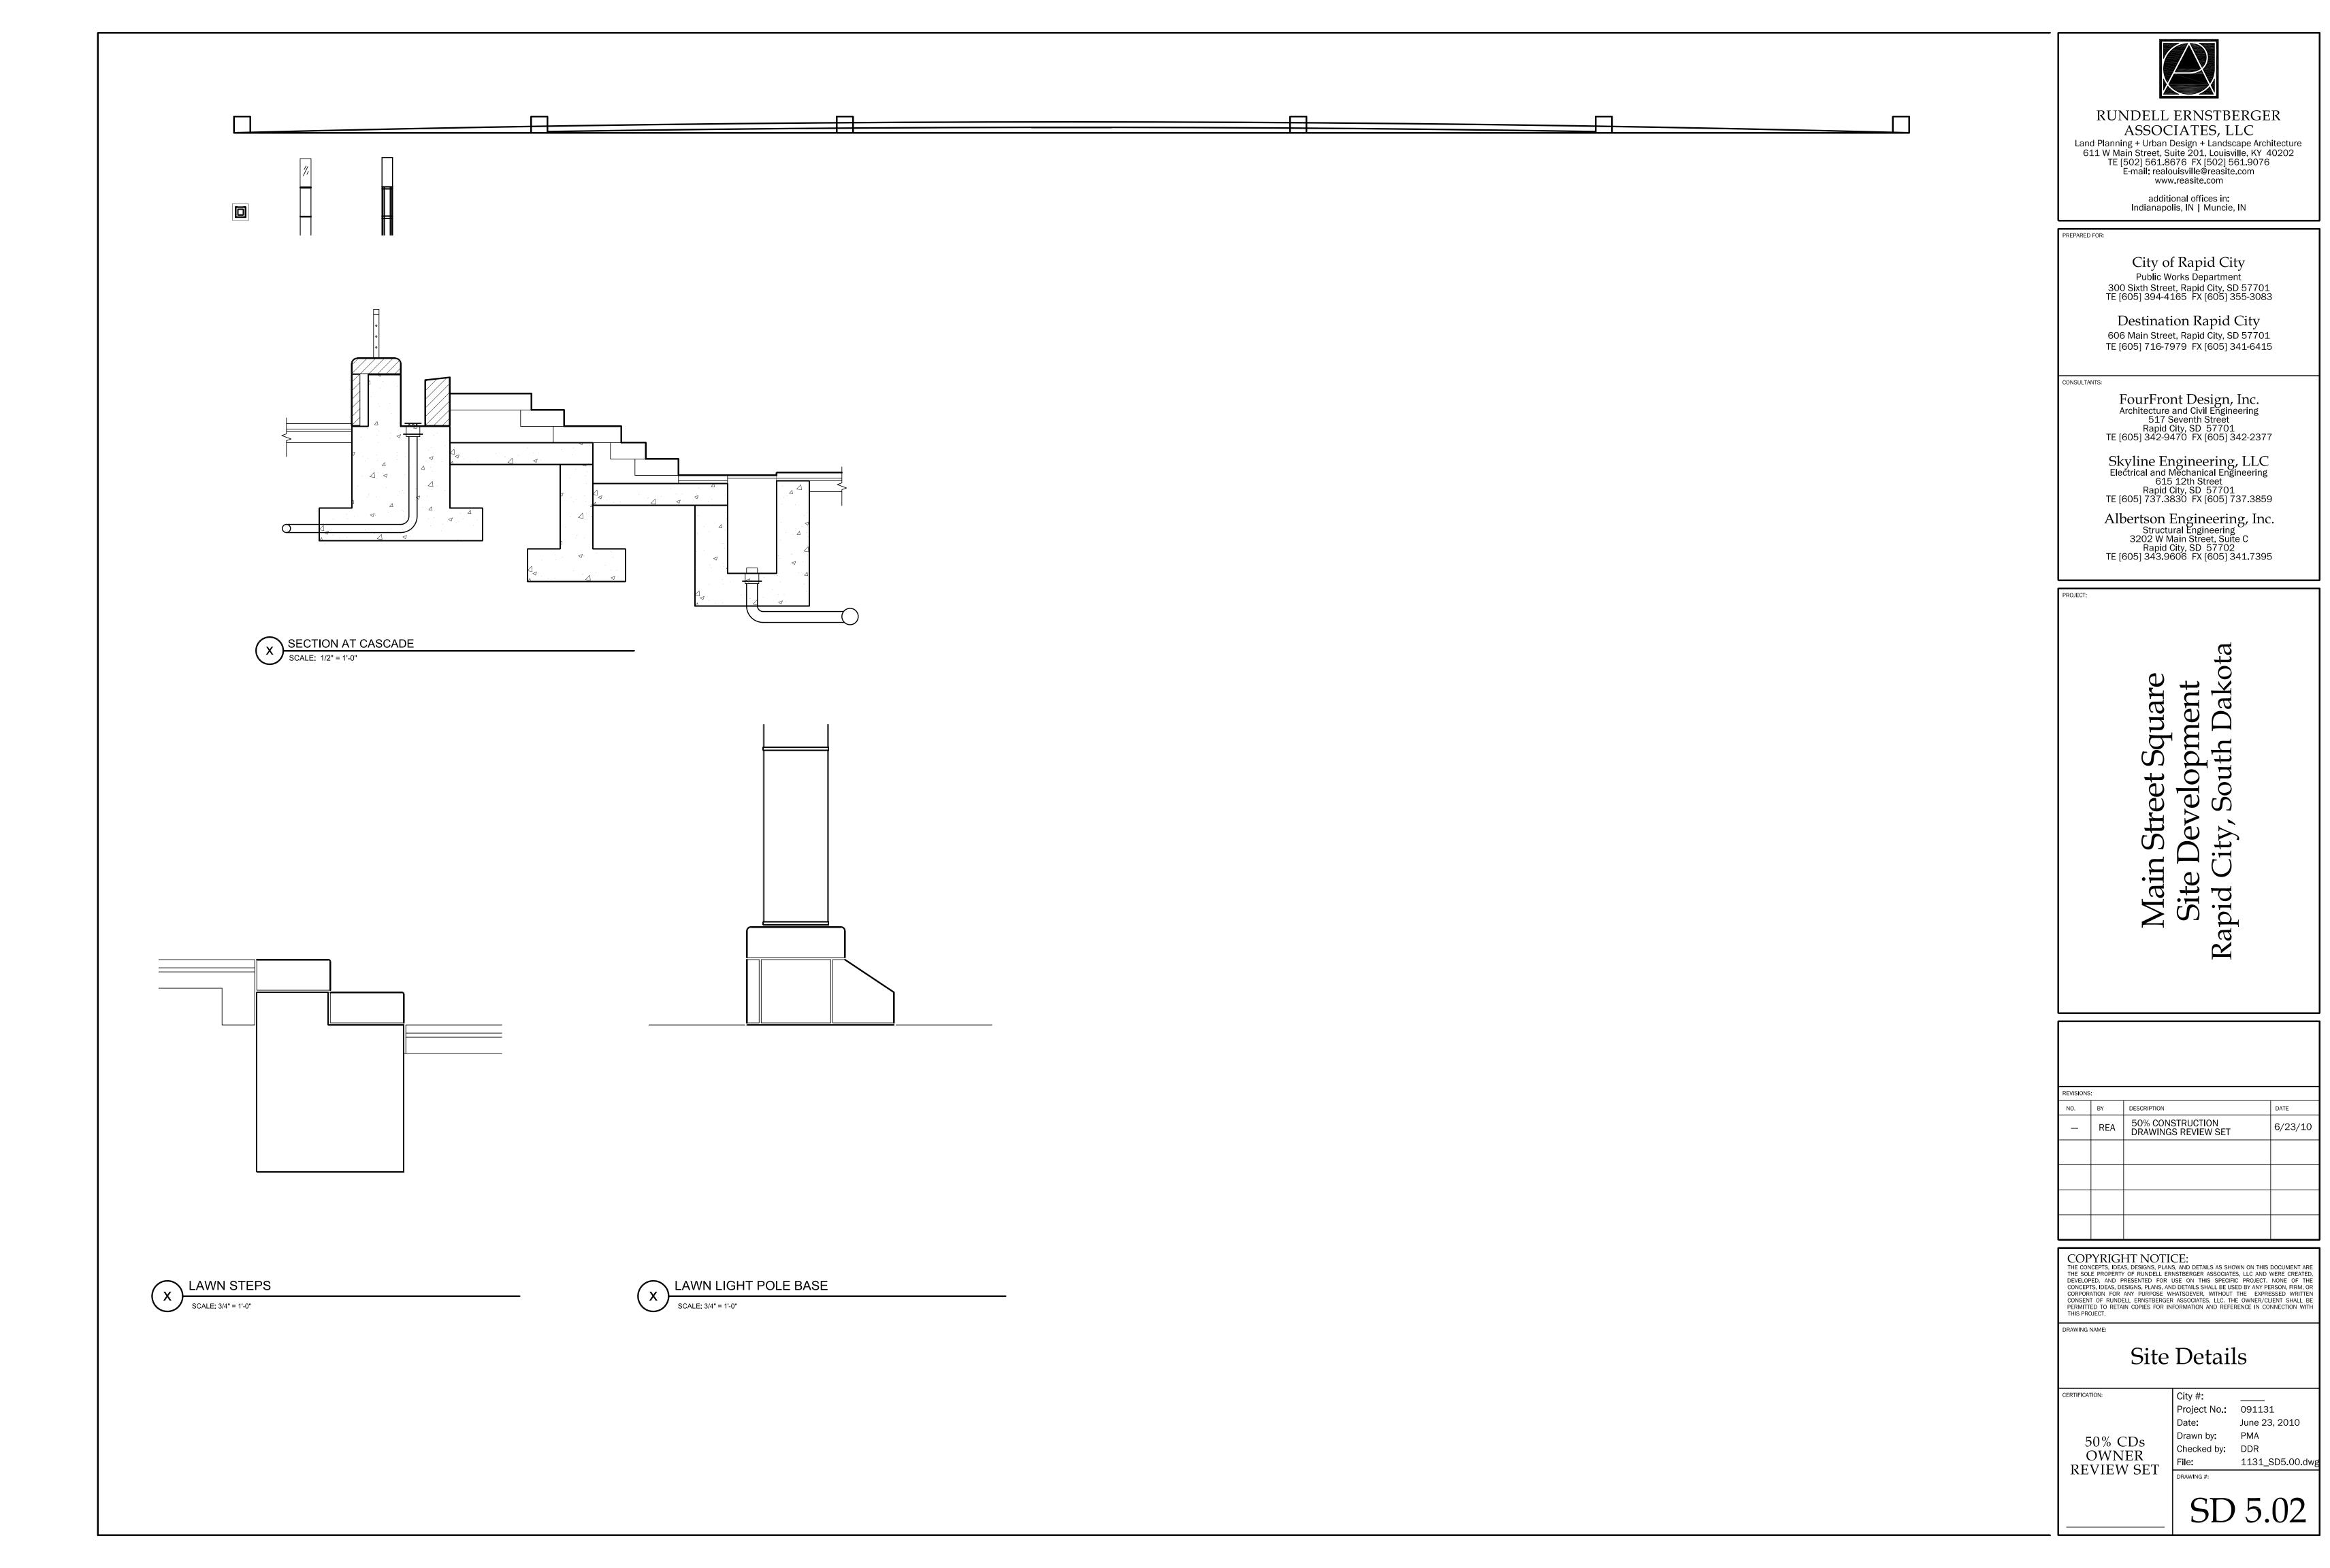
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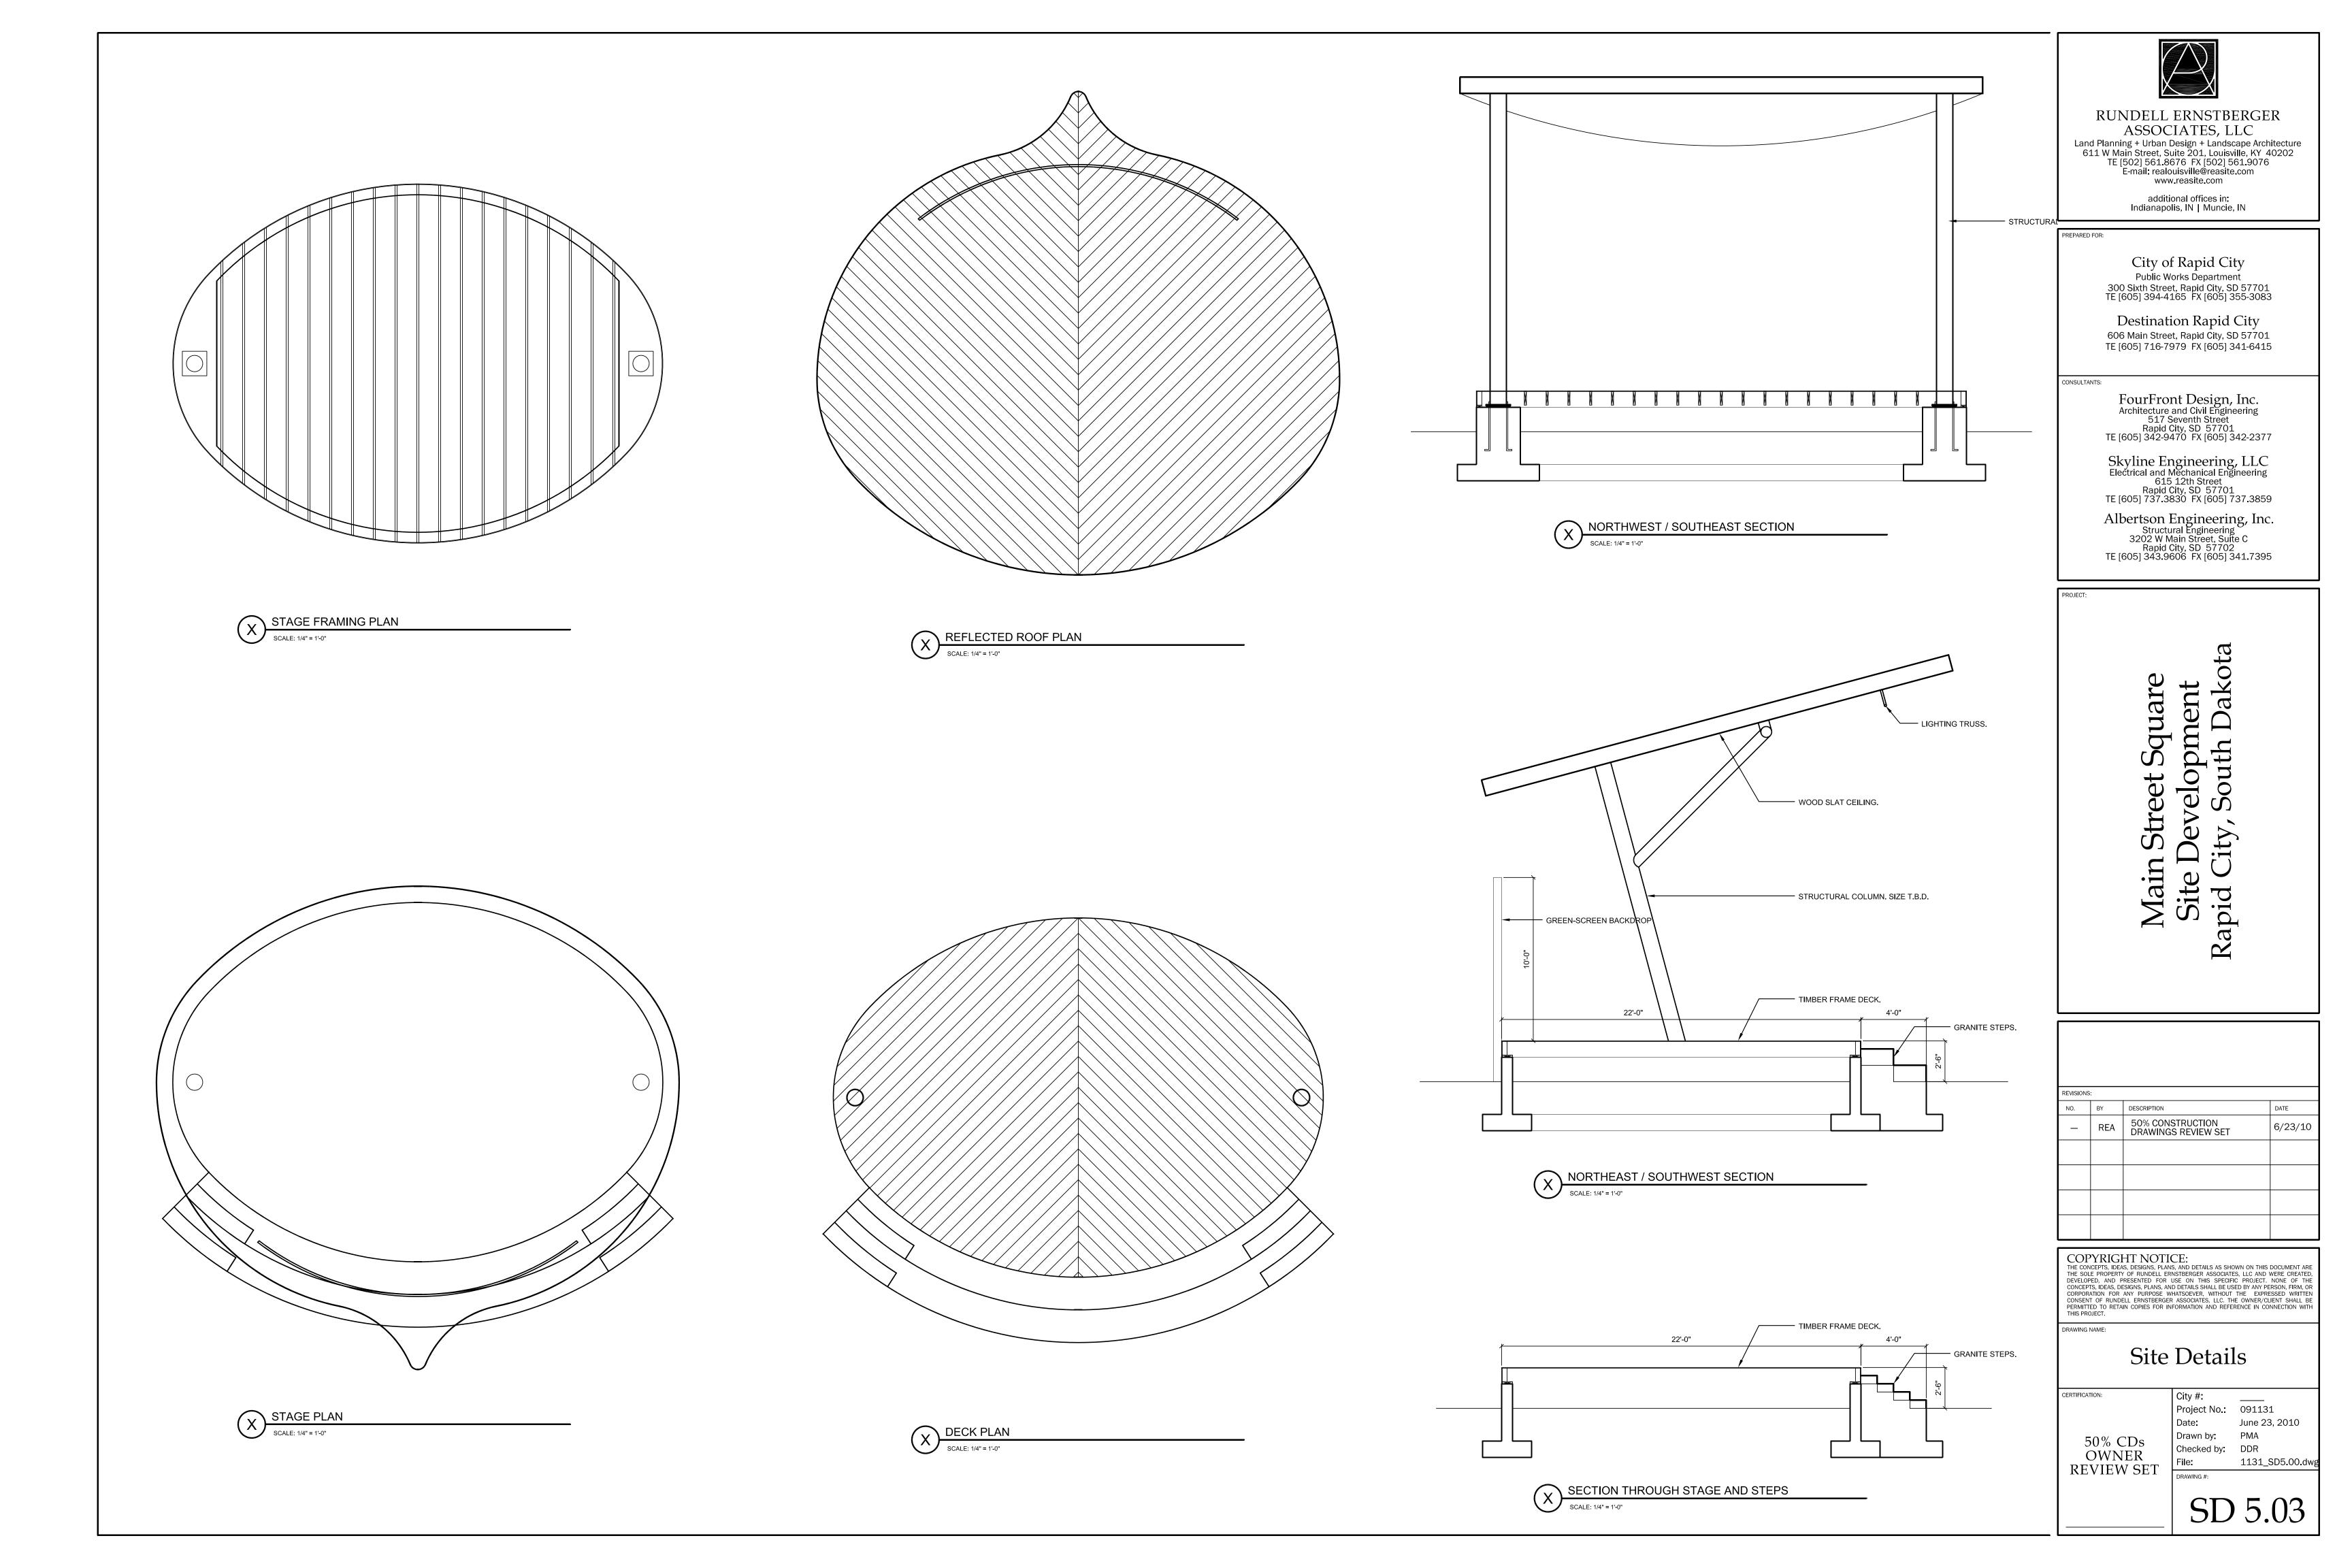
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|  |  |   | Project No.:  | 09113:  |   |
|  |  |   | Date:   | June 23   | 3, 2010   |
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|  |  | _   | Checked by:   | DDR   |   |
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additional offices in: Indianapolis, IN | Muncie, IN

PREPARED FOR:

City of Rapid City
Public Works Department
300 Sixth Street, Rapid City, SD 57701
TE [605] 394-4165 FX [605] 355-3083

Destination Rapid City 606 Main Street, Rapid City, SD 57701 TE [605] 716-7979 FX [605] 341-6415

CONSULTANTS:
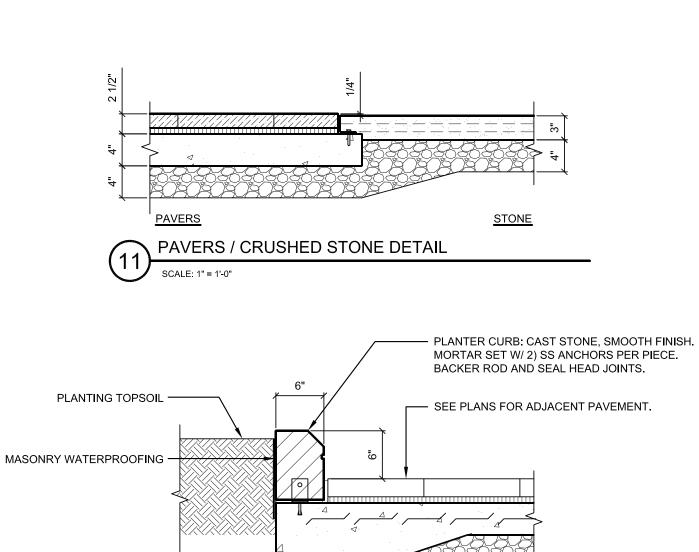
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Structural Engineering
3202 W Main Street, Suite C
Rapid City, SD 57702
TE [605] 343.9606 FX [605] 341.7395

EGI.

Main Street Square Site Development Rapid City, South Dakota

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### Black Hills Spire Details

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City #:

Project No.: 091131


Date: June 23, 2010


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Main Street Square Site Development Rapid City, South Dakota

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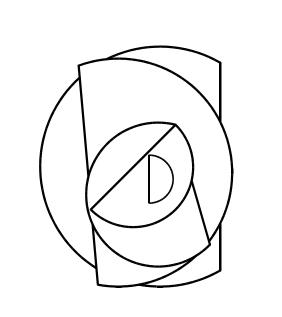
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Badlands Spire Details

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City #:
Project No.: 091131
Date: June 23, 2010
Drawn by: PMA
Checked by: DDR
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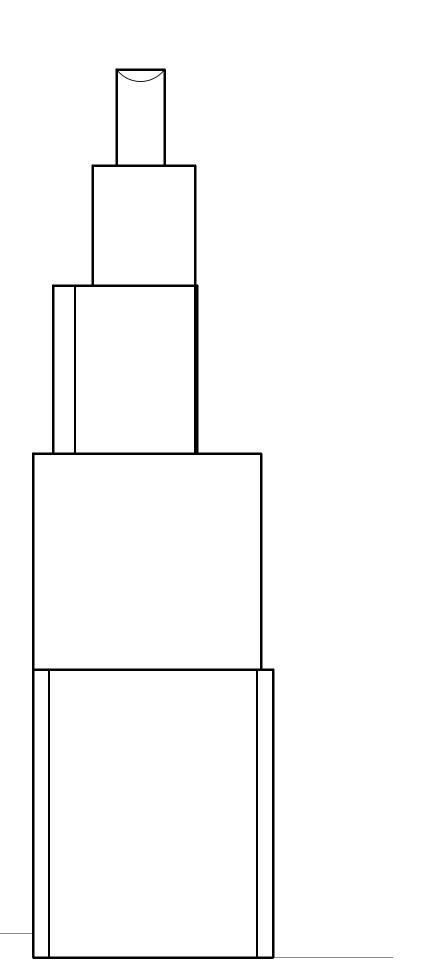
BADLANDS SPIRE PLAN


BADLANDS SPIRE SOUTH ELEVATION

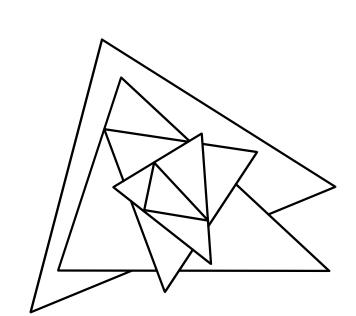
SCALE: 1/4" = 1'-0"

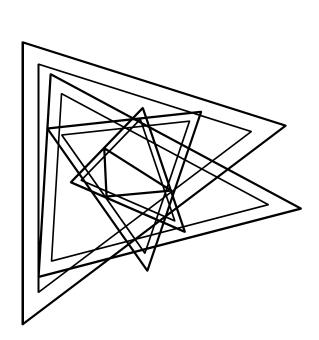SCALE: 1/4" = 1'-0"





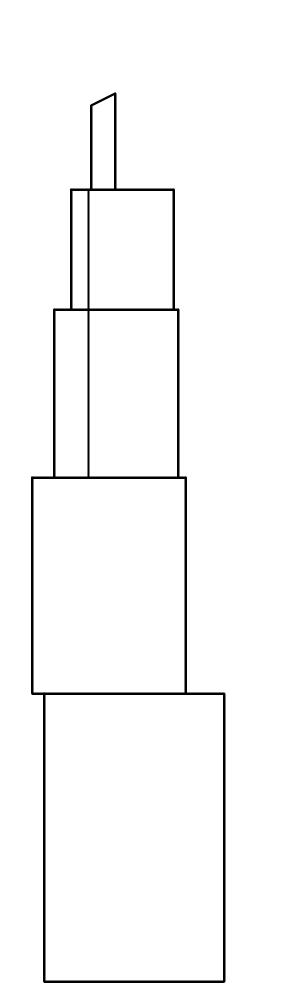

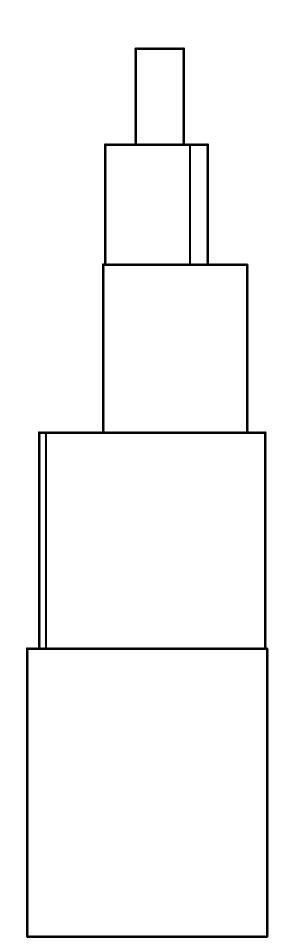

BADLANDS SPIRE EAST ELEVATION


SCALE: 1/4" = 1'-0"

BADLANDS SPIRE NORTH ELEVATION


SCALE: 1/4" = 1'-0"


BADLANDS SPIRE WEST ELEVATION

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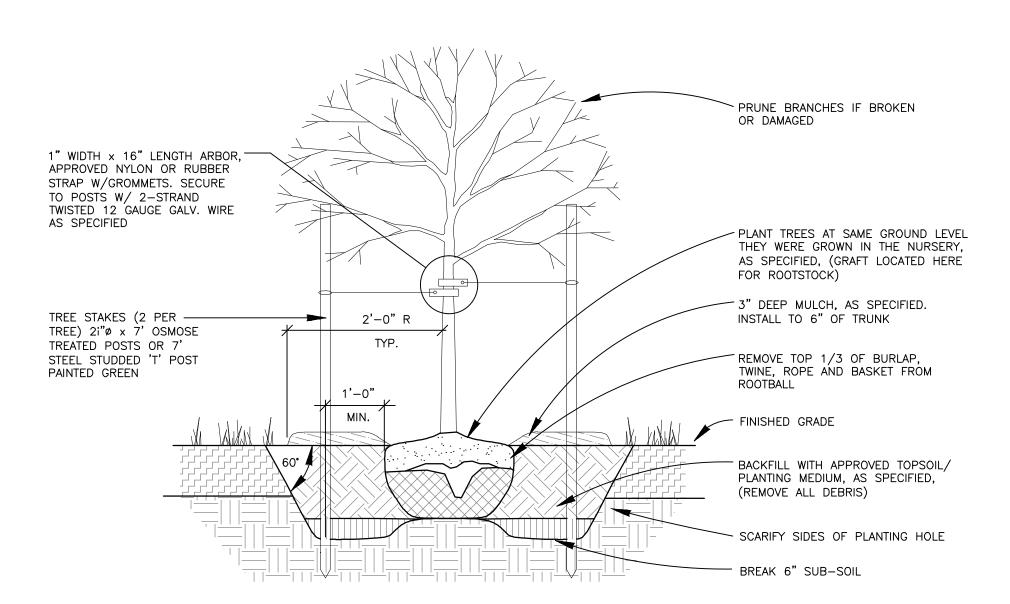

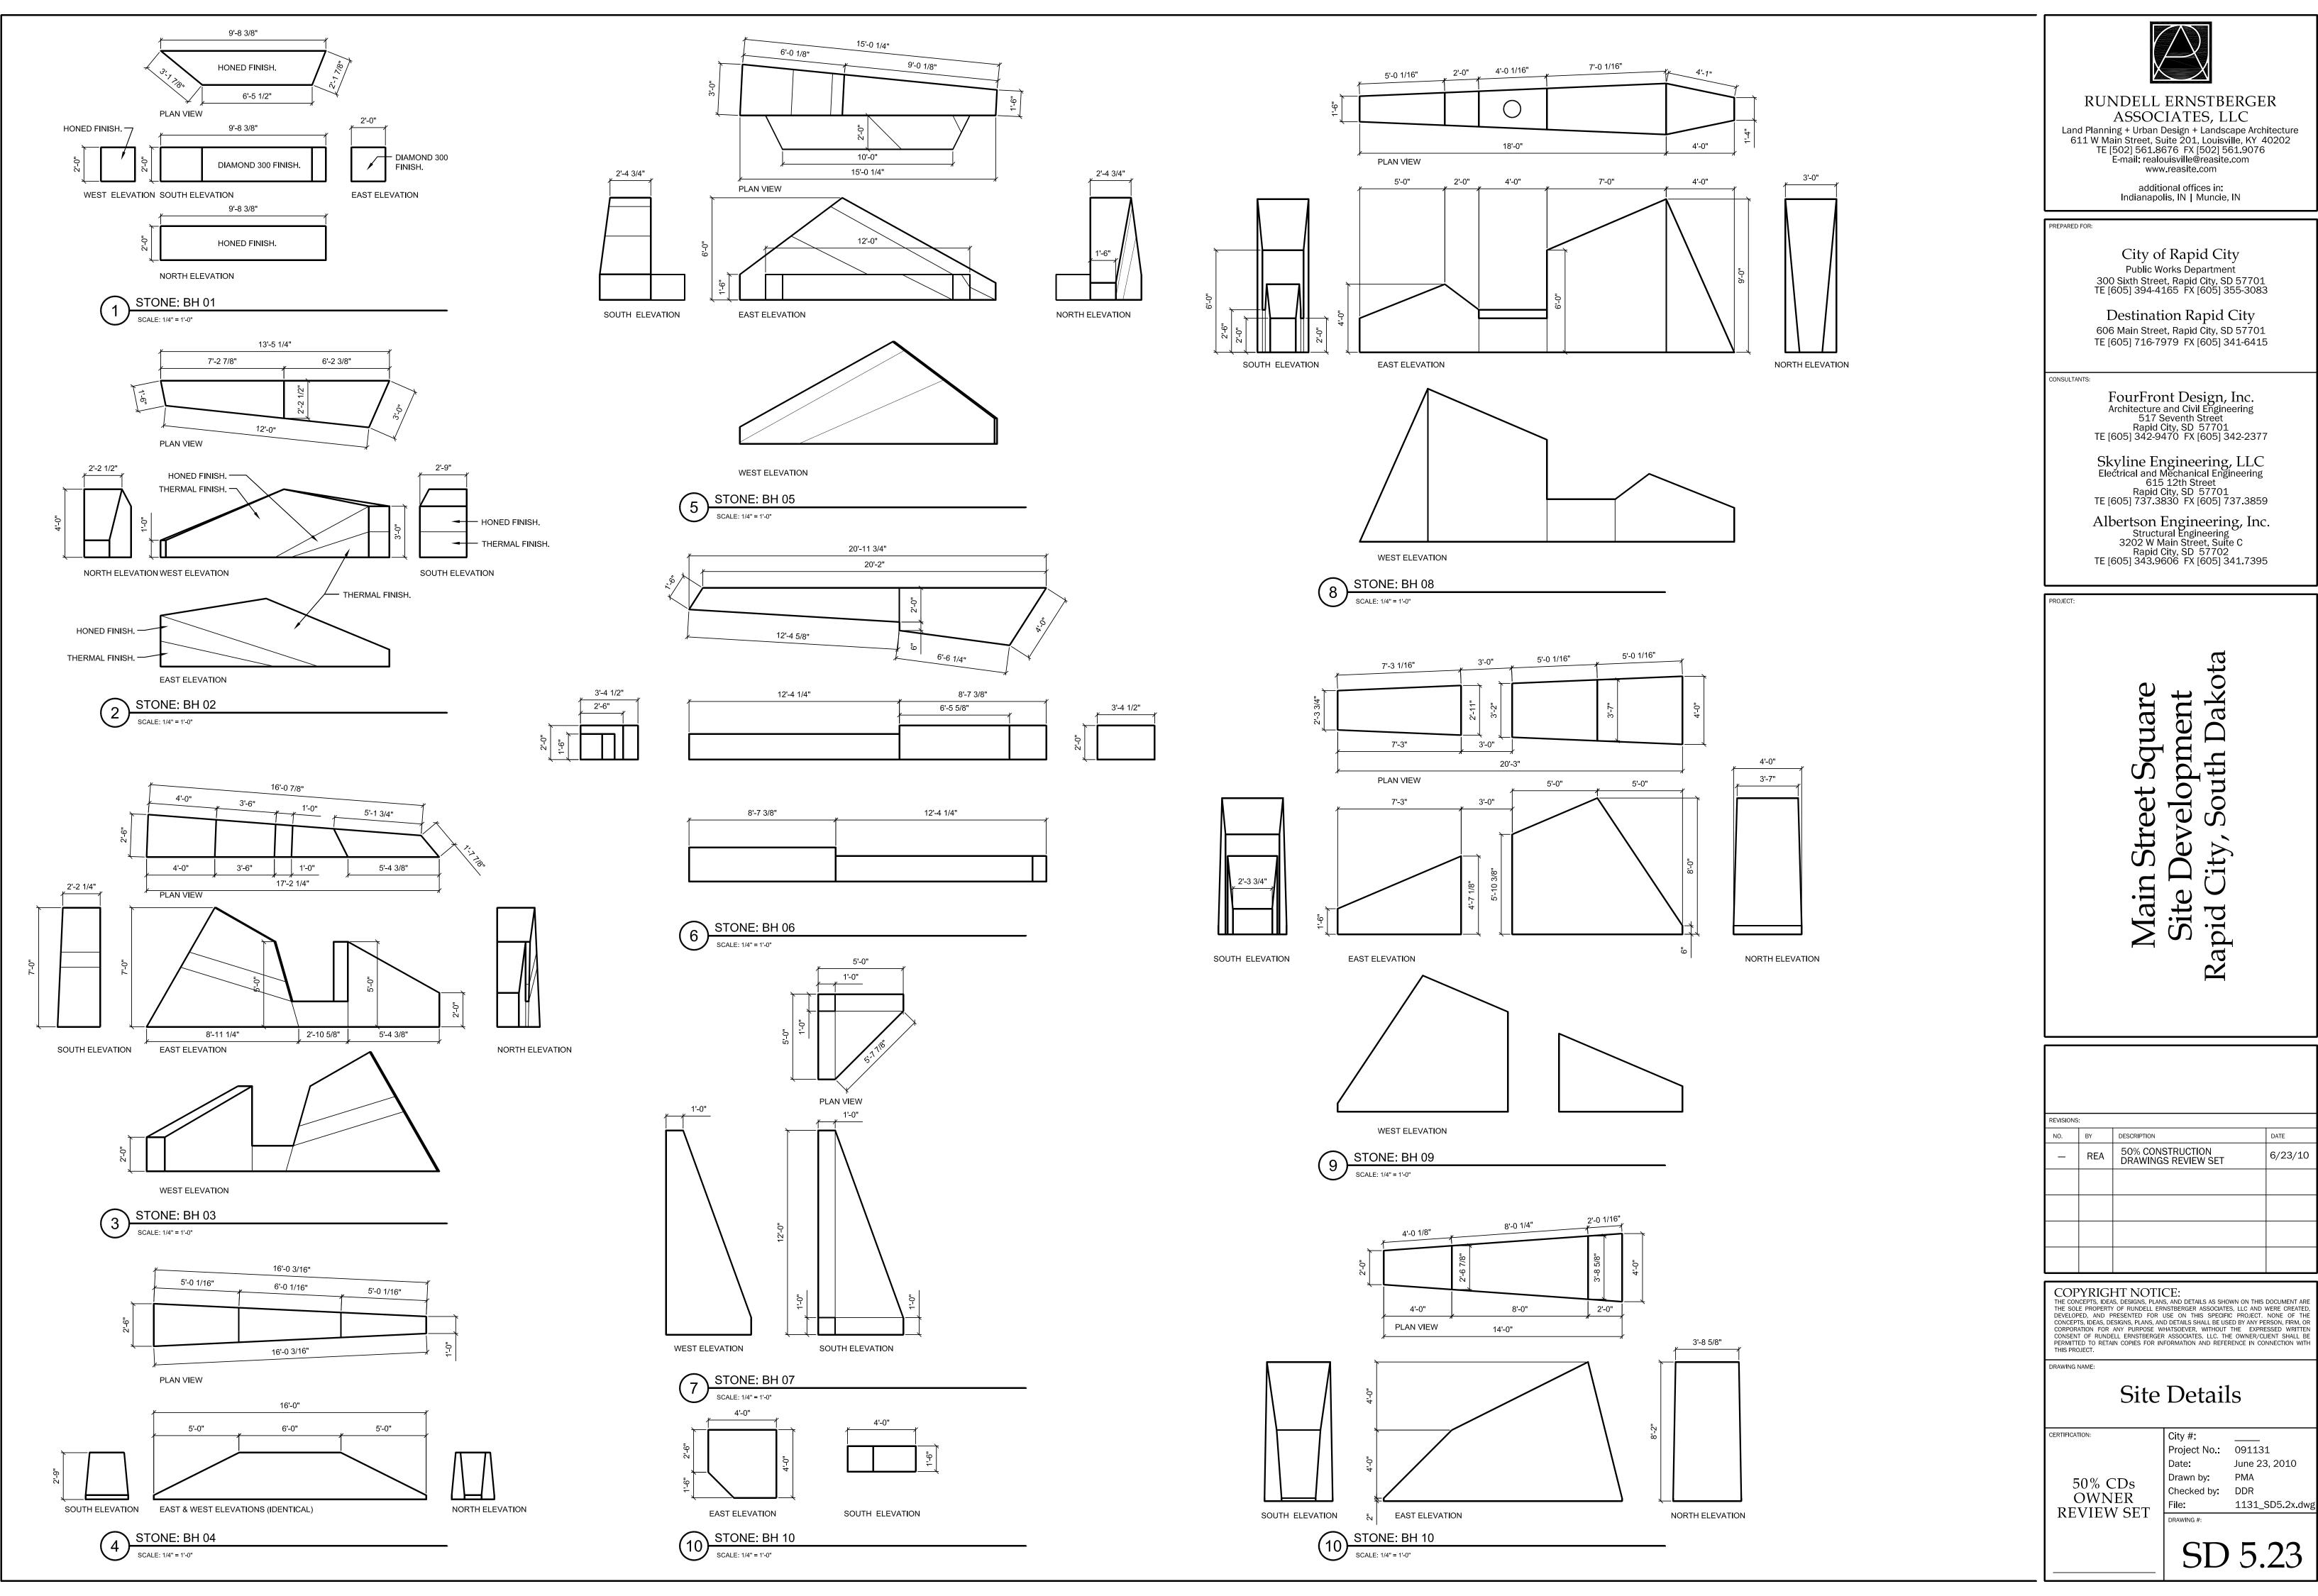
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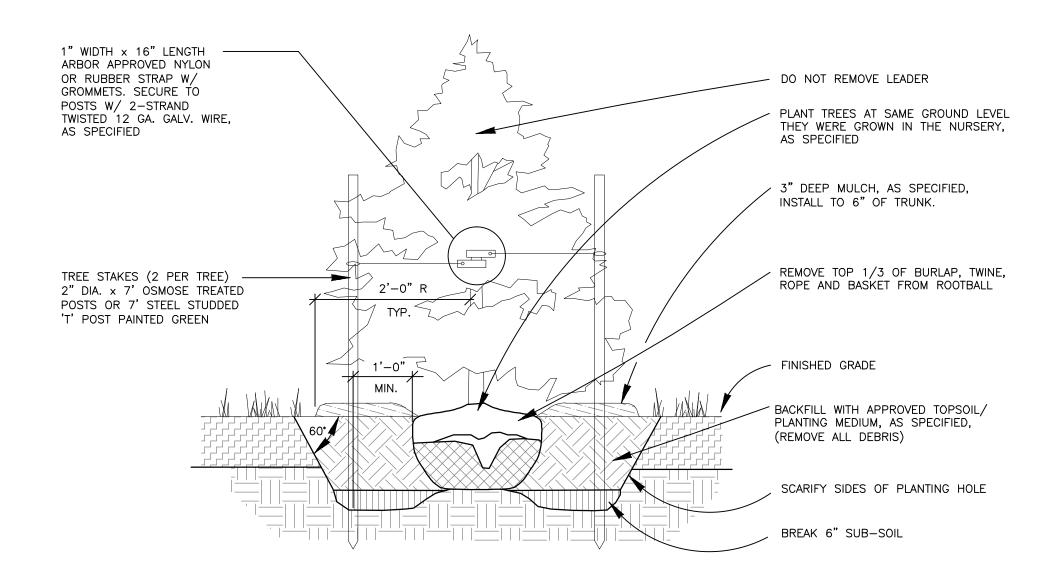


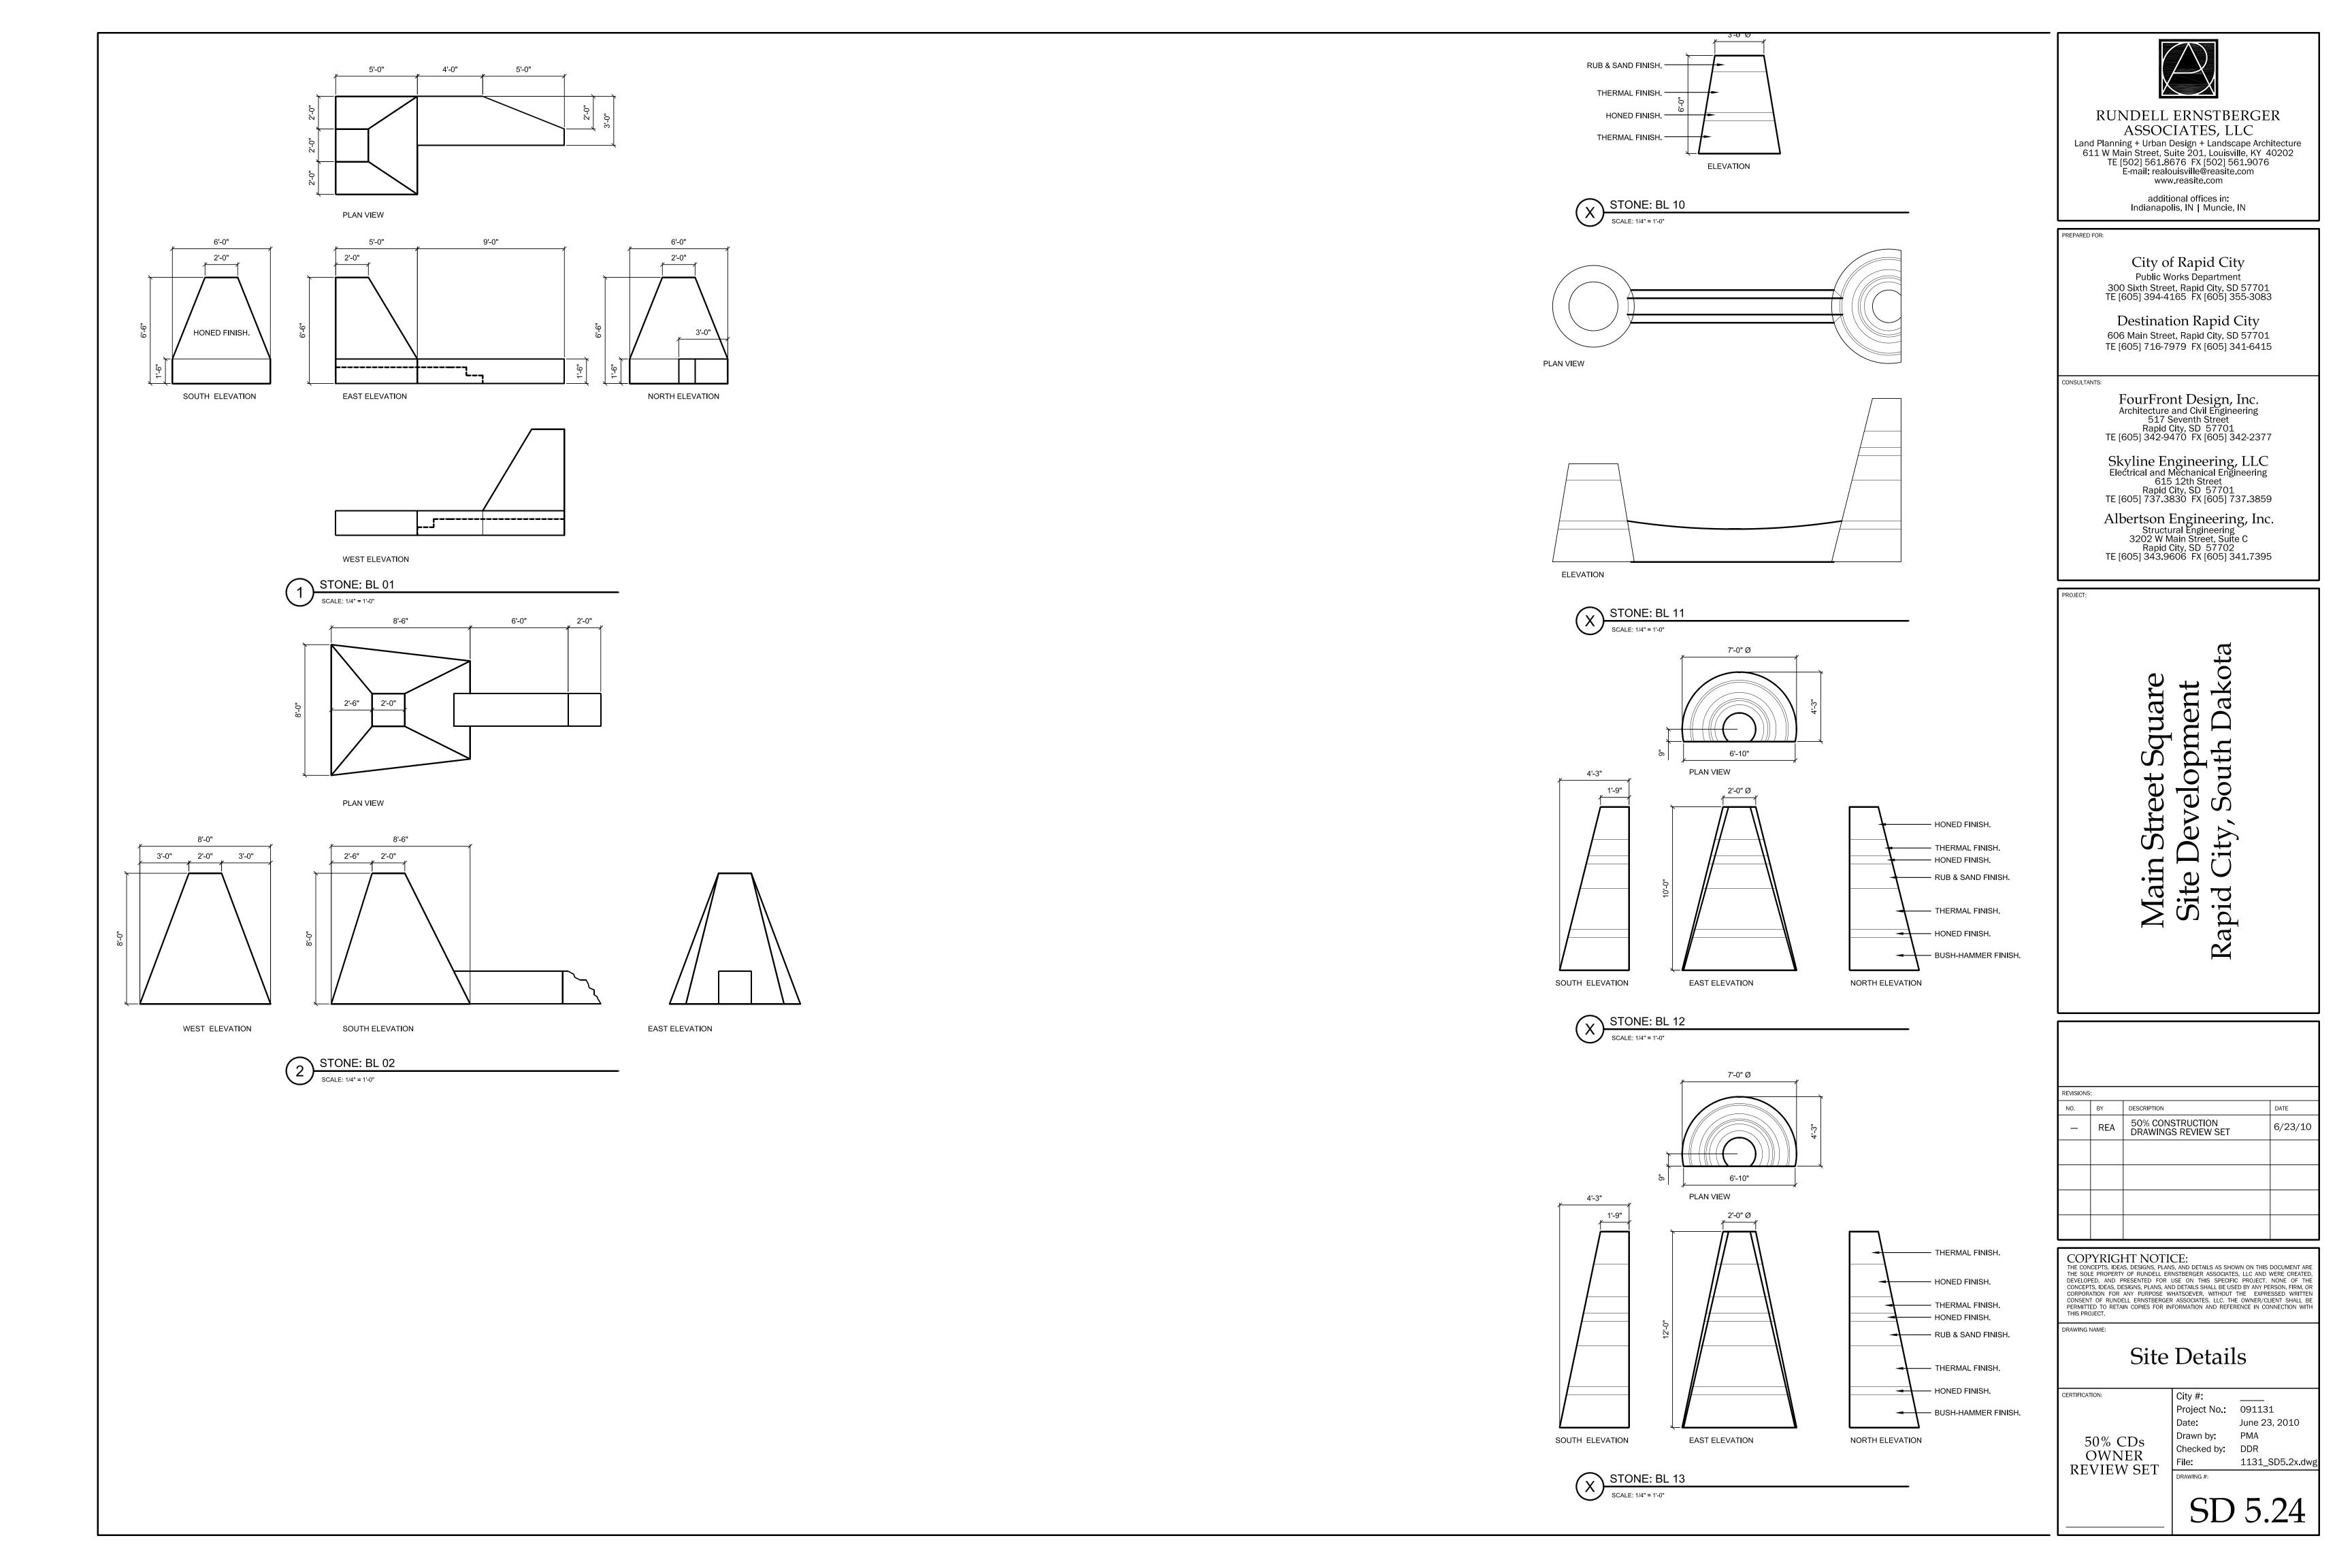


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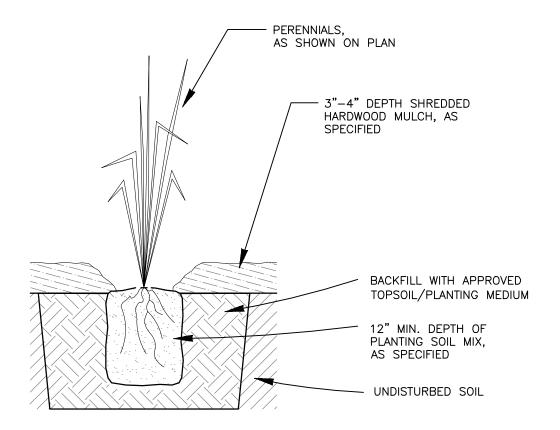


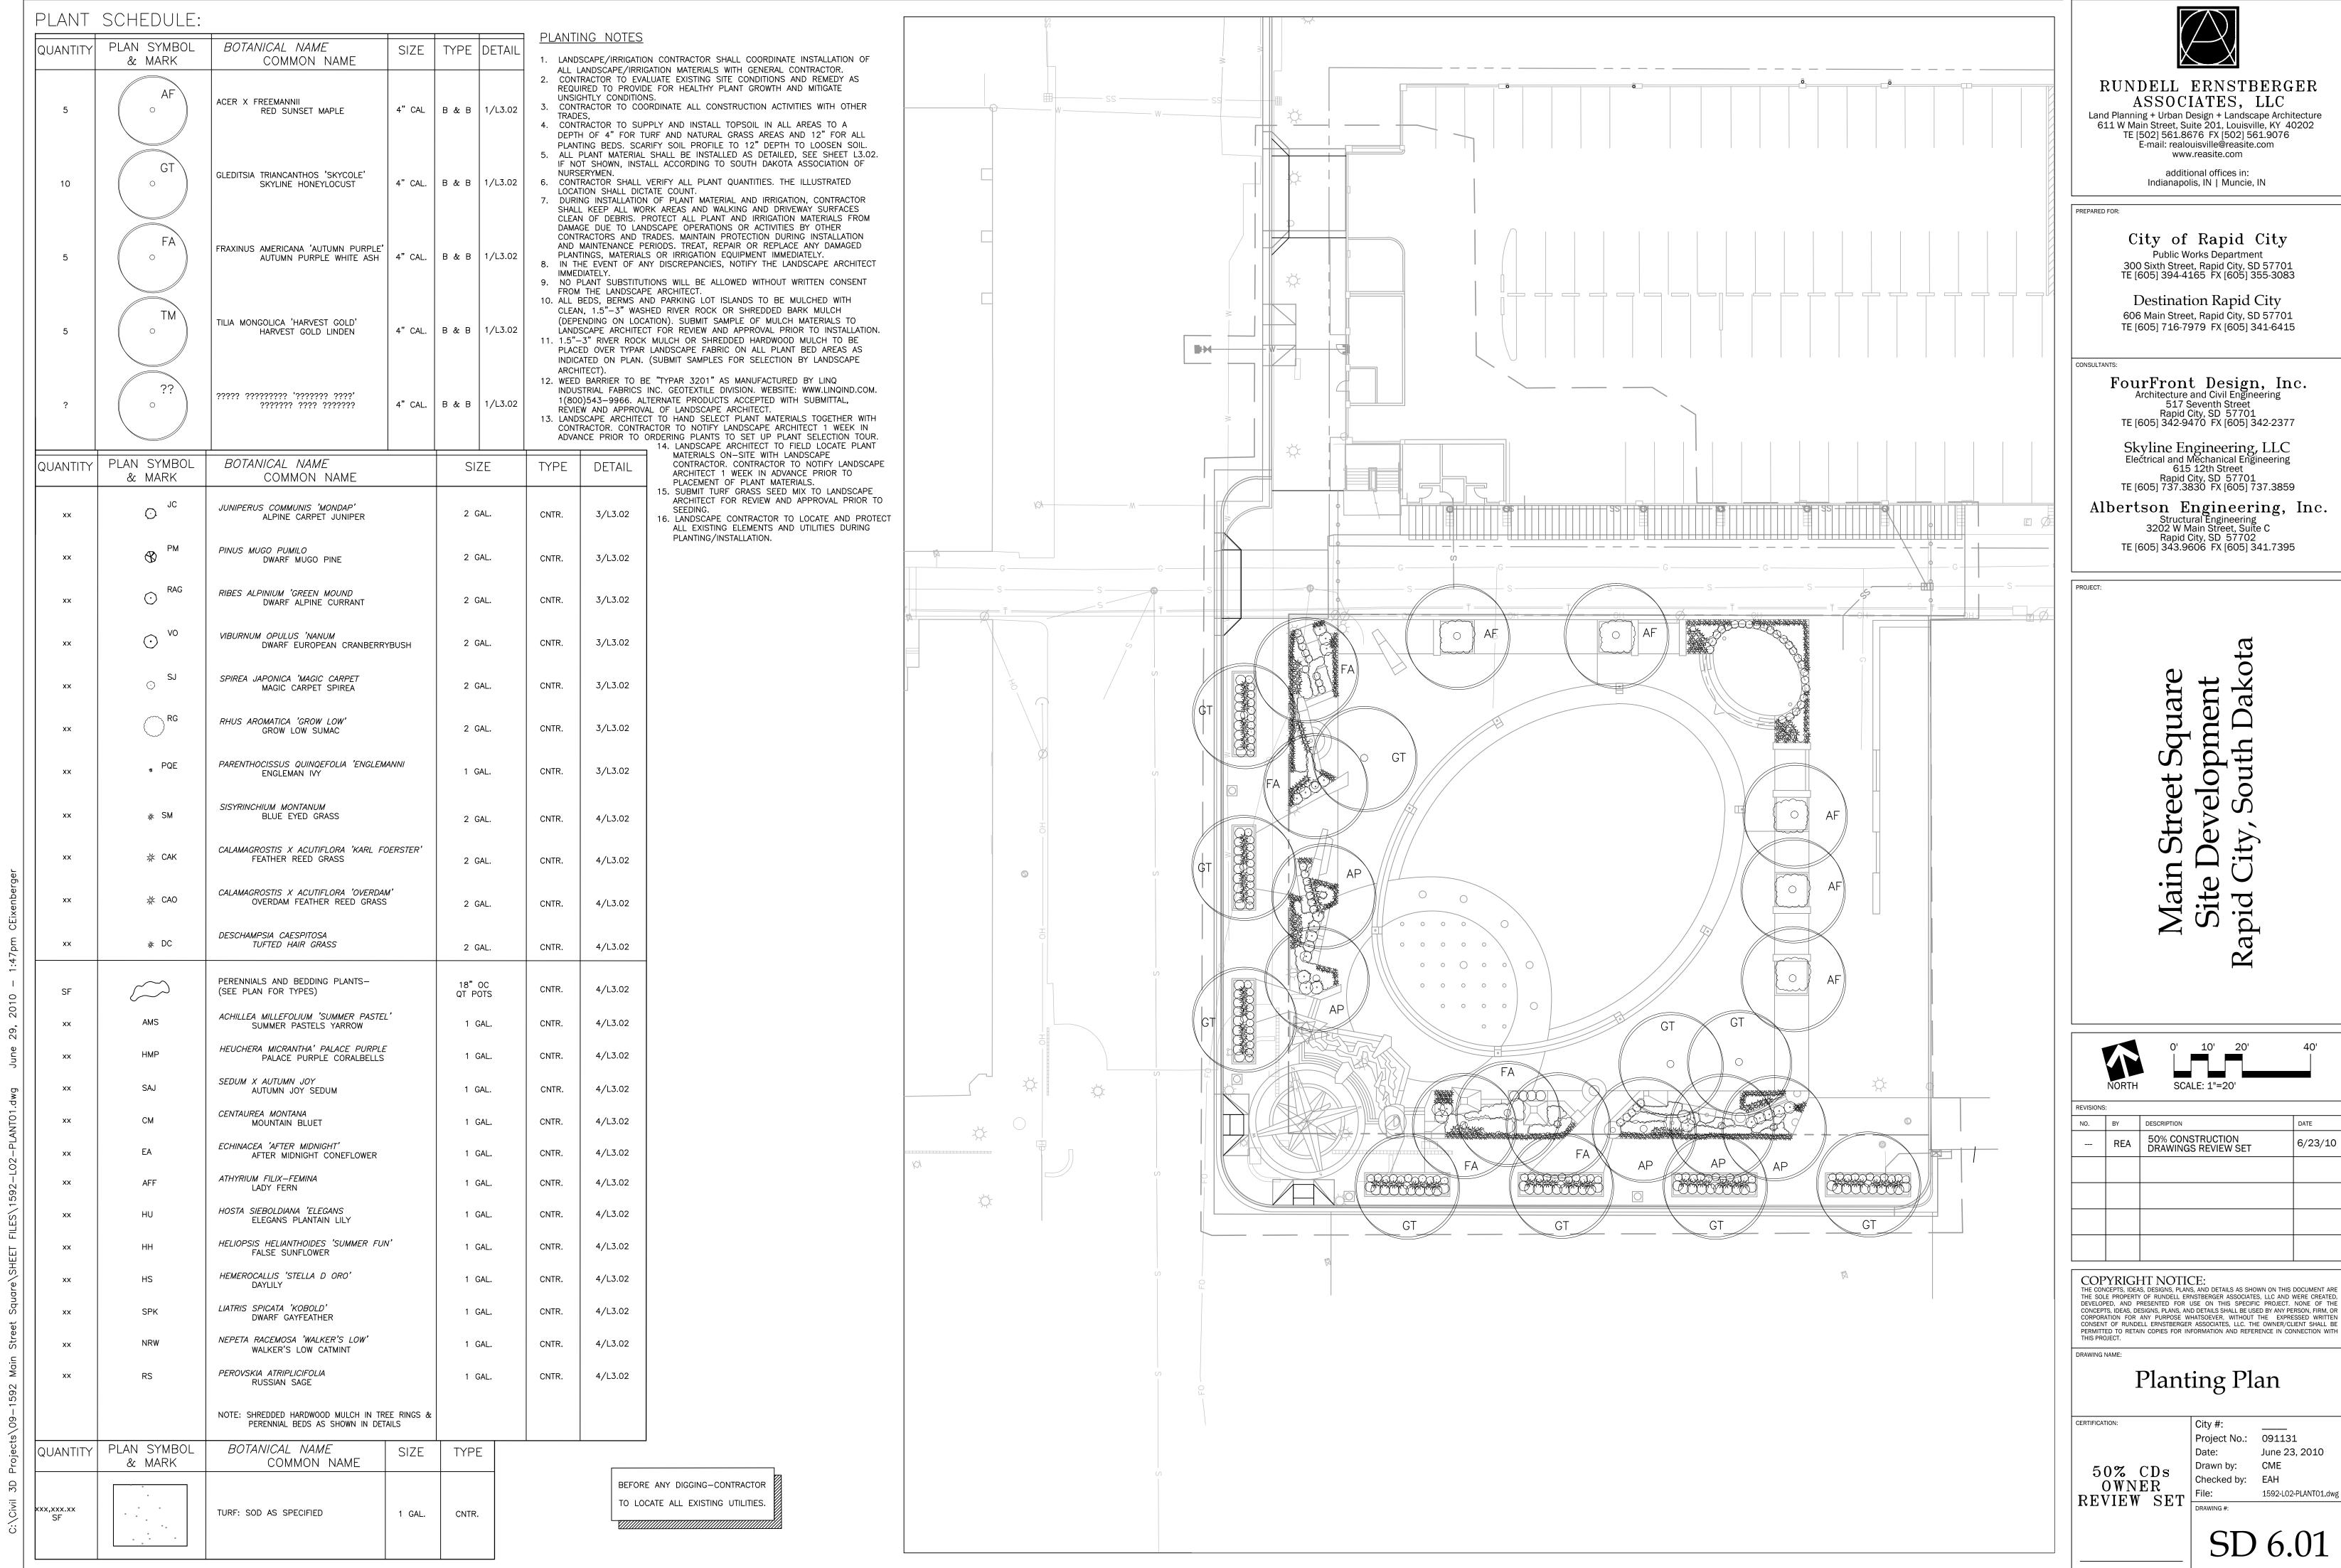DECIDUOUS TREE PLANTING DETAIL NOT TO SCALE L3.02




CONIFEROUS TREE PLANTING DETAIL NOT TO SCALE L3.02



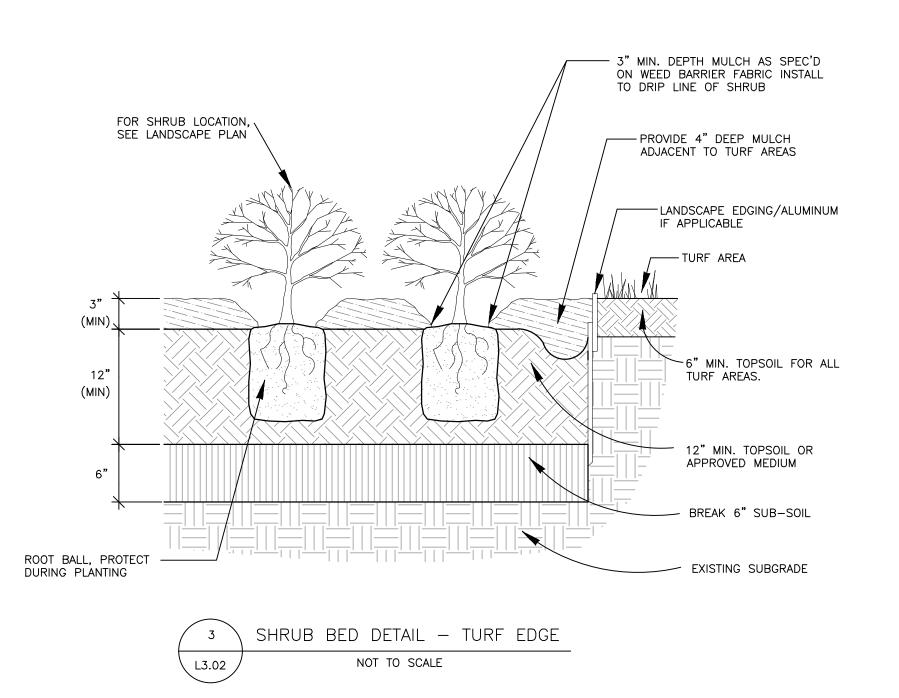

PERENNIAL & GRASS PLANTING DETAIL \ L3.02 NOT TO SCALE

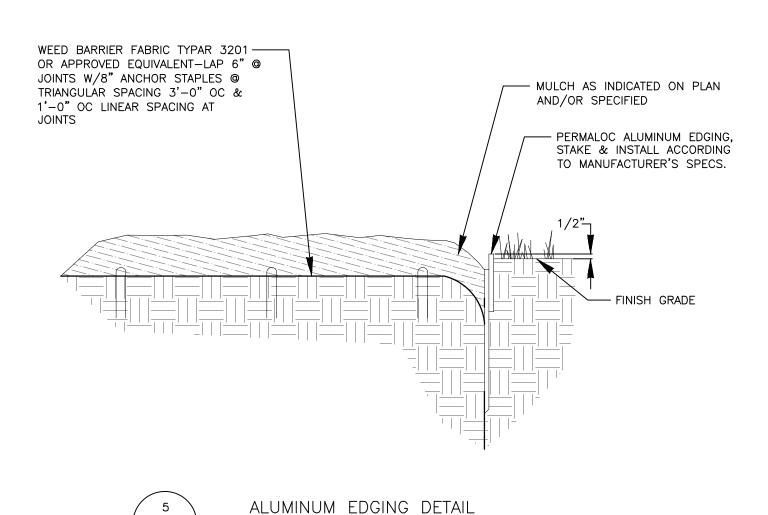

NOT TO SCALE

L3.02

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# Square zelopment South Dako

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Planting Details & Notes


Project No.: 091131 June 23, 2010 CME Checked by: EAH

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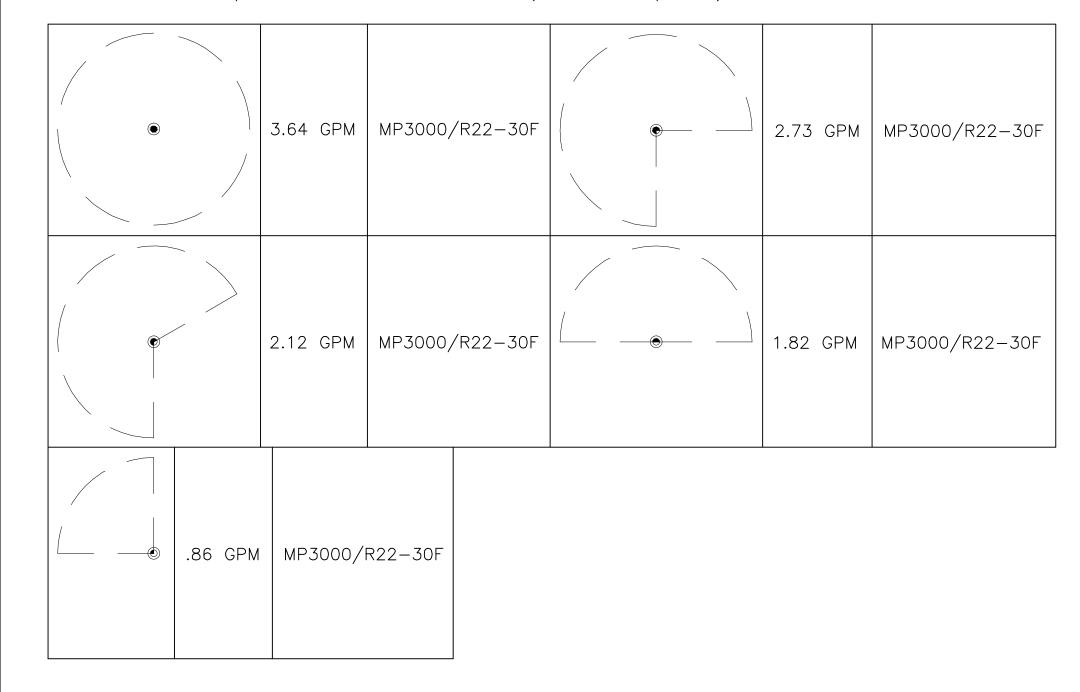
SD 6.02

|  | ON ELGEND, ALL EQU  |                        |                                 |   |                             |
|--|---|------------------------|---------------------------------|---|-----------------------------|
| SYMBOL                                 | DESCRIPTION   | SIZE                   | MANUF.                          | MODEL NUMBER  | DETAIL REF.                 |
| (W)                                    | ET SYSTEM  CONTROL VALVE  | 11½"x20¾" SEE CALL OUT | HUNTER OR EQUAL HUNTER OR EQUAL | ET SYSTEM & ET WIND  ICV-101G ELECTRIC CONTROL VALVES | 8/L4.02, 7/L4.02<br>1/L4.02 |
|  | DRIP CONTROL VALVE  | SEE CALL OUT           | HUNTER OR EQUAL                 | ICZ-101   | 2/L4.02                     |
| $\bowtie$                              | ISOLATION GATE VALVE  | LINE SIZE              | PVC BALL VALVE                  | PROVIDE PRODUCT DATA                                  | 3/L4.02                     |
|  | QUICK COUPLER VALVE   | 1"                     | HUNTER OR EQUAL                 | HQ-44LRC  | 4/L4.02                     |
| C                                      | CONTROLLER  | 24 STATION             | HUNTER OR EQUAL                 | ICC-1200-POTS WITH SOLAR SYNC ADDITION                |                             |
| Ol Ol                                  | BLOWOUT ASSEMBLY  | 1" FEMALE<br>THREADED  | HUNTER OR EQUAL                 | 5-NP (IF NEEDED)                                      |                             |
| RS                                     | RAIN SENSOR   | SEE CALL OUT           | HUNTER OR EQUAL                 | RAIN CLIK OR EQUAL                                    | 6/L4.02                     |
|  | DOUBLE CHECK<br>VALVE ASSEMBLY  | 1"                     | WATTS OR EQUAL                  | 007-M1-QT   |                             |
|  | CONTINUOUS ACTING AIR<br>& VACUUM RELIEF VALVE                                    | LINE SIZE              | HUNTER OR EQUAL                 | CR-101  |                             |
| FA                                     | FILTER ASSEMBLY   | 1"                     | HUNTER FILTER OR EQUAL          | T100100F, 1" "T" BODY AND 100 MESH FILTER             |                             |
| FS)                                    | FLOW SENSOR   | 1"                     | HUNTER OR EQUAL                 | HFS W/FCT150  | 5/L4.02                     |
| <del> </del> <del> </del> <del> </del> | ELECTRICAL GROUNDING  |                        |                                 |   |                             |
| (P)                                    | POINT OF CONNECTION,<br>35 GPM @ 65 PSI<br>(COORDINATE WITH<br>EXISTING SYSTEMS.) |                        |                                 |   |                             |
|  | LATERAL LINE  | 1"                     |                                 | SCH 40 PVC  | 10/L4.02                    |
|  | NEW MAIN LINE   | 1.5"                   |                                 | SCH 40 PVC  | 10/L4.02                    |
|  | SLEEVE LINES  |                        |                                 | SCH 80 PVC (SCH40 PVC UNDER WALKS & TRAILS)           | 10/L4.02                    |
| ``                                     | COMMUNICATION WIRE IN MAIN LINE TRENCH  |                        | HUNTER/ PAGE ELECTRIC           | P7183D  | 10/L4.02                    |
|  | DRIP TUBING   |                        | HUNTER OR NETAFIM               | POLYETHYLENE TUBING                                   |                             |

POINT SOURCE DRIP: TREES=(3)2 GPH EMITTERS SHRUBS=(2)1 GPH EMITTERS, PERENIALS=(2)1/2 GPH

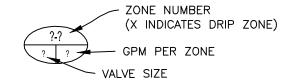

SPRINKLER HEAD LEGEND HUNTER IRRIGATION PARTS OR APPROVED EQUAL ROTARY HEADS w/ MP ROTATOR 8-30 NOZZLES (SEE DETAIL 5/L4.05)




#### IRRIGATION NOTES: ALL IRRIGATION HEADS TO BE INSTALLED 6" AWAY FROM BUILDING WALLS.

- CONTRACTOR TO VERIFY EXISTING CONDITIONS, ALL EXISTING UTILITIES ARE TO BE LOCATED BEFORE ANY TRENCHING OF ANY KIND BEGINS. 2. PROTECT ALL EXISTING IMPROVEMENTS TO REMAIN AND REPAIR BACK TO ORIGINAL CONDITION AT CONTRACTOR'S EXPENSE IF DAMAGE OCCURS RESULTANT FROM
- CONTRACTOR'S OPERATIONS OR NEGLIGENCE. 3. RE-GRADE AND RECLAIM ALL EXISTING LAWN AREAS DISTURBED BY CONTRACTOR'S OPERATIONS AS PER SPECIFICATIONS. A DISTURBED AREA SHALL BE WHERE CONSTRUCTION ACTIVITIES INCLUDING TRENCHING, DEMOLITION, EARTHWORK, MATERIAL STORAGE, STAGING, PARKING OR ANY OTHER FORM OF EXCAVATION,
- COMPACTION OR TRAFFIC RESULTS IN THE REMOVAL OR DISPLACEMENT OF EXISTING GROUND COVER OR GRADE. COORDINATE WITH GENERAL CONTRACTOR. . COORDINATE WORK THIS SHEET WITH ALL OTHER TRADES. SYSTEM DESIGN IS BASED UPON AVAILABILITY OF 65 MIN. PSI AT THE POINTS OF CONNECTION, 45 PSI AT ROTORS AND 30 PSI AT SPRAY HEADS. NOTIFY
- LANDSCAPE ARCHITECT OF ANY DISCREPANCIES. ZONES SHALL NOT EXCEED 35 GPM. INSTALL IRRIGATION SYSTEM AS DETAILED AN D PER SPECIFICATIONS.
- IRRIGATION PIPING LAYOUT IS SCHEMATIC. ACTUAL LOCATION OF PIPING AND OTHER COMPONENTS MAY VARY DUE TO EXISTING SITE CONDITIONS.
- COORDINATE HEAD LOCATIONS WITH EXISTING PLANTS TO ENSURE PROPER COVERAGE. PROVIDE ALL COMPONENTS REQUIRED TO COMPLETELY WINTERIZE THE IRRIGATION SYSTEM WHETHER OR NOT SPECIFIED HEREIN.
- 10. INSTALL AN AIR RELIEF VALVE AT THE PIPE HIGH POINT. 11. INSTALL CONTROL WIRES FROM ELECTRIC VALVES TO CONTROLLER. (PROVIDE 2 EXTRA WIRES TO LONGEST RUN.)
- 12. SLEEVES SHALL BE (2) SIZES LARGER THAN PIPE OR COMBINATION OF PIPES THEREIN ENCLOSED, WITH MINIMUM SIZE TO BE 4" SUPPLY (1) EXTRA SLEEVE WITH EACH MAIN LINE SLEEVE FOR CONTROL WIRES. BORE UNDER EXISTING PAVING WHERE REQUIRED. BORE SEPARATELY FOR CONTROL WIRES.
- 13. PROVIDE TEMPORARY WATERING AS REQUIRED. COORDINATE PROTECTION OF EXISTING TREES AND PLANTS DURING CONSTRUCTION ACTIVITIES. 14. CONTRACTOR TO ADJUST IRRIGATION HEADS TO PROVIDE COMPLETE COVERAGE AND TO MINIMIZE OVER SPRAY ONTO BUILDINGS.
- 15. SEE DETAIL SHEET L401 INSTALLATION OF IRRIGATION COMPONENTS.

  16. PROVIDE POWER TO ALL IRRIGATION CONTROLLERS. COORDINATE POWER SOURCE WITH CITY OFFICIALS.
- 17. MAKE ALL IRRIGATION WIRE CONNECTIONS WITH DBY-6 OR DBR-6 DIRECT BURIAL CONNECTORS PER UL486D-DIRECT BURIAL. 18. CONTRACTOR TO SUBMIT IRRIGATION AS-BUILTS FOR REVIEW BY THE LANDSCAPE ARCHITECT.

BEFORE ANY DIGGING-CONTRACTOR TO LOCATE ALL EXISTING UTILITIES.

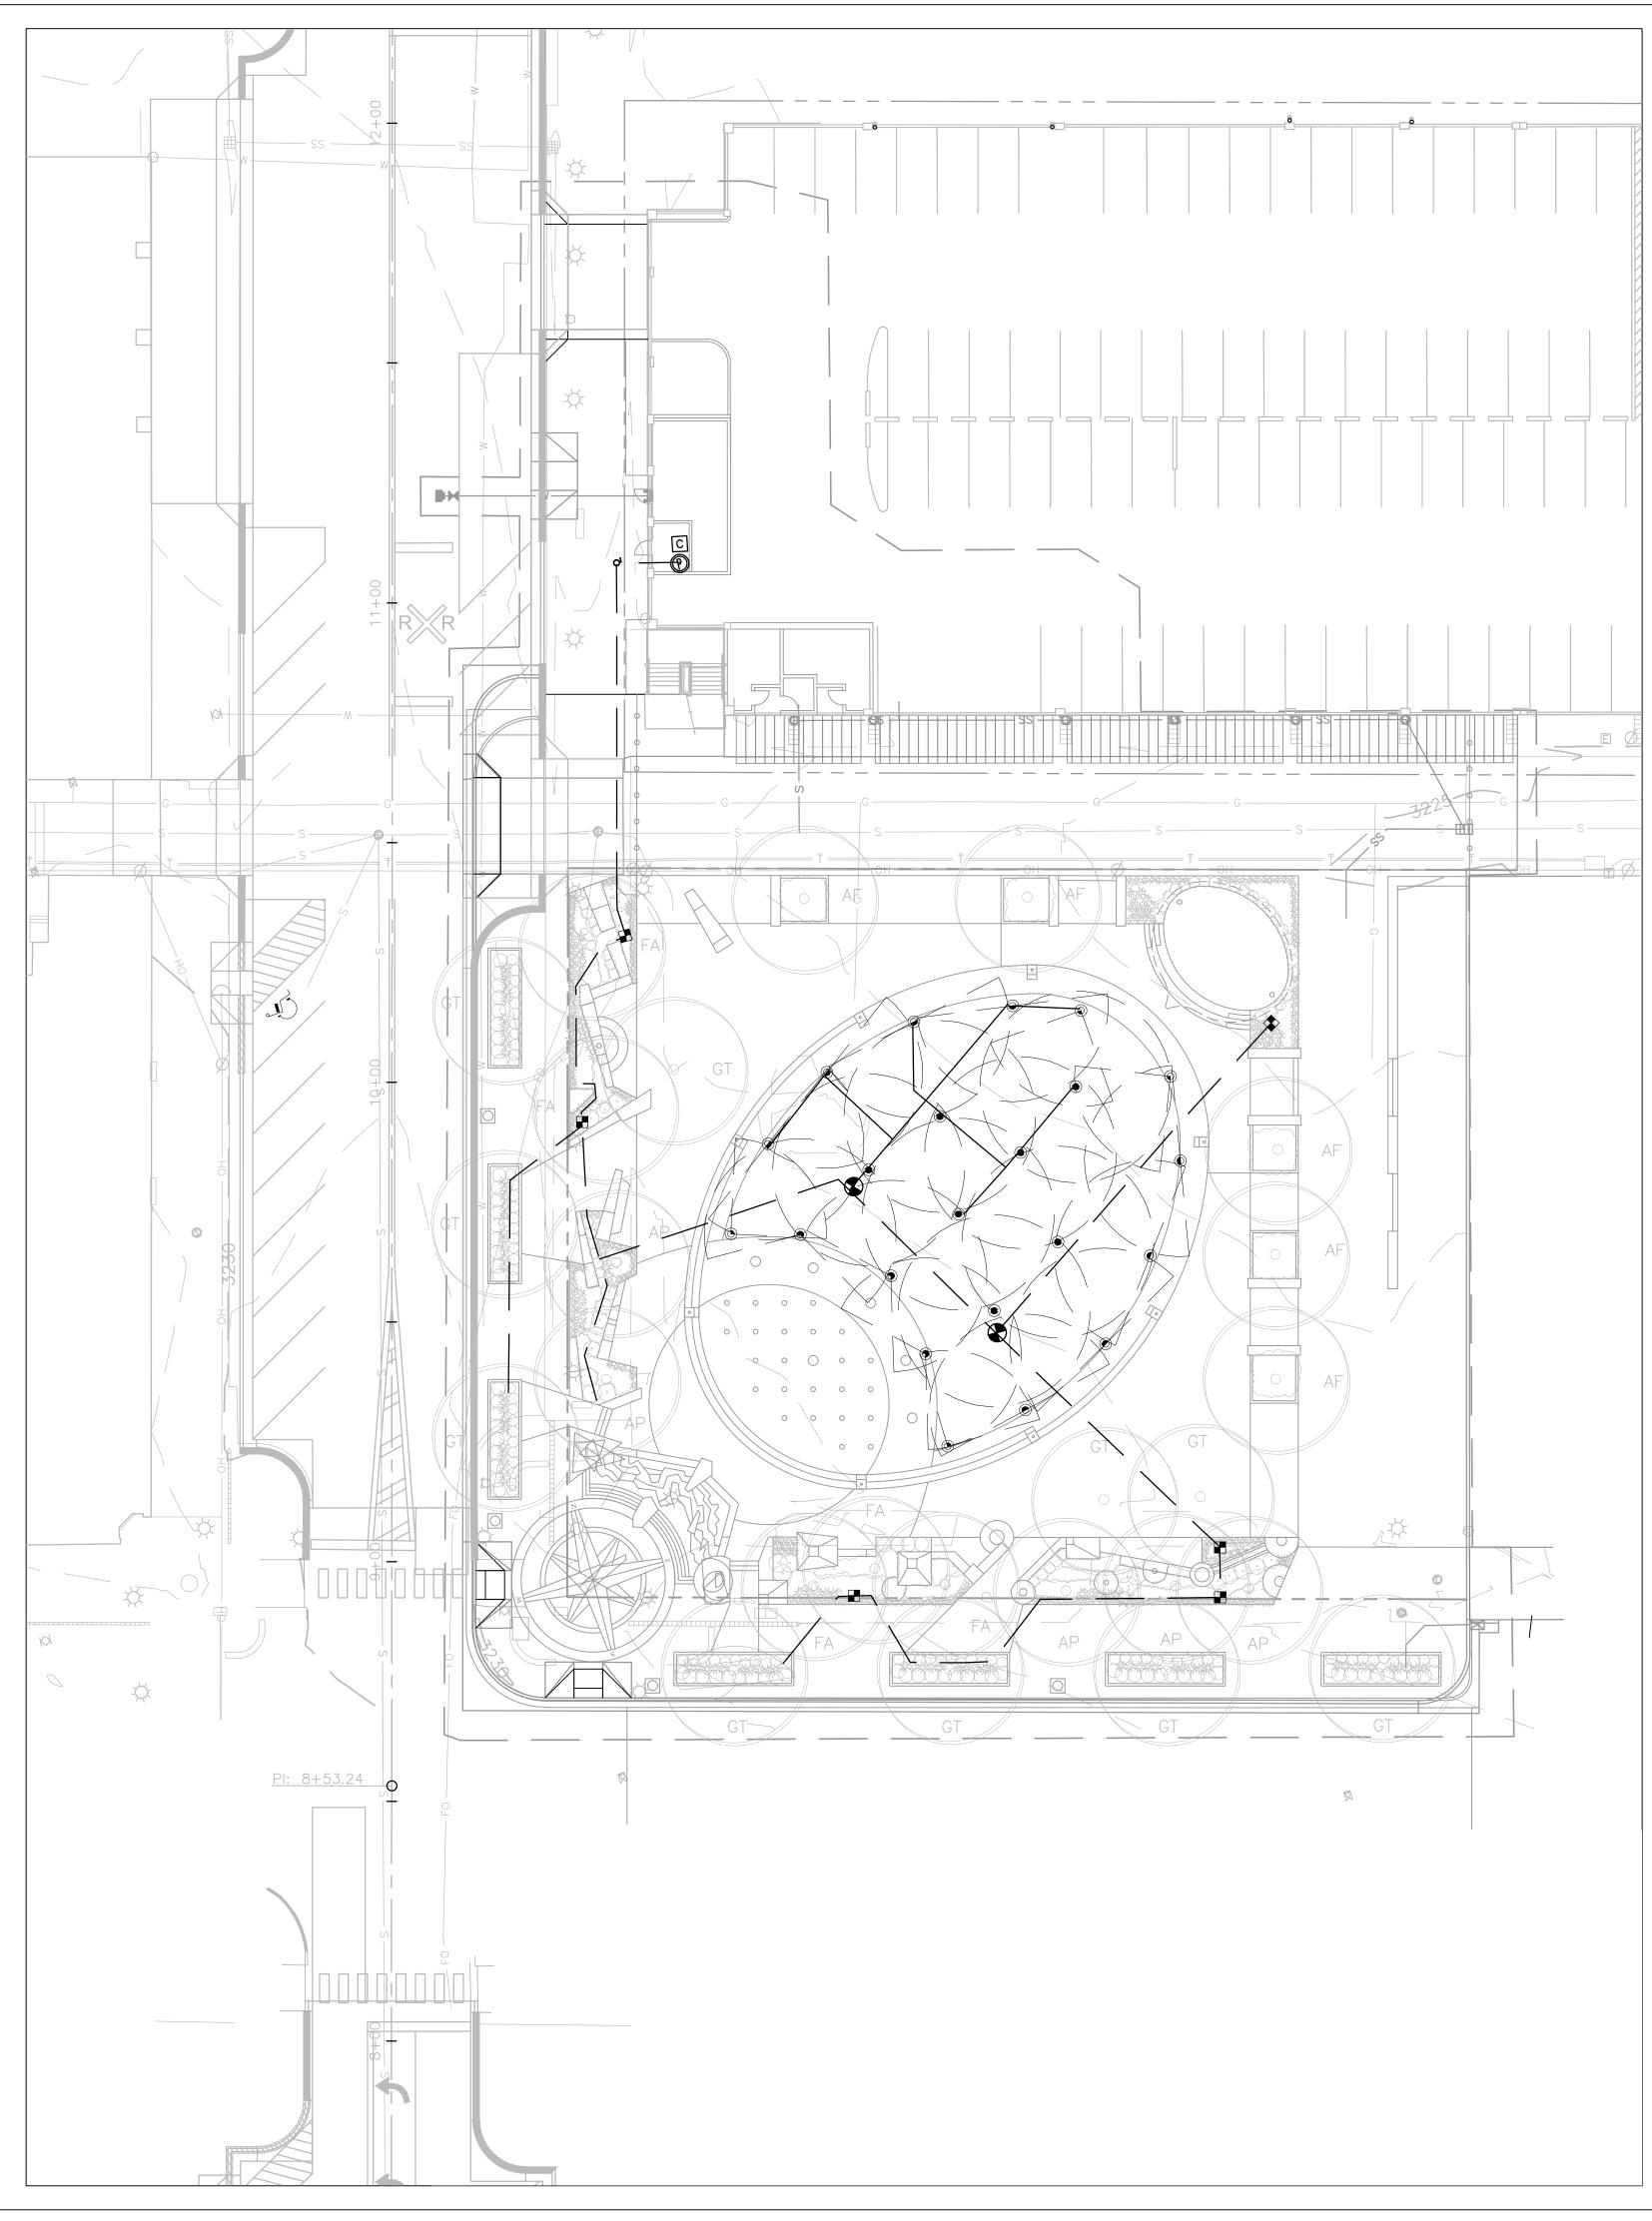



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|          | NORTH   | 0' 10' 20'<br>SCALE: 1"=20'             | 40'   |
|----------|---------|---|-------|
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| NO.      | BY      | DESCRIPTION                             | DATE  |
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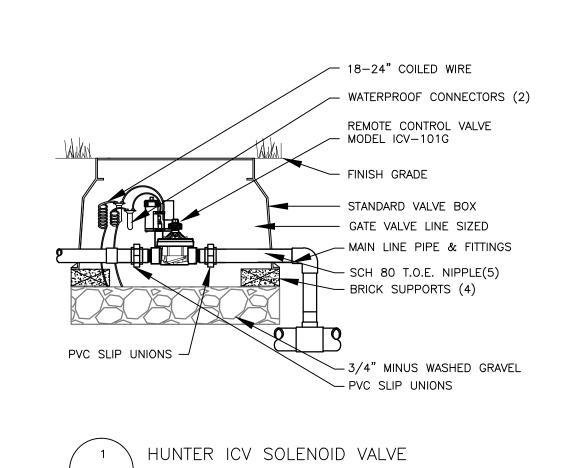
Irrigation Plan

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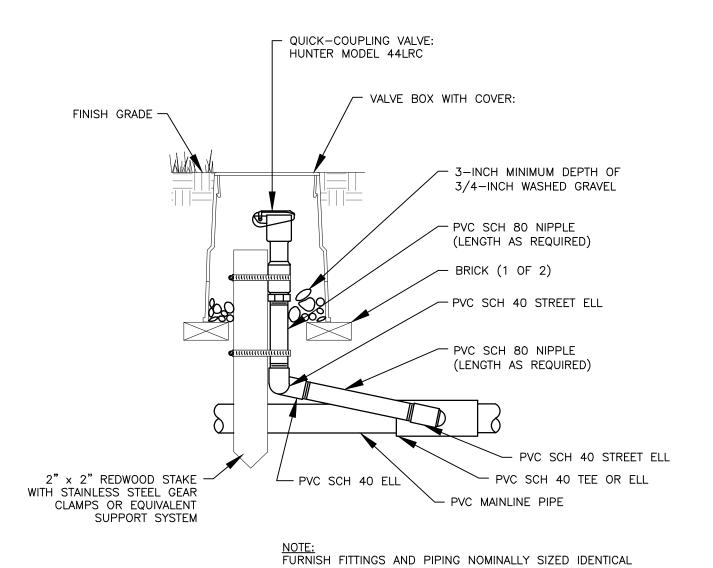
Project No.: 091131 June 23, 2010 CME Drawn by:

Checked by: EAH 1592-L02-IRRIGATE01.dwg

SD 6.03




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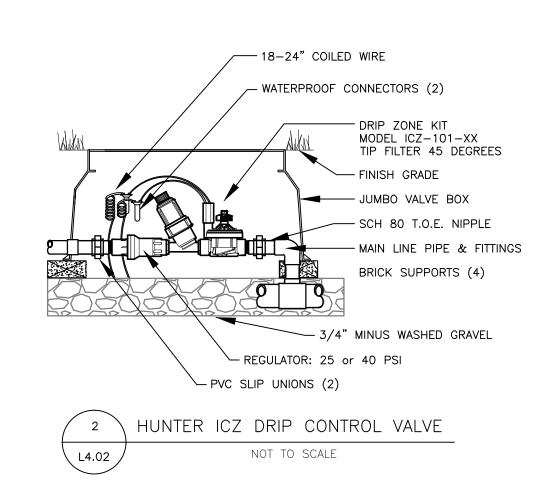



TO NOMINAL QUICK COUPLING VALVE INLET SIZE.







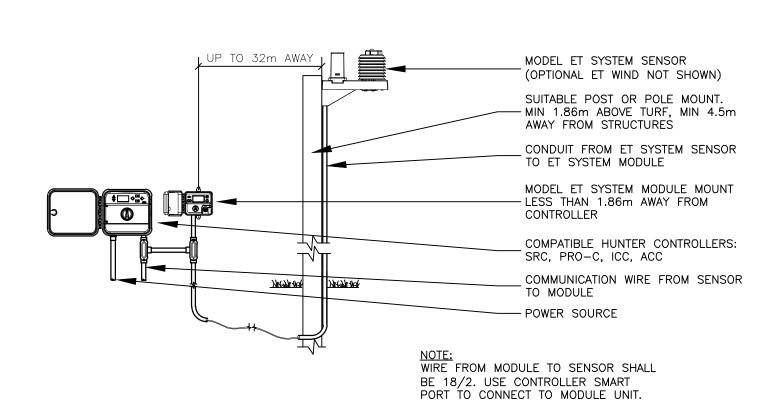



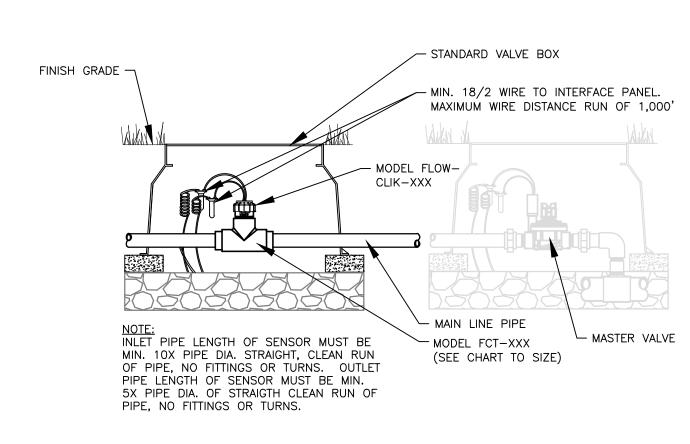

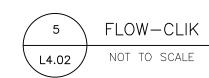

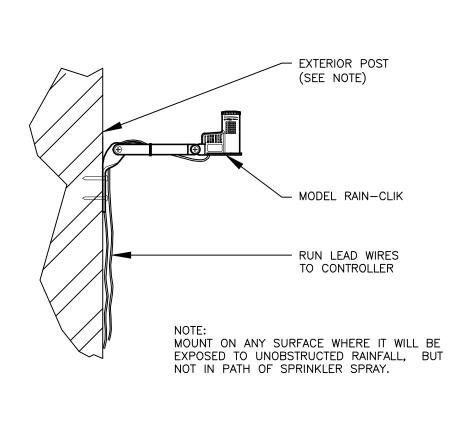


FINISH GRADE -


VALVE BOX -

AS SPECIFIED

GATE VALVE AS — SPECIFIED LINE SIZE

MAIN LINE PIPE -

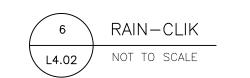

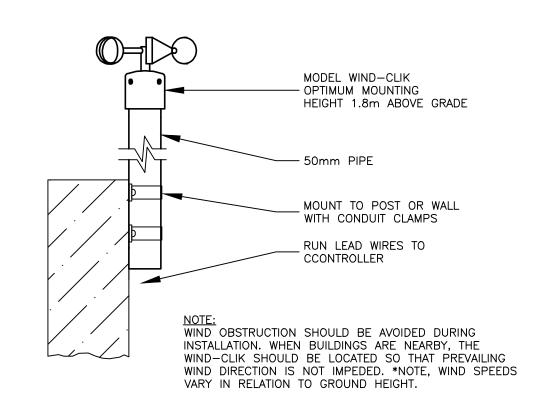


ISOLATION VALVE

NOT TO SCALE



TAPE & BUNDLE ALL WIRING AT 10' INTERVALS. USE 6" WIDE MARKING TAPE 6" ABOVE ALL DIRECT BURIAL WIRING. ALL SPLICES SHALL BE MADE IN VALVE BOXES AND LOCATED ON AS-BUILT PLANS. ALL 120 V. WIRING SHALL BE IN CONDUIT WITH MARKER TAPE AS ABOVE. ALL WIRING UNDER PAVEMENT & THROUGH SLEEVES SHALL BE IN CONDUIT. TIE A LOOSE 20" LOOP IN WIRING AT ALL CHANGES IN DIRECTION GREATER THAN 30" UNTIE ALL LOOPS

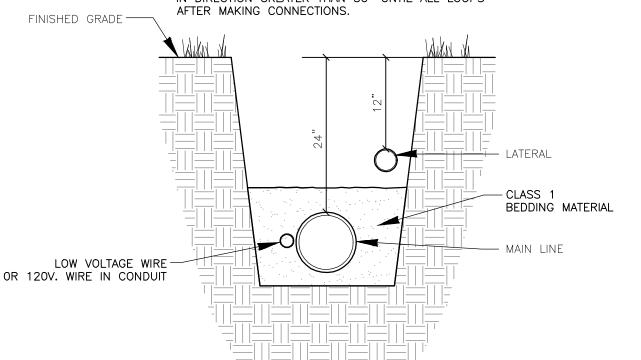





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PREPARED FOR:

- LINE SIZE BALL VALVE

SCH 80 PVC UNION

6" OF WASHED 3/4" AGGREGATE BASE

(1 OF 2)

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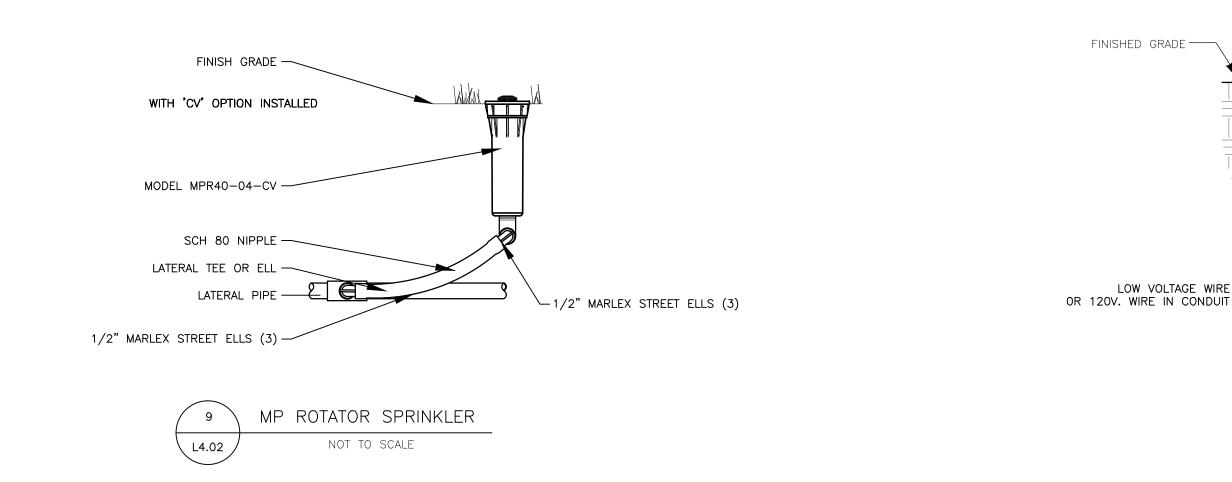
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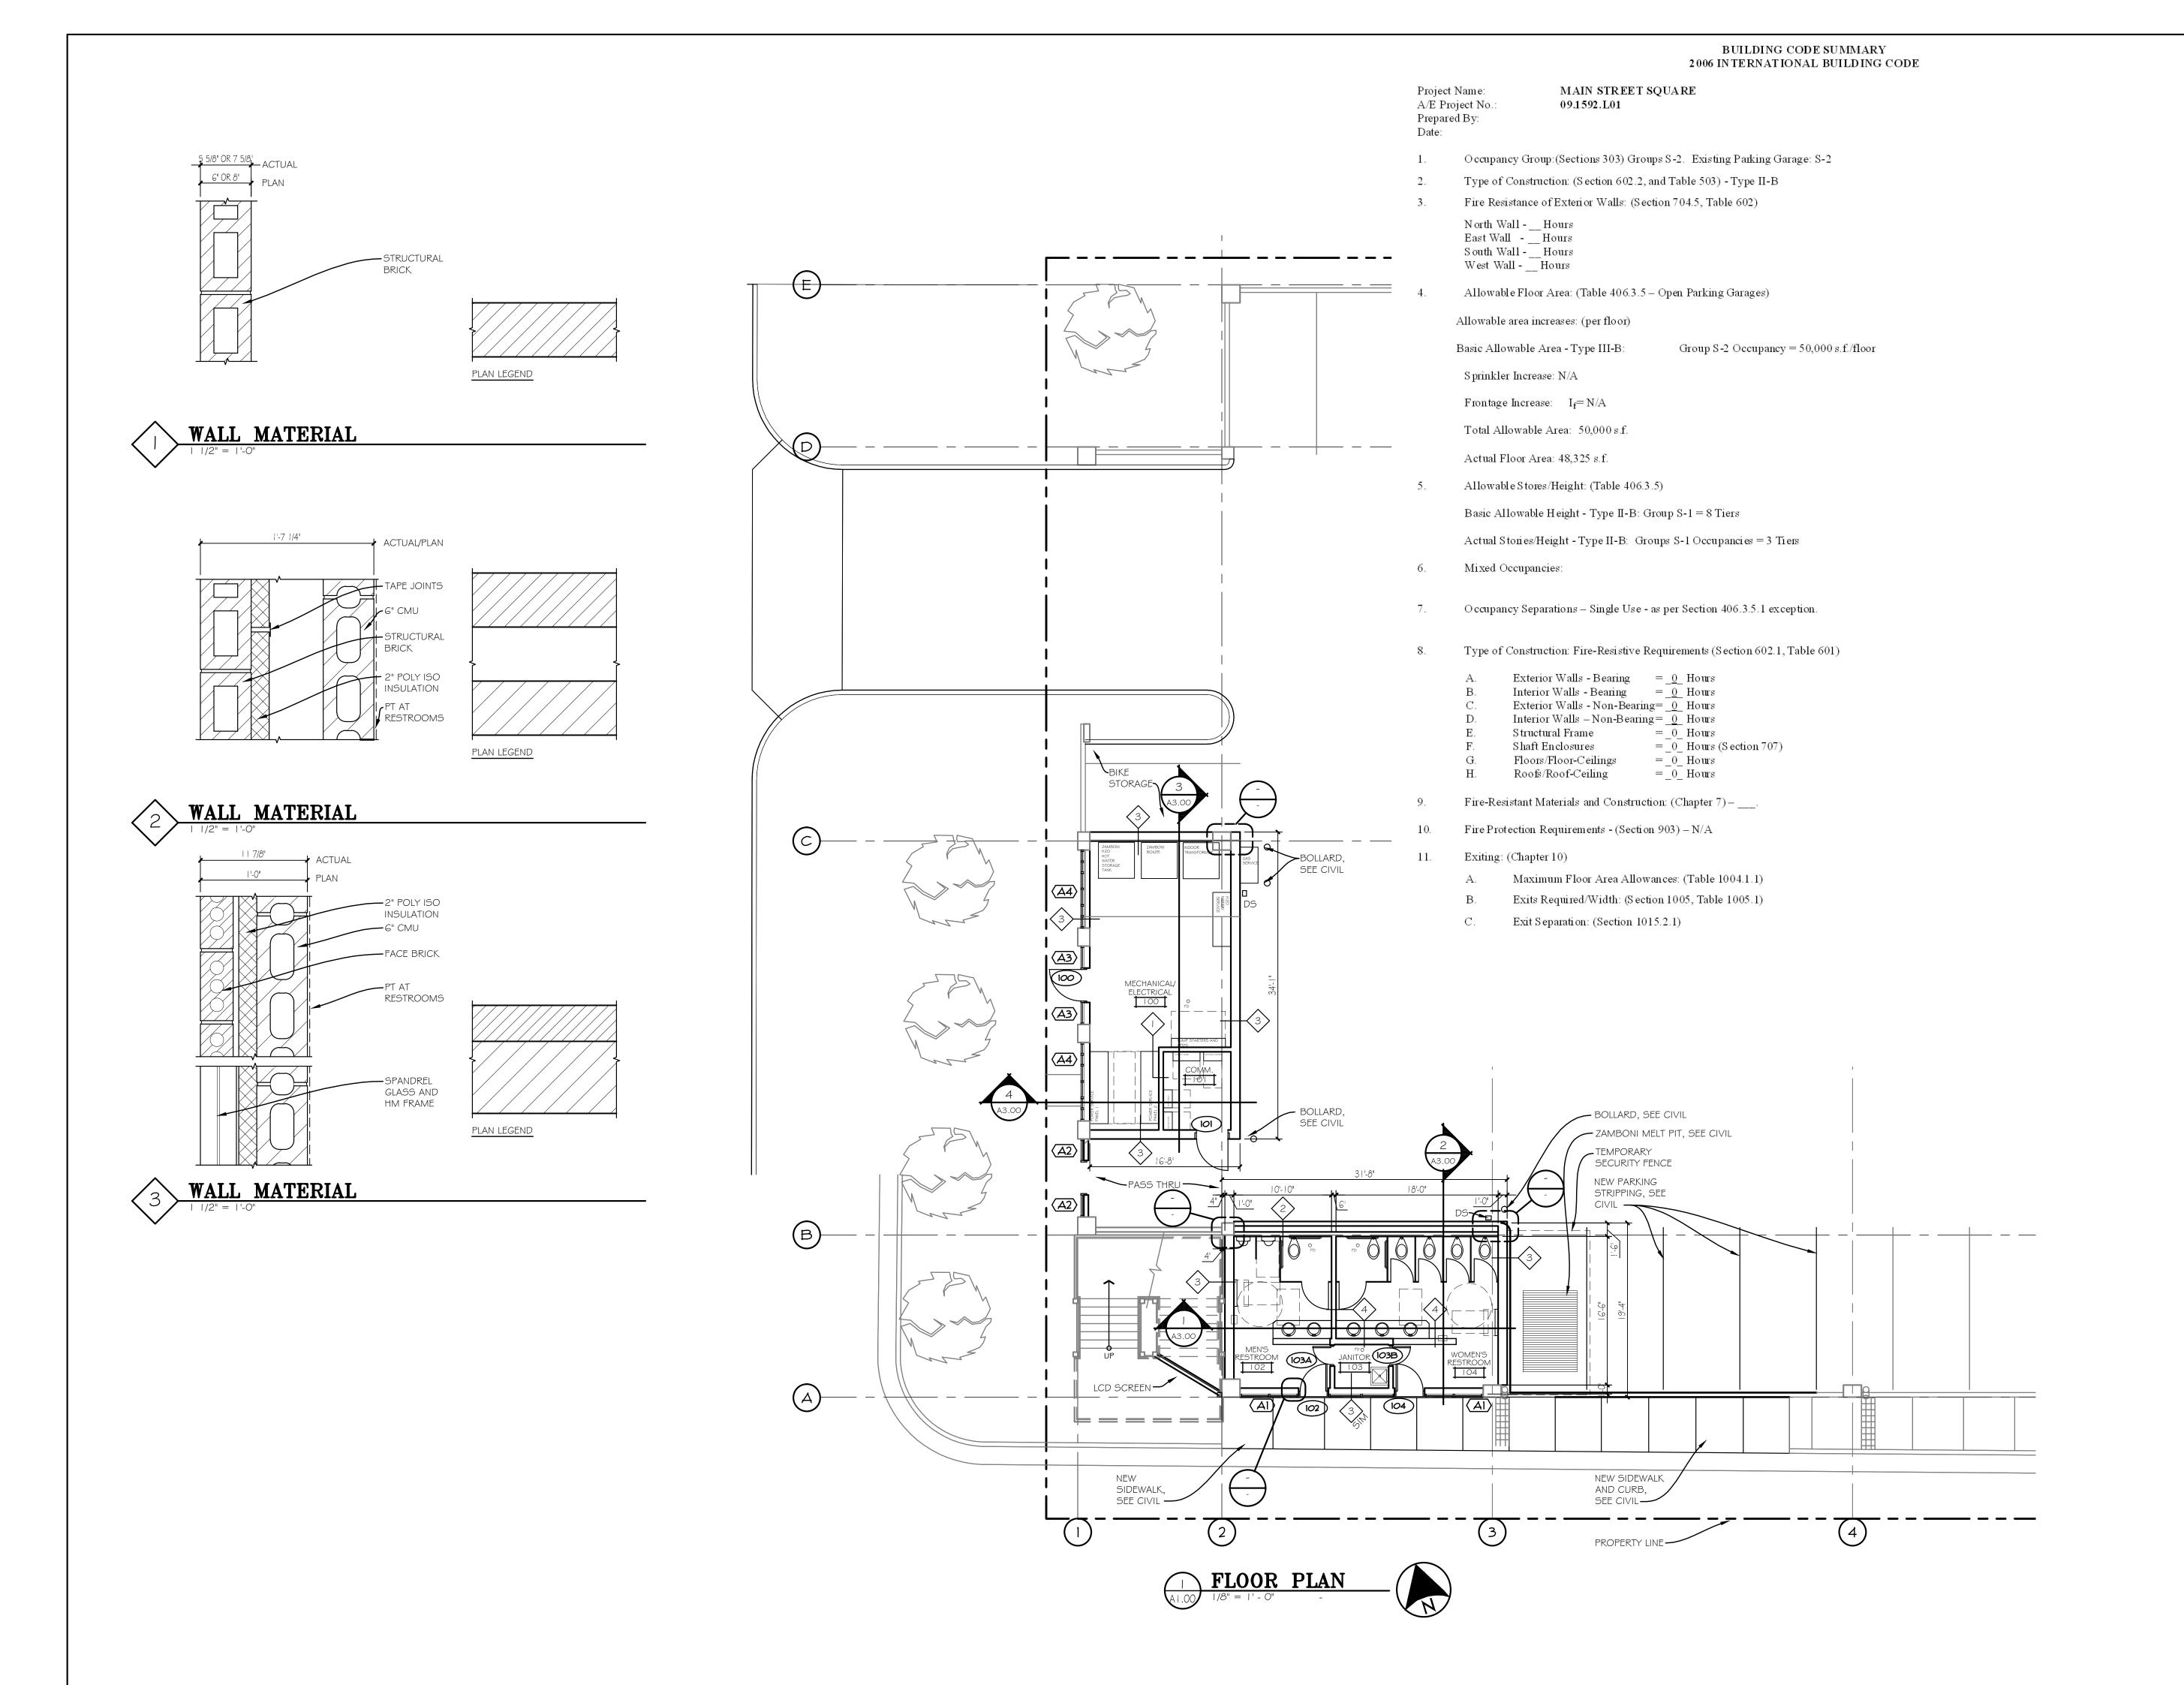
Irrigation Details & Notes

OWNER REVIEW SET DRAWING #:

CERTIFICATION:

Project No.: 091131 June 23, 2010 Date: CME Drawn by: Checked by: EAH 1592-L02-INOTE01.dwg







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Destination Rapid City 606 Main Street, Rapid City, SD 57701 TE [605] 716-7979 FX [605] 341-6415

CONSULTANTS:


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PROJECT:

Main Street Square Site Development Rapid City, South Dakota



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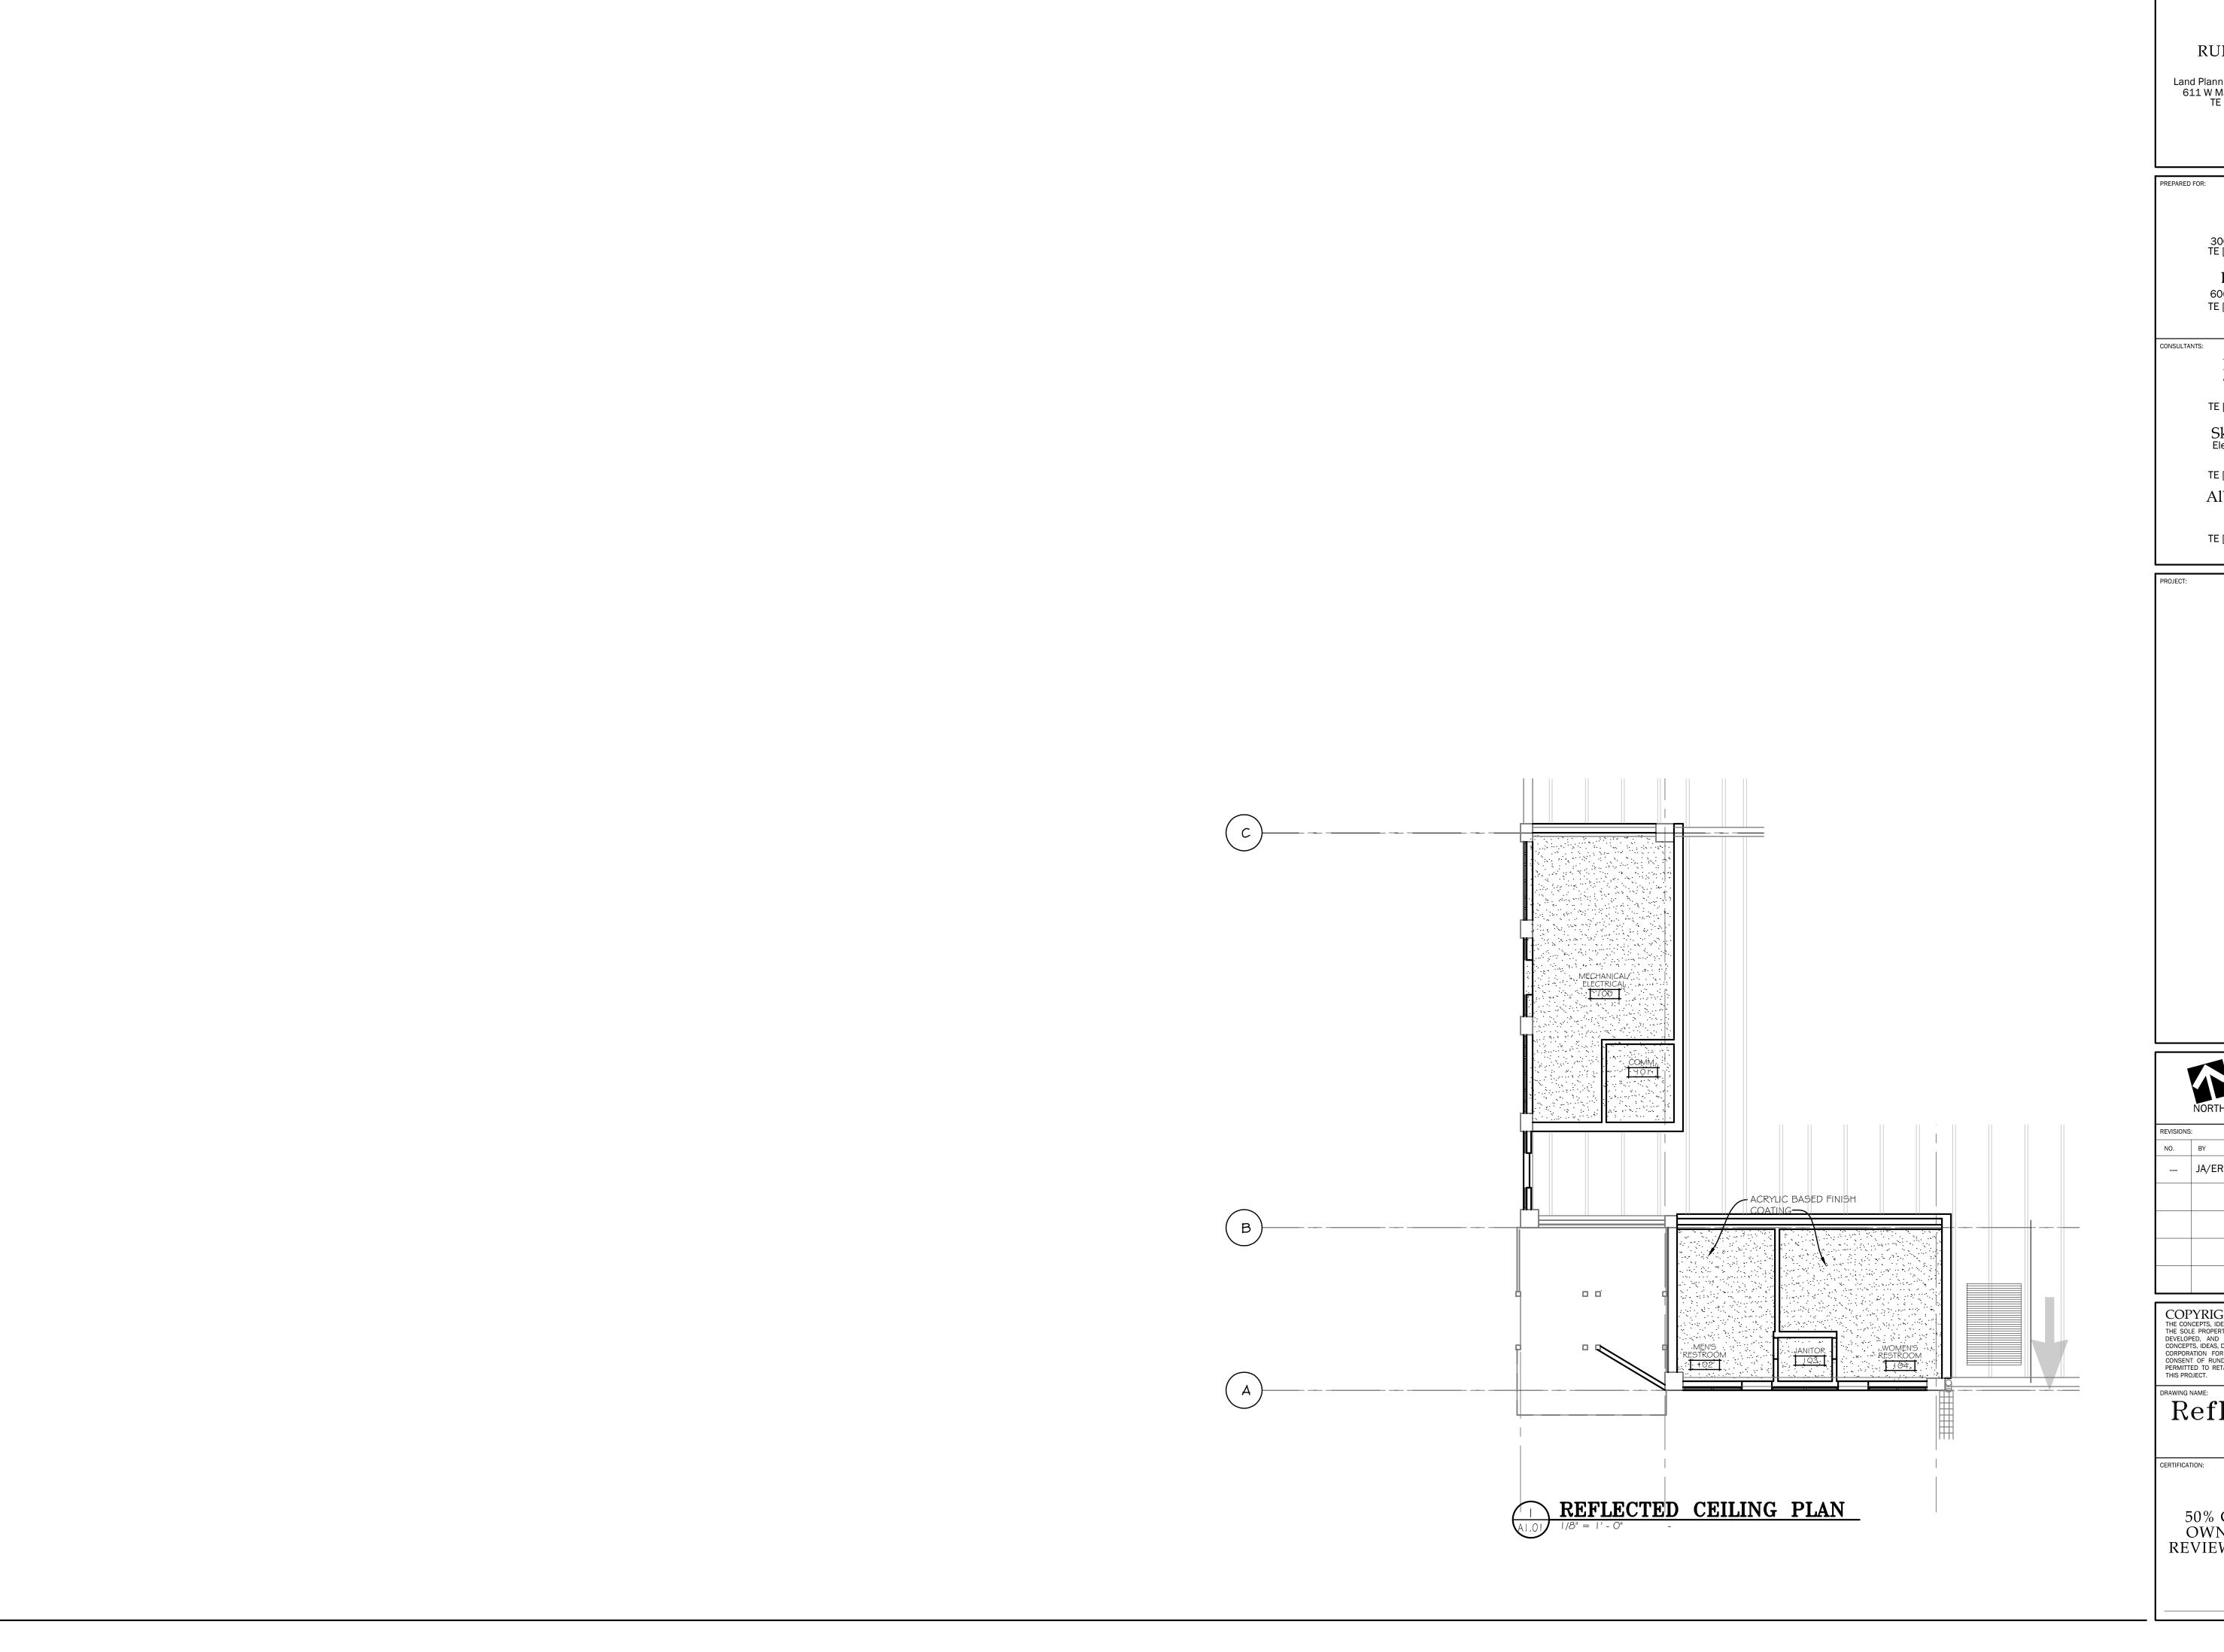
DRAWING NAME

Floor Plan

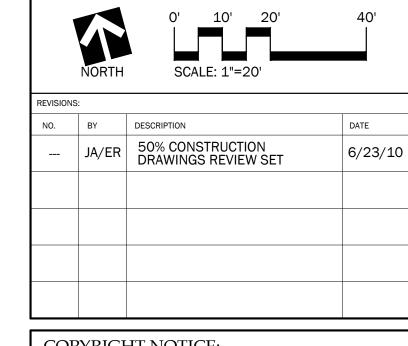CERTIFICATIO

Project No.: 091131
Date: June 23, 2010
Drawn by: PMA
Checked by: DDR
File: 1592\_A1.00.dwg

A1.00





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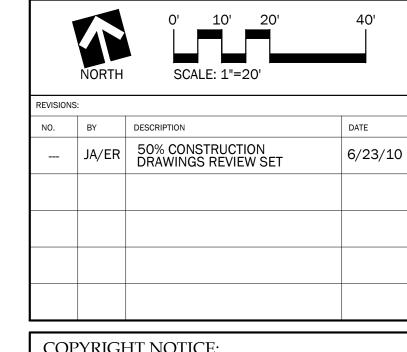
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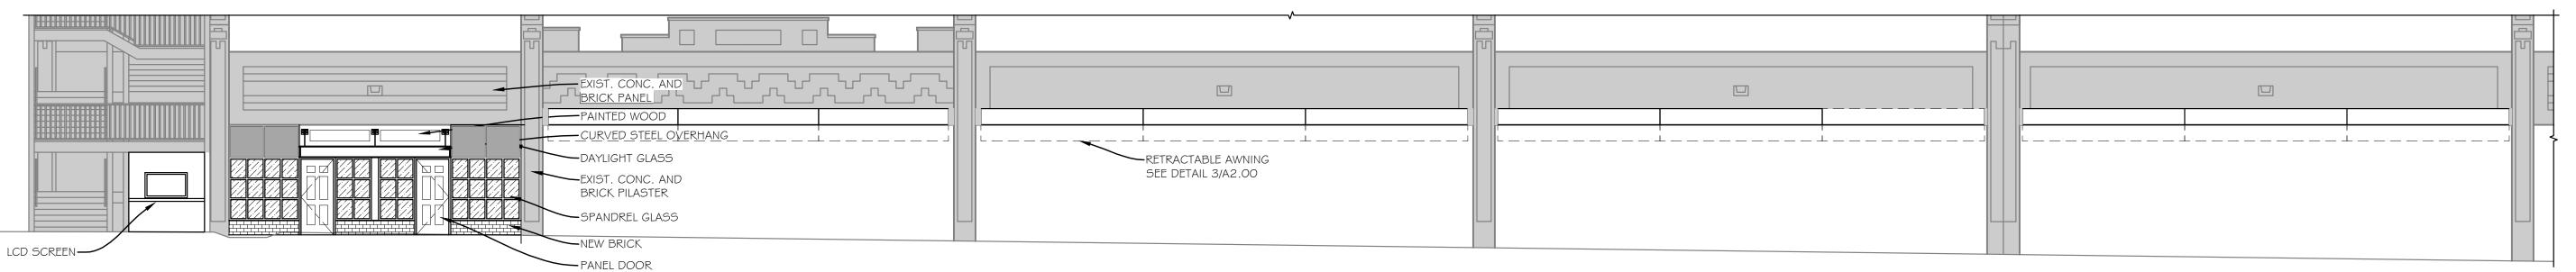


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Reflected Ceiling Plan

50% CDs OWNER REVIEW SET


Project No.: 091131 Date: June 23, 2010 Drawn by: PMA Checked by: DDR File: 1592\_A1.01.dwg DRAWING #:



PROPOSED RESTROOM EXTERIOR ELEVATION



PROPOSED MECHANICAL ROOM EXTERIOR ELEVATION

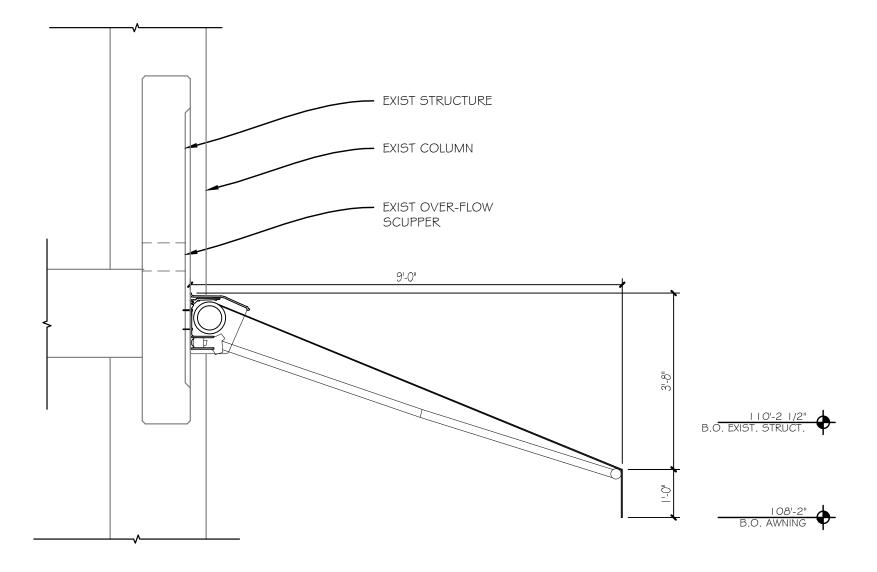

3 **AWNING DETAIL**A2.00 1/2" = 1'-0"



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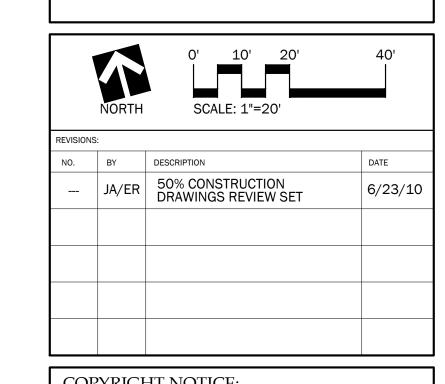
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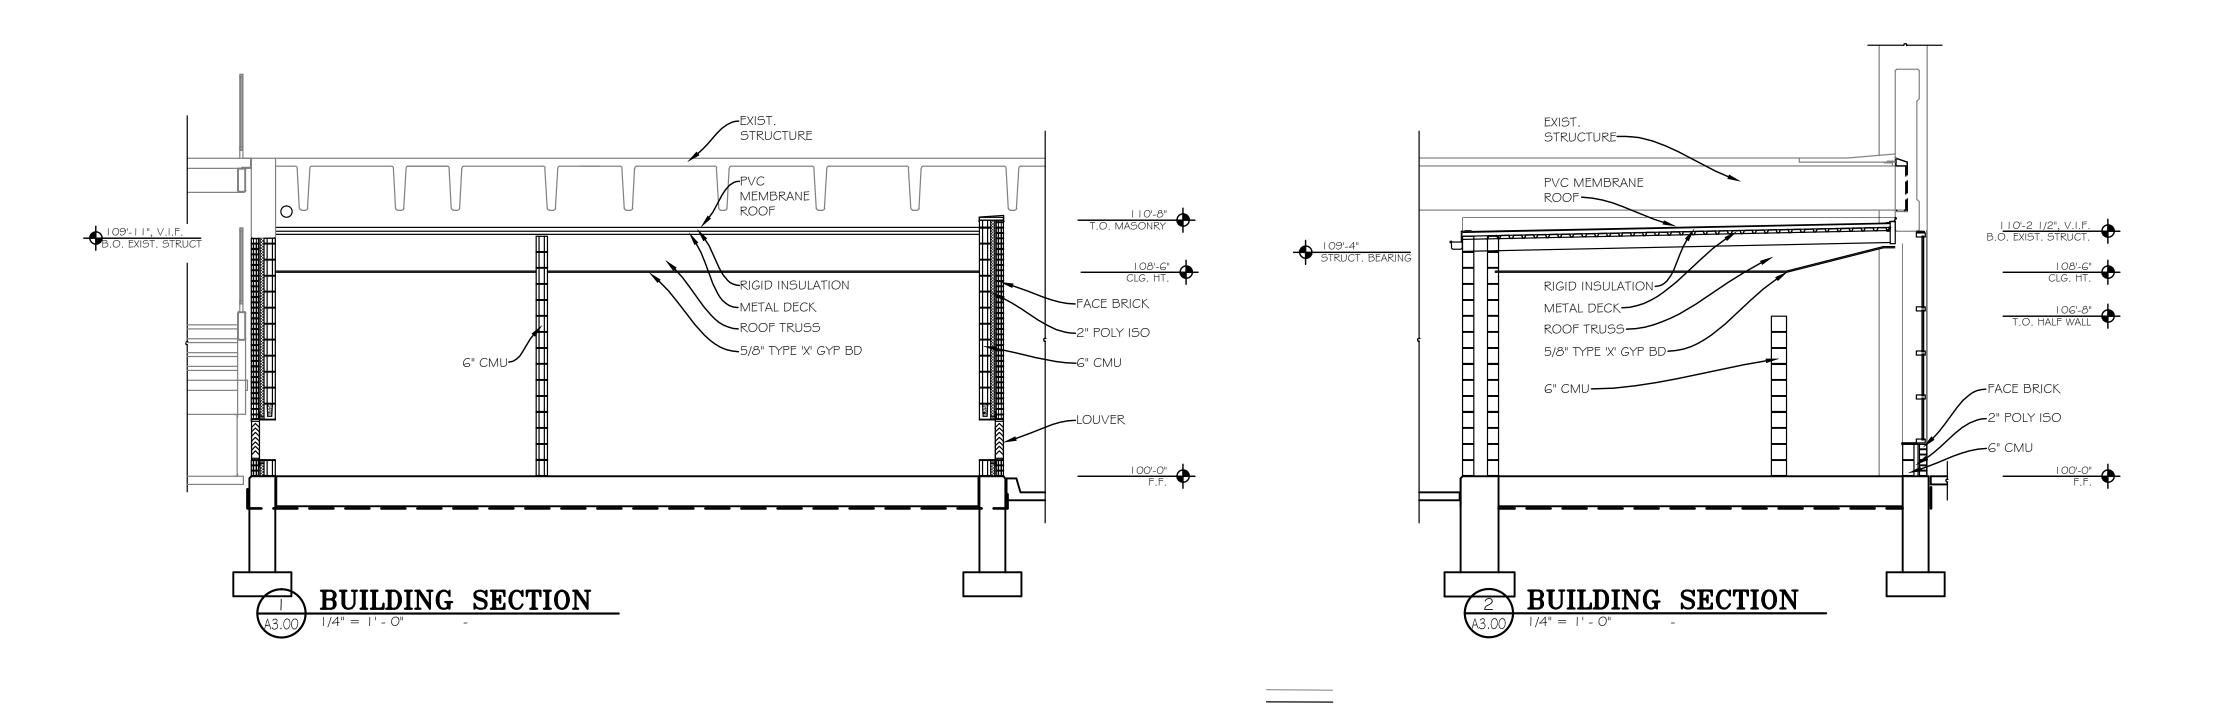



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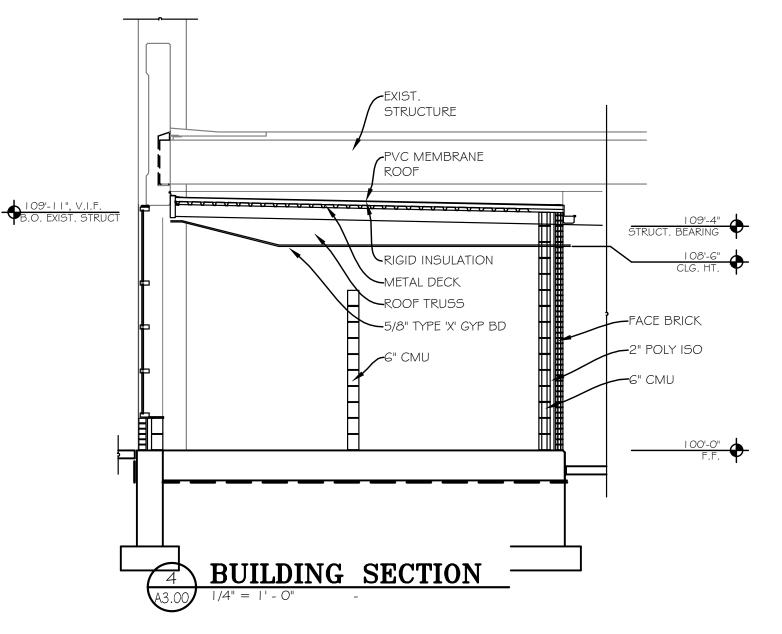
DRAWING NAME:

Exterior Elevations

50% CDs OWNER REVIEW SET Project No.: 091131
Date: June 23, 2010
Drawn by: PMA
Checked by: DDR
File: 1592\_A2.00.dwg





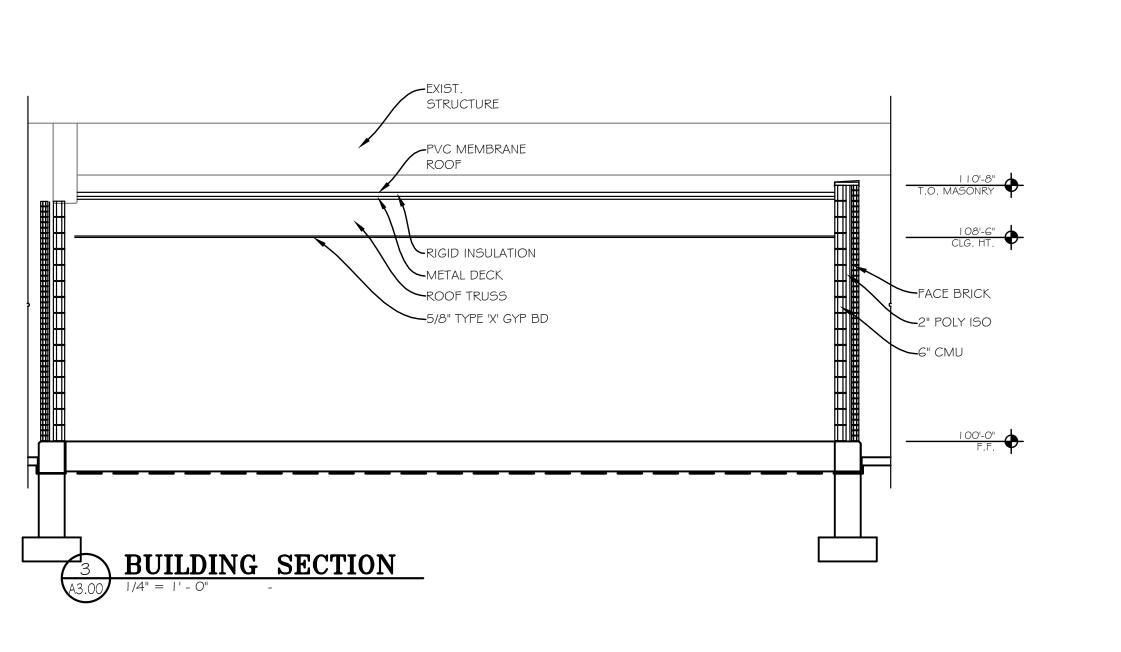



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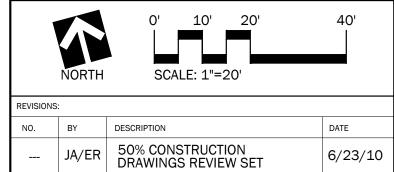
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Site Development Rapid City, South Dakota Main Street Square




| NO  | DV    | DECODIDATION                            | DATE  |
|-----|-------|---|-------|
| NO. | BY    | DESCRIPTION                             | DATE  |
|     | JA/ER | 50% CONSTRUCTION<br>DRAWINGS REVIEW SET | 6/23/ |
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Building Sections

CERTIFICATION: Project No.: 091131 50% CDs

June 23, 2010 Drawn by: PMA Checked by: DDR OWNER REVIEW SET File: 1592\_A3.00.dwg



INTERIOR ELEVATIONS

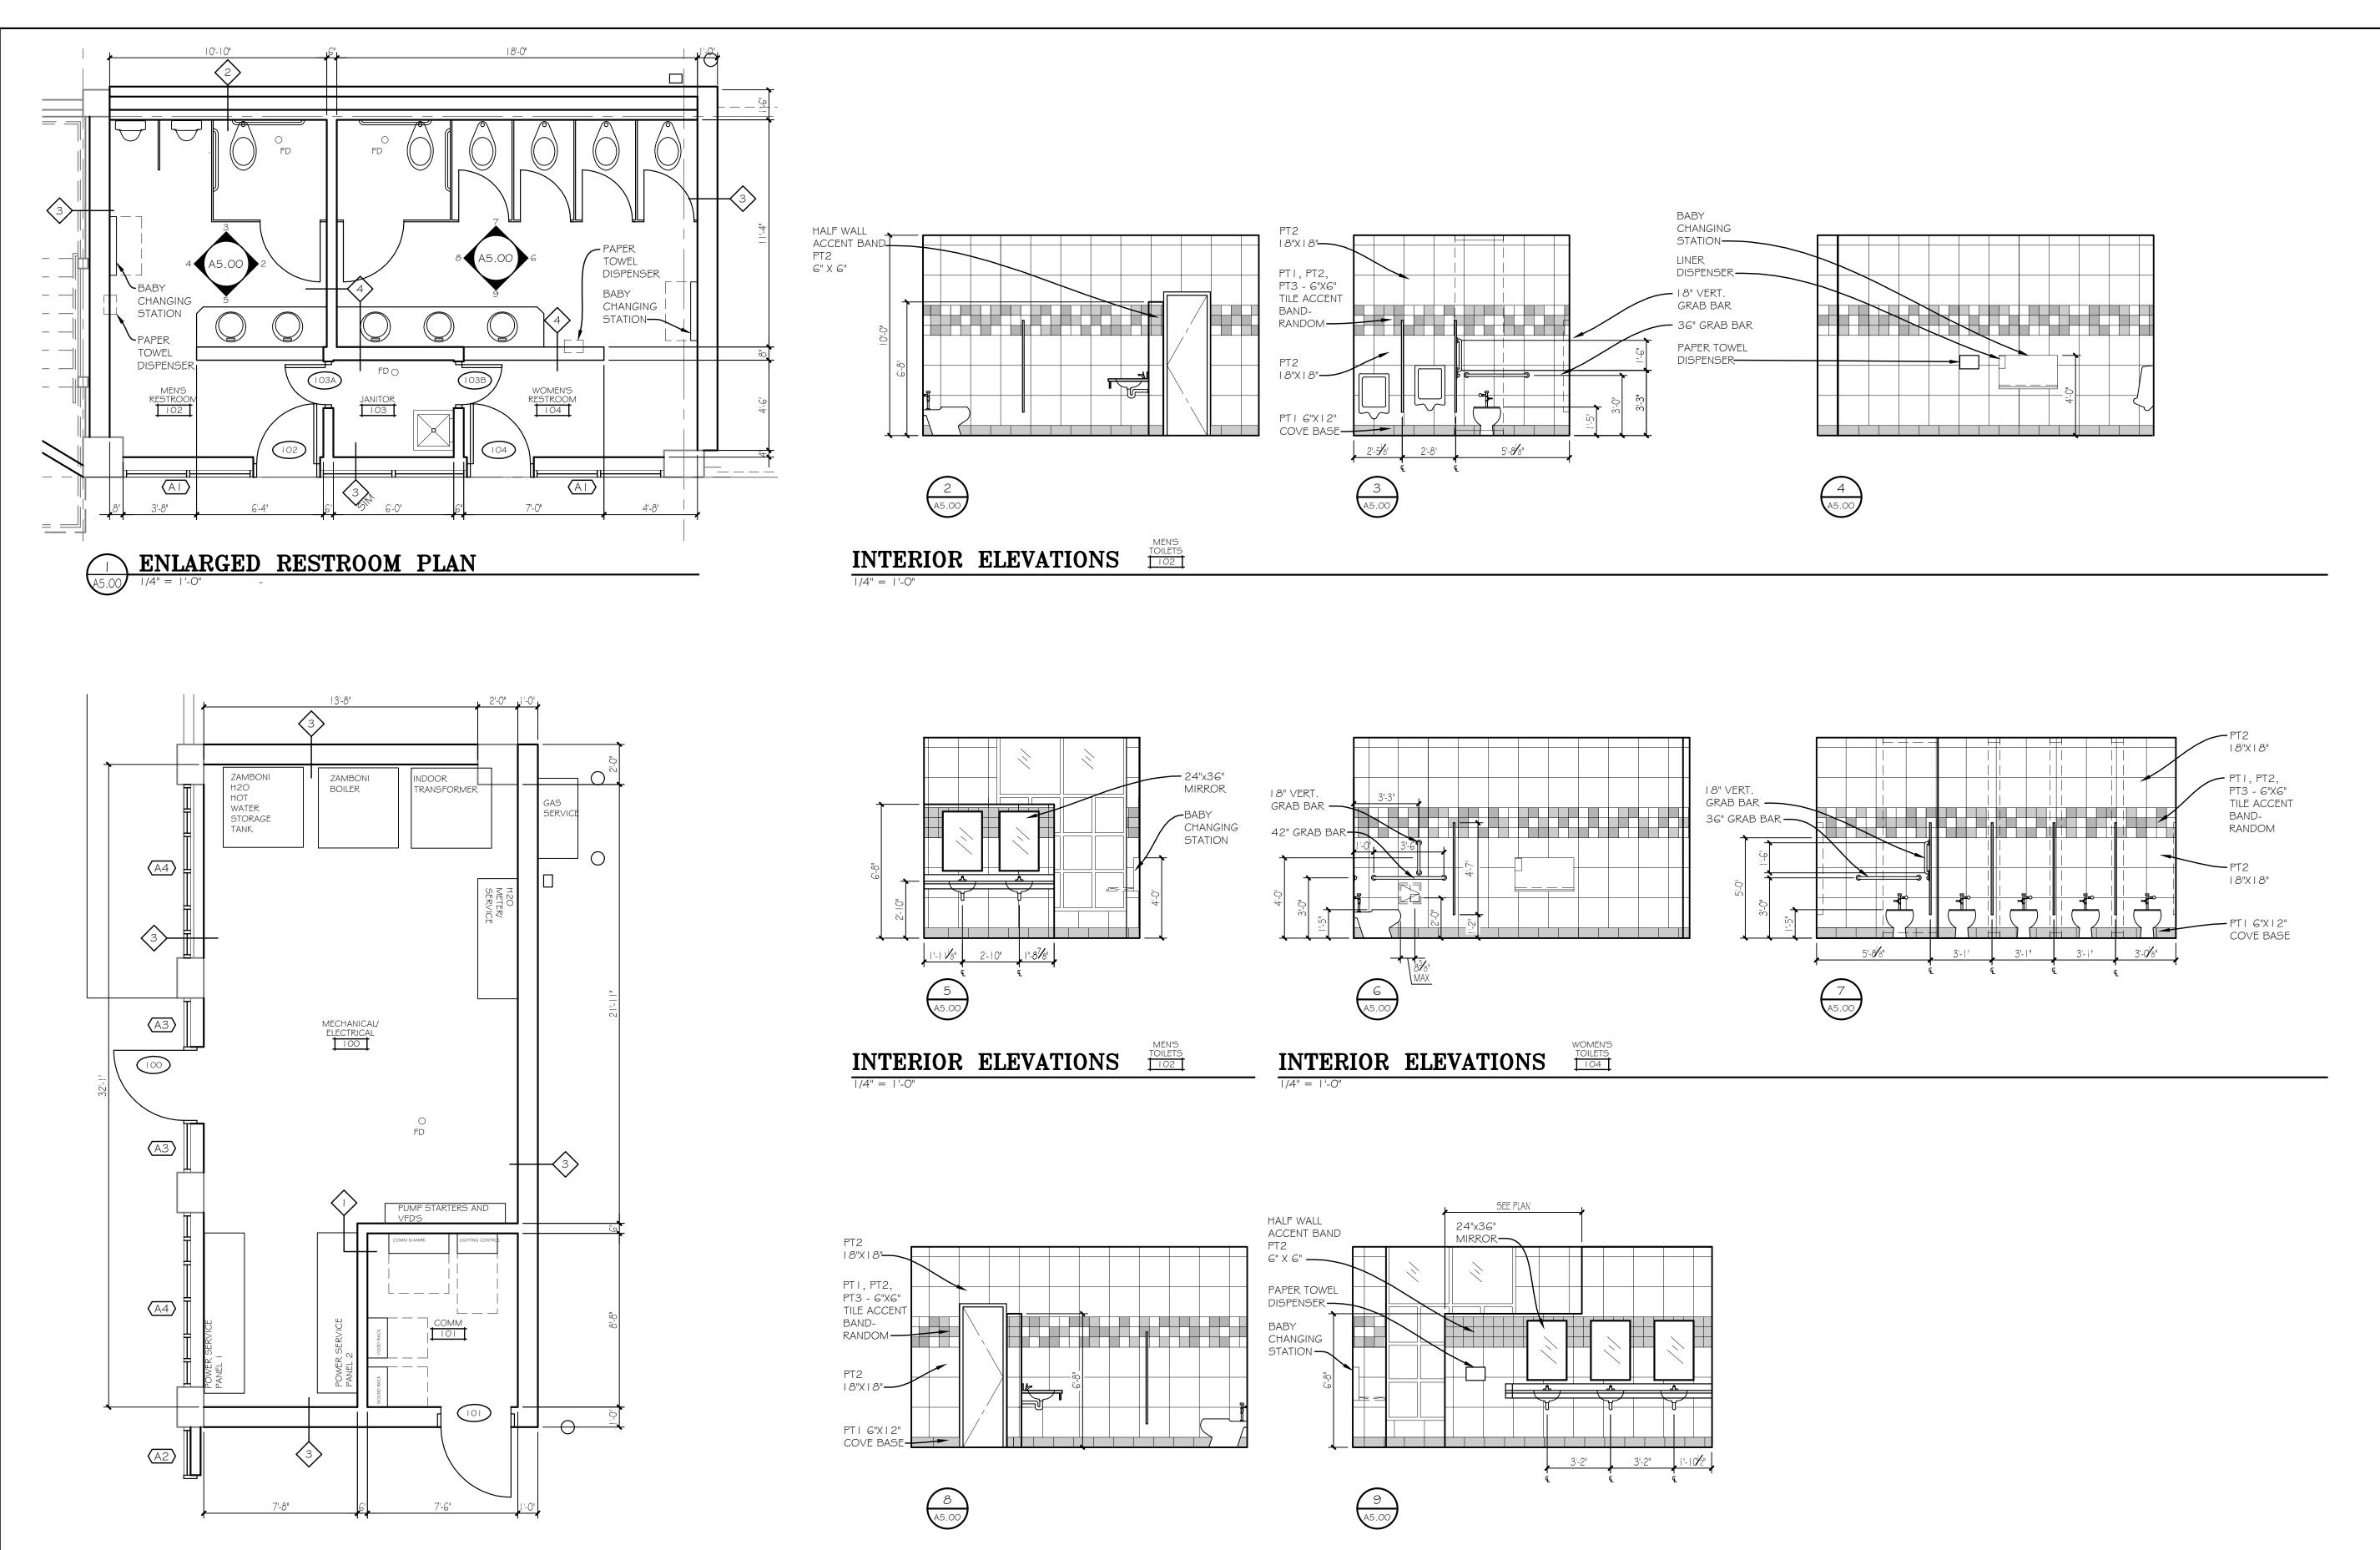ENLARGED MECHANICAL PLAN



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CONSULTANTS:


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CT:

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AWING NAME:

Interior Elevations

50% CDs OWNER REVIEW SET Project No.: 091131

Date: June 23, 2010

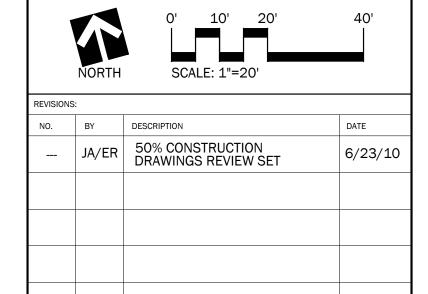Drawn by: PMA

Checked by: DDR

File: 1592\_A5.00.dwg

A5.00

| A OR AMP               | AMPERE ALTERNATING CURRENT                    | INTEGRAL       | INTEGRAL DEVICE TO EQUIPMENT JUNCTION BOX               | SYMBOL                             | DESIGNATION   | M             |
|------------------------|---|----------------|---|------------------------------------|---|---------------|
| ADD                    | or ABOVE COUNTER  ADDENDUM                    | KV             | KILOVOLT  |                                    | GENERAL   |               |
| ADJS                   | ADJUSTABLE                                    | KVA            | KILOVOLT-AMPERE   |                                    | INDICATES ALL DEVICES GANGED UNDER ONE COVERPLATE   | T             |
| AFC<br>AFF             | AVAILABLE FAULT CURRENT  ABOVE FINISHED FLOOR | KW<br>KWH      | KILOWATT HOUR   | F                                  | INDICATES EXISTING ITEM TO BE REMOVED   | +             |
| AFI                    | ARC FAULT INTERRUPTER                         | LCL            | LOCAL   | <b></b>                            | INDICATES EXISTING ITEM TO REMAIN   | +             |
| AHU                    | AIR HANDLING UNIT                             | LS             | LIFE SAFETY BRANCH/EMERG. POWER                         |                                    |   | +             |
| ALT                    | ALUMINUM                                      | LT<br>MAX      | LIGHT MAXIMUM   |                                    | INDICATES NEW ITEM  |               |
| APPROX                 | ALTERNATE  APPROXIMATELY                      | MC             | MECHANICAL CONTRACTOR DIV. 15                           |                                    |   |               |
| AQUA                   | AQUASTAT                                      | MCA            | MINIMUM CIRCUIT AMPACITY                                |                                    | NOTES   |               |
| ARCH                   | AS REQUIRED                                   | MCC            | MOTOR CONTROL CENTER                                    |                                    | MBOLS COMPRISE A STANDARD LIST, NOT ALL SYMBOLS MAY   |               |
| ATS                    | ARCHITECT  AUTOMATIC TRANSFER SWITCH          | MDP            | MAIN DISTRIBUTION PANEL                                 |                                    | ON THESE DRAWINGS.<br>3 HEIGHTS GIVEN ARE STANDARD. WHERE DIMENSIONAL NUMBER IS                         | :             |
| AUX                    | AUX CONTACTS                                  | MFR<br>MH      | MANUFACTURER  METAL HALIDE                              | SHOWN A                            | IT DEVICE, THIS SHALL BE THE MOUNTING HEIGHT. MOUNTING HEIG<br>CENTER OF OUTLET UNLESS NOTED OTHERWISE. |               |
| AUTO                   | AUTOMATIC                                     | MIN            | MINIMUM   |                                    | HEIGHTS INDICATED ARE FOR STUD WALL CONSTRUCTION, WHEN  |               |
| BFG<br>C               | BELOW FINISHED GRADE  CONDUIT                 | MLO            | MAIN LUGS ONLY  |                                    | R BRICK CONSTRUCTION IS USED, ADJUST MOUNTING HEIGHTS TO VICES OR DEVICE PLATES WITH RUNNING JOINT.     |               |
| CAB                    | CABINET                                       | MMS            | MANUAL MOTOR STARTER WITH OVERLOAD                      |                                    |   |               |
| СВ                     | CIRCUIT BREAKER                               | MOCP           | MAXIMUM OVERCURRENT PROTECTION                          |                                    |   |               |
| CCTV                   | CIRCUIT  CLOSED CIRCUIT TV                    | MAG<br>MRT     | MAGNETIC STARTER W/OUT DISC.  MOTOR RATED TOGGLE SWITCH | SYMBOL                             | DESIGNATION   | M             |
| CLG                    | CEILING                                       | MTD            | MOUNTED MOUNTED   | - THIDOL                           |   |               |
| CM                     | COMBINATION STARTER                           | MTR            | MOTOR   | <u> </u>                           | LIGHTING SYSTEM  TYPICAL FIXTURE DESIGNATION  | $\overline{}$ |
| COND                   | CONTROL CONDUCTOR                             | N              | NORMAL POWER BRANCH                                     | . O A ~                            | LIGHT FIXTURE TYPE  |               |
| CONN                   | CONNECT (ION)                                 | NEC<br>NF      | NATIONAL ELECTRICAL CODE  NOT FUSED                     | b •                                | SWITCHING   |               |
| CONTR                  | CONTRACTOR                                    | NIC            | NOT IN CONTRACT   |                                    | FLUORESCENT FIXTURE   | $\dagger$     |
| CT<br>CU               | CURRENT TRANSFORMER  COPPER                   | NL "           | NIGHT LIGHT   |                                    |   | +             |
| CUH                    | CABINET UNIT HEATER                           | NO or #<br>NTS | NUMBER  NOT TO SCALE                                    |                                    | EMERGENCY FLUORESCENT FIXTURE   | +             |
| D                      | DIMMER  | OC             | ON CENTER   |                                    | SURFACE FLUORESCENT, WALL MOUNTED   | V             |
| DC<br>DIA              | DIRECT CURRENT DIAMETER                       | OD             | OUTSIDE DIAMETER  | <del></del>                        | SURFACE STRIP FLUORESCENT FIXTURE   | +             |
| DN                     | DOWN  | 0E<br>P        | OWNER FURNISHED EQUIPMENT POLE                          | 0                                  | CEILING FIXTURE   |               |
| DPDT                   | DOUBLE POLE DOUBLE THROW                      | РВ             | PUSHBUTTON  | <○                                 | CEILING FIXTURE (WALL WASH TYPE) ARROW INDICATES AIMING DIRECTION                                       |               |
| DS<br>DWG              | DISCONNECT SWITCH DRAWING                     | PC             | PHOTOELECTRIC CELL                                      | Ю                                  | WALL FIXTURE  | V             |
| E E                    | EQUIP. BRANCH OF EMERGENCY PWR                | PE<br>PF       | PNEUMATIC ELECTRIC  POWER FACTOR                        | Ø                                  | CEILING FIXTURE (EMERGENCY)   | +             |
| EA                     | EACH  | PH             | PHASE   | ***                                | TRACK LIGHTING (CIRCLES INDICATE NUMBER OF HEADS)   | $^{\dagger}$  |
| EC EF                  | ELECTRICAL CONTRACTOR DIV. 16  EXHAUST FAN    | PIV            | POST INDICATING VALVE                                   | Ģ□                                 | POLE MOUNTED LIGHT FIXTURES (QUANTITY OF HEADS AS INDICATED)  |               |
| EH                     | ELECTRIC HEAT                                 | PL<br>PLBG     | PILOT LIGHT PLUMBING                                    | <b>↑⊗</b> I                        | SINGLE FACE EXIT SIGN (WALL MOUNTED) WITH ARROW AS INDICATED, SHADED QUADRANT DENOTES FACE DIRECTION    |               |
| EHC                    | ELECTRIC HEATING COIL                         | PNL            | PANEL   | ↑ • ↑                              | DOUBLE FACE EXIT SIGN (CEILING MOUNTED) WITH ARROW  |               |
| ELEC                   | ELEVATION ELECTRIC (AL)                       | PWR            | POWER   | P9                                 | AS INDICATED, SHADED QUADRANT DENOTES FACE DIRECTION  BATTERY POWERED EMERGENCY LIGHTING UNIT.          | 1             |
| ELEV                   | ELEVATOR                                      | RECEPT         | RECESSED  RECEPTACLE                                    | \$                                 | SINGLE POLE SWITCH  |               |
| EM                     | EMERGENCY                                     | REQD           | REQUIRED  | <u>\$</u> 2                        | DOUBLE POLE SWITCH  |               |
| ENCL ENCL              | ELECTRICAL METALLIC TUBING ENCLOSURE          | RLA            | RUNNING LOAD AMPS                                       | \$ <sup>3</sup><br>\$ <sup>4</sup> | THREE WAY SWITCH FOUR WAY SWITCH  |               |
| EP                     | ELECTRIC PNEUMATIC                            | RM<br>RMT      | ROOM<br>REMOTE  | <u> </u>                           | SWITCH, "a" INDICATES SWITCH DESIGNATION  |               |
| EP0                    | EMERGENCY POWER OFF                           | RPM            | REVOLUTIONS PER MINUTE                                  | <b>§</b> P                         | SWITCH WITH PILOT LIGHT   |               |
| EWC EWC                | EQUIPMENT  ELECTRIC WATER COOLER              | RTU<br>SC      | ROOFTOP UNIT SELF CONTAINED                             | \$ IL<br>\$ K                      | SWITCH WITH ILLUMINATED TOGGLE  |               |
| EX                     | EXISTING                                      | SHT            | SHEET   | <u> </u>                           | KEY SWITCH  MOMENTARY CONTACT SWITCH  |               |
| EXH                    | EXHAUST                                       | SM             | SURFACE MOUNT   | <u>\$</u> TS                       | TIMER SWITCH  |               |
| F<br>F <b>@</b> #      | FUSE  | SP<br>SPEC     | SURGE PROTECTION SPECIFICATIONS                         | <u>\$</u> D<br>- HTC               | DIMMER SWITCH, WATTAGE AS NOTED   | V             |
| <u>г⊌#</u><br>FA       | FIRE ALARM                                    | SPKR           | SPEAKER   | \$ PC                              | TIME CLOCK PHOTO ELECTRIC CELL  | V             |
| FAA                    | FIRE ALARM ANNUNCIATOR                        | SPDT<br>SPST   | SINGLE POLE DOUBLE THROW  SINGLE POLE SINGLE THROW      |                                    |   |               |
| FACP<br>FBO            | FIRE ALARM CONTROL PANEL  FURNISHED BY OTHERS | SQ             | SQUARE  | _                                  |   |               |
| FC                     | FOOTCANDLE                                    | SS             | STAINLESS STEEL   |                                    |   |               |
| FD                     | FIRE DAMPER                                   | STD            | STANDARD  | _                                  |   |               |
| FDS<br>FIN             | FUSED DISCONNECT SWITCH FINISHED              | SUSP           | SUSPENDED<br>SWITCH                                     | 1                                  |   |               |
| FIN<br>FL              | FLOOR   | SWBD           | SWITCHBOARD   | ]                                  |   |               |
| FLA                    | FULL LOAD AMPS                                | SYS            | SYSTEM  TEMPERATURE CONTROL CONTRACTOR                  | -                                  |   |               |
| FLUOR<br>FSD           | FLUORESCENT                                   | TC<br>TEL      | TEMPERATURE CONTROL CONTRACTOR TELEPHONE                | -                                  |   |               |
| FT or '                | FIRE/SMOKE DAMPER FOOT or FEET                | TEMP           | TEMPERATURE   | ]                                  |   |               |
| GC                     | GENERAL CONTRACTOR                            | TMB            | TELEPHONE MOUNTINGBOND                                  | -                                  |   |               |
| GEN                    | GENERATOR                                     | T-STAT<br>TV   | THERMOSTAT TELEVISION                                   | 1                                  |   |               |
| GFI<br>GND             | GROUND FAULT INTERRUPTER  GROUND              | TYP            | TYPICAL   | ]                                  |   |               |
| GRC                    | GALVANIZED RIGID CONDUIT                      | UG             | UNDERGROUND   | 1                                  |   |               |
| H                      | HEATING EQUIPMENT                             | UL<br>UH       | UNDERWRITERS LABORATORY  UNIT HEATER                    | 1                                  |   |               |
| HD<br>HID              | HEAVY DUTY HIGH INTENSITY DISCHARGE           | UT             | UNDERGROUND TEL/TV                                      | ]                                  |   |               |
|                        |   | V              | VOLT  |                                    |   |               |
| НОА                    | HAND-OFF AUTO SWITCH                          |                |   |                                    |   |               |
| HP                     | HORSEPOWER                                    | VC             | VENTILATION CONTRACTOR                                  |                                    |   |               |
| HOA<br>HP<br>HPS<br>HT |   |                |   |                                    |   |               |

WEIGHT

WEATHERPROOF

TRANSFORMER

POSITION SWITCH

WP

XFMR

ZS

HTR

ID

INCAND

IN or "

HEATER

HERTZ

INCH

INTEGRAL DISCONNECT

INCANDESCENT

| SYMBOL  | DESIGNATION   | MTG.<br>HT. |
|---|---|-------------|
|   | POWER SYSTEMS   |             |
|   | BRANCH CIRCUIT PANEL  |             |
|   | EMERGENCY PANEL   |             |
|   | DISTRIBUTION PANEL OR SWITCHBOARD   |             |
|   | EQUIPMENT CABINET   |             |
| Т   | TRANSFORMER   |             |
| $\bigcirc$  | MOTOR   |             |
| $\left\langle \begin{array}{c} AC \\ 2 \end{array} \right\rangle$ | INDICATES EQUIPMENT SCHEDULE IDENTIFICATION NUMBER (SEE EQUIPMENT SCHEDULE) |             |
| $\boxtimes$   | CONTROLLER OR STARTER   |             |
| ⊠'  | COMBINATION STARTER & DISCONNECT  |             |
| 다   | DISCONNECT OR SAFETY SWITCH   |             |
| <b>\$</b> <sup>M</sup>  | MOTOR RATED TOGGLE SWITCH   | 48"         |
| \$ MMS  | MANUAL MOTOR STARTER, WITH OVERLOAD PROTECTION                              | 48"         |
| HOO   | CONTROL STATION   | 48"         |
| R   | RELAY   |             |
| С   | CONTACTOR   |             |
| Ю   | ELECTRIC THERMOSTAT   | 48"         |
| P   | POWER POLE  |             |
| $\ominus$   | SINGLE RECEPTACLE   | 18"         |
| → <sub>C</sub>  | CLOCK RECEPTACLE  | 80"         |
| <del></del>   | DUPLEX RECEPTACLE   | 18"         |
| <del></del>   | CEILING MOUNTED RECEPTACLE  |             |
| <b>=</b>  | DUPLEX RECEPTACLE ON EMERGENCY CIRCUIT                                      | 18"         |
| <del></del>   | SPLIT WIRED DUPLEX RECEPTACLE   | 18"         |
| #   | DOUBLE DUPLEX RECEPTACLE  | 18"         |
| <b>#</b>  | DOUBLE DUPLEX RECEPTACLE ON EMERGENCY CIRCUIT                               | 18"         |
| H <b>●</b> <sup>A</sup>   | SPECIAL PURPOSE OUTLET OR CONNECTION —<br>LETTER DENOTES TYPE               | 18"         |
| ® <sub>⊙</sub> ₄  | FLOOR OUTLET (DEVICES AS INDICATED)   |             |
|   | MULTIOUTLET ASSEMBLY, AS SPECIFIED  | AS<br>NOTED |
| ♠ HD  | HAND DRYER  |             |

ELECTRICAL LEGEND

| SYMBOL            | DESIGNATION  | MTG.<br>HT. |  |  |  |  |
|-------------------|--|-------------|--|--|--|--|
| RACEWAY SYSTEM    |  |             |  |  |  |  |
|                   | CONDUIT CONCEALED IN CEILING OR WALLS  |             |  |  |  |  |
| /                 | CONDUIT CONCEALED IN FLOOR OR BELOW  |             |  |  |  |  |
|                   | EXPOSED CONDUIT  |             |  |  |  |  |
| UG- <u>-</u> -    | UNDERGROUND ELECTRIC — 30" INDICATES BURIAL DEPTH  |             |  |  |  |  |
| <b>→</b> B C      | CONDUIT INSTALLED INTO CEILING SPACE WITH BUSHED END (B) OR CAPPED END (C)   |             |  |  |  |  |
| <u> </u>          | ELEVATION CHANGE IN CONDUIT UP   |             |  |  |  |  |
|                   | ELEVATION CHANGE IN CONDUIT DOWN   |             |  |  |  |  |
| 155               | MATCH MARK FOR CONDUIT CONTINUATION  |             |  |  |  |  |
| L1-1,3            | CIRCUIT HOME RUN, L1 INDICATES PANEL,<br>1,3 INDICATES POLE NUMBER   |             |  |  |  |  |
| 0                 | "a" DESIGNATES LIGHTING SWITCH   |             |  |  |  |  |
| 1                 | UNLESS OTHERWISE INDICATED, EACH CROSS HASH DENOTES ONE # 12 CONDUCTOR. NO CROSS HASH DENOTES 3 # 12 CONDUCTORS. LONGER CROSS HASH INDICATES NEUTRAL CONDUCTOR. \( \) INDICATES GROUNDING CONDUCTOR. |             |  |  |  |  |
| PB                | PULL BOX   |             |  |  |  |  |
| 0                 | JUNCTION BOX   |             |  |  |  |  |
|                   | WIREWAY  |             |  |  |  |  |
|                   | CABLE TRAY   |             |  |  |  |  |
| UF P C            | UNDERFLOOR DUCT AND JUNCTION BOX, NUMBER OF CELLS DENOTED BY NUMBER OF SPACES BETWEEN LINES.  TYPE OF CELL DENOTED BY P (POWER), T (TELEPHONE), C (COMMUNICATIONS).                                  |             |  |  |  |  |
| B <sub>B</sub> X" | BACK BOX — INSTALL SINGLE GANG BACKBOX WITH 3/4" EMT CONDUIT UP TO ACCESSIBLE CEILING SPACE. PROVIDE BLANK COVER MATCHING DECOR X" = OVERSIZE IF NOTED   | 48"         |  |  |  |  |
| <b>①</b> -3       | JUNCTION BOX W/3/4" EMT TO ACCESSIBLE CEILING, PLASTIC BUSHING. PROVIDE BLANK COVER MATCHING ADJACENT DEVICES.   | 18"         |  |  |  |  |

| SYMBOL            | DESIGNATION                                       | MTG.<br>HT. |
|-------------------|---|-------------|
|                   | SIGNAL SYSTEMS                                    |             |
| H●                | PUSHBUTTON  | 48"         |
| Η□/               | BUZZER  | 80"         |
| HD0               | BELL  | 80"         |
| M                 | TELEPHONE OUTLET                                  | 18"         |
| ₩                 | TELEPHONE OUTLET - WALL MOUNTED                   | 48"         |
| Ħ                 | DATA OUTLET/DATA OUTLET                           | 18"         |
| K                 | DATA OUTLET                                       | 18"         |
| <b>4</b>          | TELEPHONE OUTLET/DATA OUTLET                      | 18"         |
| HS                | WALL SPEAKER                                      | 80"         |
| S                 | CEILING SPEAKER                                   |             |
| HSI⊄              | HORN TYPE SPEAKER                                 | 80"         |
| <u>©</u> <u>©</u> | COMBINATION CLOCK/SPEAKER                         | 80"         |
| <b>₩</b>          | MICROPHONE OUTLET                                 | 18"         |
| ₩                 | SPEAKER VOLUME CONTROL                            | 48"         |
| K IC              | INTERCOM STATION ( M: MASTER, R: REMOTE STATION ) | 48"         |
| HTV               | TV ANTENNA OUTLET                                 | VERIFY      |
| □ □ CCTV          | CLOSED CIRCUIT TV CAMERA                          | VERIFY      |
| ⊦© <sup>9"</sup>  | SYSTEM CLOCK - DIMENSION DENOTES CLOCK SIZE       | 80"         |
|                   | TERMINAL CABINET                                  |             |
|                   | ANNUNCIATOR PANEL                                 |             |

DESIGNATION

SYMBOL

MTG. HT.

|                       | FIRE ALARM SYSTEM   |             |
|-----------------------|---|-------------|
| F                     | FIRE ALARM MANUAL STATION   | 48"         |
| ΕH                    | FIRE ALARM HEAT DETECTOR — FIXED TEMPERATURE  | VERIF       |
| F RR                  | FIRE ALARM HEAT DETECTOR — RATE OF RISE   | VERIF       |
| FR                    | FIRE ALARM RELAY  | VERIF       |
| E 135°                | FIRE ALARM HEAT DETECTOR - 135' INDICATES TEMP RATING   | VERIF       |
| Εı                    | FIRE ALARM SMOKE DETECTOR — IONIZATION  | VERIF       |
| Εp                    | FIRE ALARM SMOKE DETECTOR — PHOTOELECTRIC   | VERIF       |
| E Ms                  | FIRE ALARM MULTI-STATION ALARM - PHOTOELECTRIC  |             |
| E SS                  | FIRE ALARM SINGLE STATION ALARM — PHOTOELECTRIC   |             |
| <del>m</del> F        | FIRE ALARM DUCT MOUNTED SMOKE DETECTOR  |             |
| 旧 <sub>RS</sub>       | FIRE ALARM STATION — REMOTE RESET/TEST STATION FOR DUCT DETECTOR  | 48"         |
| FRL                   | REMOTE INDICATOR LAMP   | VERIF       |
| F <sup>B-T</sup>      | FIRE ALARM BEAM DETECTOR TRANSMITTER  |             |
| F <sup>B-R</sup>      | FIRE ALARM BEAM DETECTOR RECEIVER   |             |
| E <sub>FS</sub>       | FIRE ALARM FLOW SWITCH MONITOR MODULE   |             |
| E <sub>TS</sub>       | FIRE ALARM TAMPER SWITCH MOITOR MODULE  |             |
| FMM                   | FIRE ALARM MONITOR MODULE   |             |
| FPS                   | FIRE ALARM PRESSURE SWITCH MONITOR MODULE   |             |
| FCM                   | FIRE ALARM CONTROL MODULE   |             |
| E SD                  | FIRE/SMOKE DAMPER   |             |
| HE DH                 | MAGNETIC DOOR HOLDER  | VERIF       |
| <b>⋈</b> <sub>F</sub> | FIRE ALARM FIREMAN'S STATION  | 48"         |
| HED 110               | FIRE ALARM STROBE — 110 INDICATES CANDELLA IN SLEEPING AREAS, TOP OF LENS NOT LESS THAN 24" BELOW CEILING   | 80"         |
| HEK                   | FIRE ALARM HORN TOP OF DEVICE NOT LESS THAN 90" AFF AND NOT LESS THAN 6" BELOW FINISHED CEILING. IN SLEEPING AREAS, TOP OF LENS NOT LESS THAN 24" BELOW CEILING | 80"         |
| H <b>F</b> □110       | FIRE ALARM HORN AND STROBE — 110 INDICATES CANDELLA IN SLEEPING AREAS, TOP OF LENS NOT LESS THAN 24" BELOW CEILING  | 80"         |
| FACP                  | FIRE ALARM CONTROL PANEL  |             |
|                       |   | <del></del> |

| SYMBOL            | DESIGNATION                    | MTG.<br>HT. |
|-------------------|--------------------------------|-------------|
|                   | SECURITY SYSTEM                |             |
| HSI <sub>CR</sub> | SECURITY CARD READER           | 48"         |
| HS KP             | SECURITY KEYPAD                | 48"         |
| HS KS             | SECURITY KEY SWITCH            | 48"         |
| S XS              | SECURITY EXIT SENSOR           |             |
| HSI EP            | SECURITY EXIT PUSHBUTTON       | 48"         |
| S <sub>ES</sub>   | SECURITY ELECTRIC STRIKE       |             |
| S ML              | SECURITY MAGNETIC LOCK         |             |
| S EL              | SECURITY ELECTRIC LOCK         |             |
| S <sub>TH</sub>   | SECURITY POWER TRANSFER HINGE  |             |
| S DC              | SECURITY DOOR CONTACT          |             |
| S ODC             | SECURITY OVERHEAD DOOR CONTACT |             |
| S <sub>MS</sub>   | SECURITY MONITOR STRIKE        |             |
| S <sub>MD</sub>   | SECURITY MOTION DETECTOR       |             |
| S GB              | SECURITY GLASS BREAK DETECTOR  |             |

SHEET INDEX

E0.00 ELECTRICAL LEGEND AND SHEET INDEX ED1.10 SITE DEMOLITION PLAN E1.10 SITE LIGHTING PLAN E1.20 SITE POWER PLAN

E1.30 SITE SIGNAL PLAN E2.10 ELECTRICAL FLOOR PLANS E2.20 ELECTRICAL SCHEDULES & RISERS

E2.30 ELECTRICAL DETAILS

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Dakota Square Site Development pid City, South Dak reet Main

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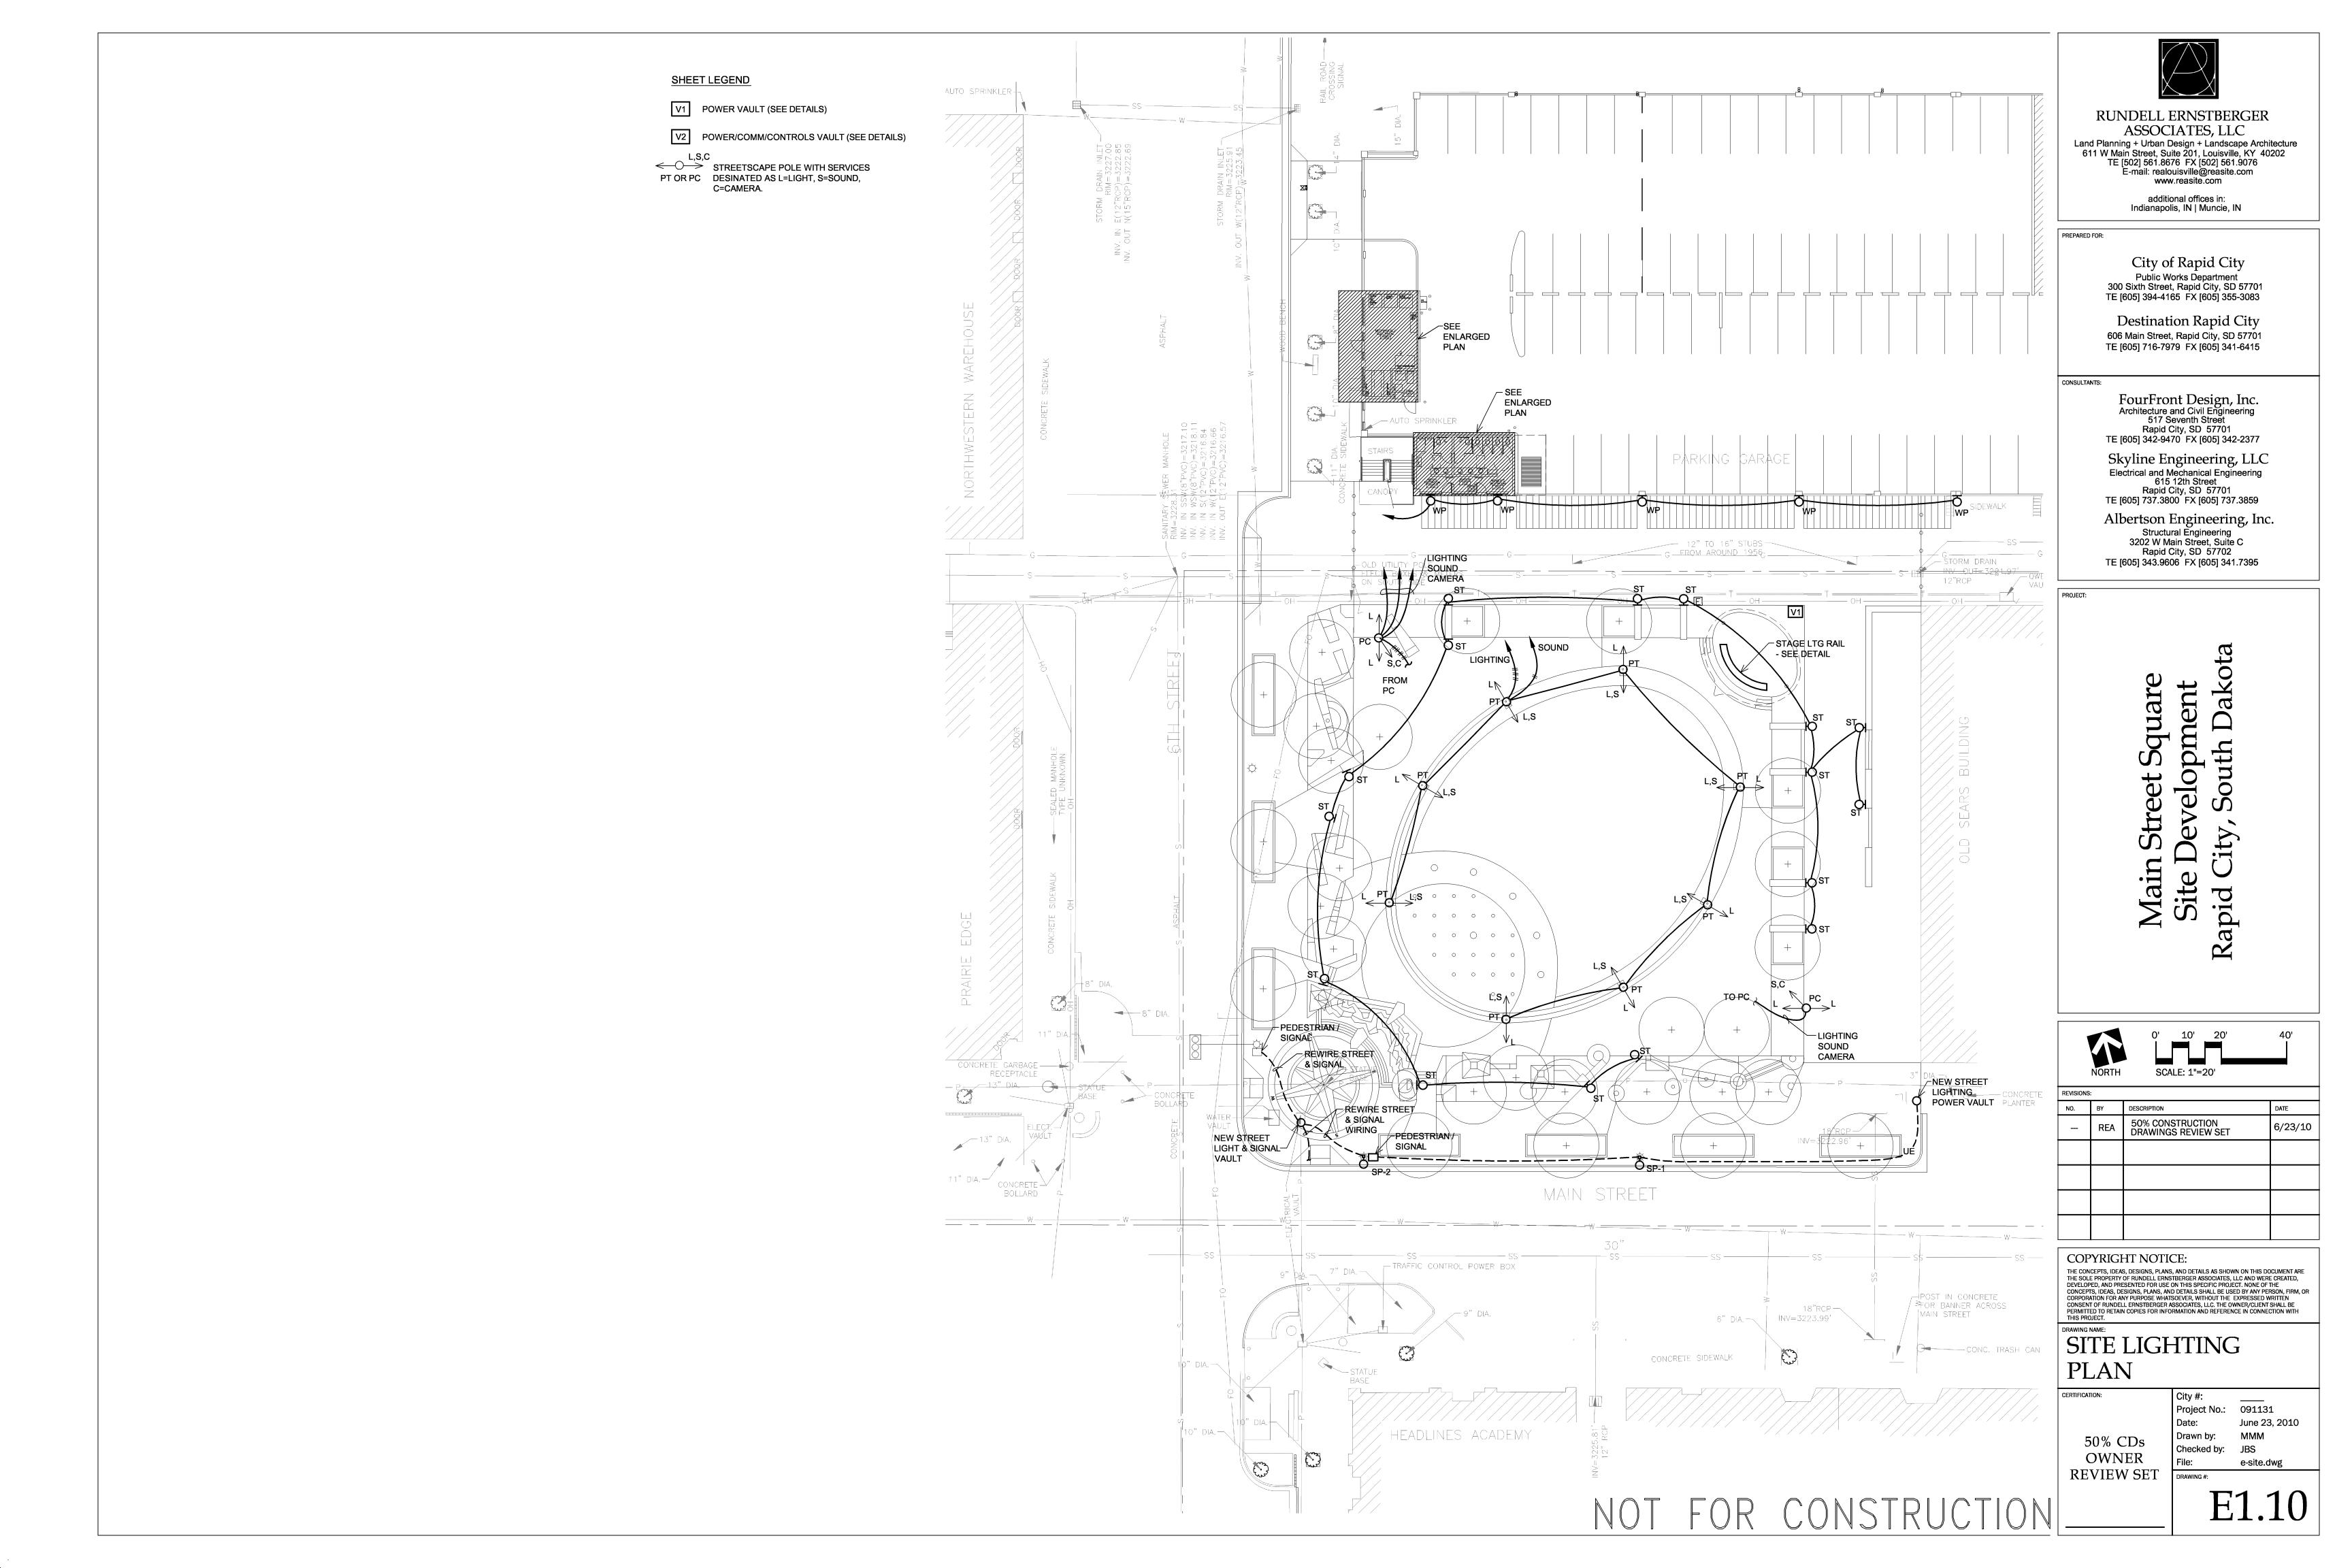
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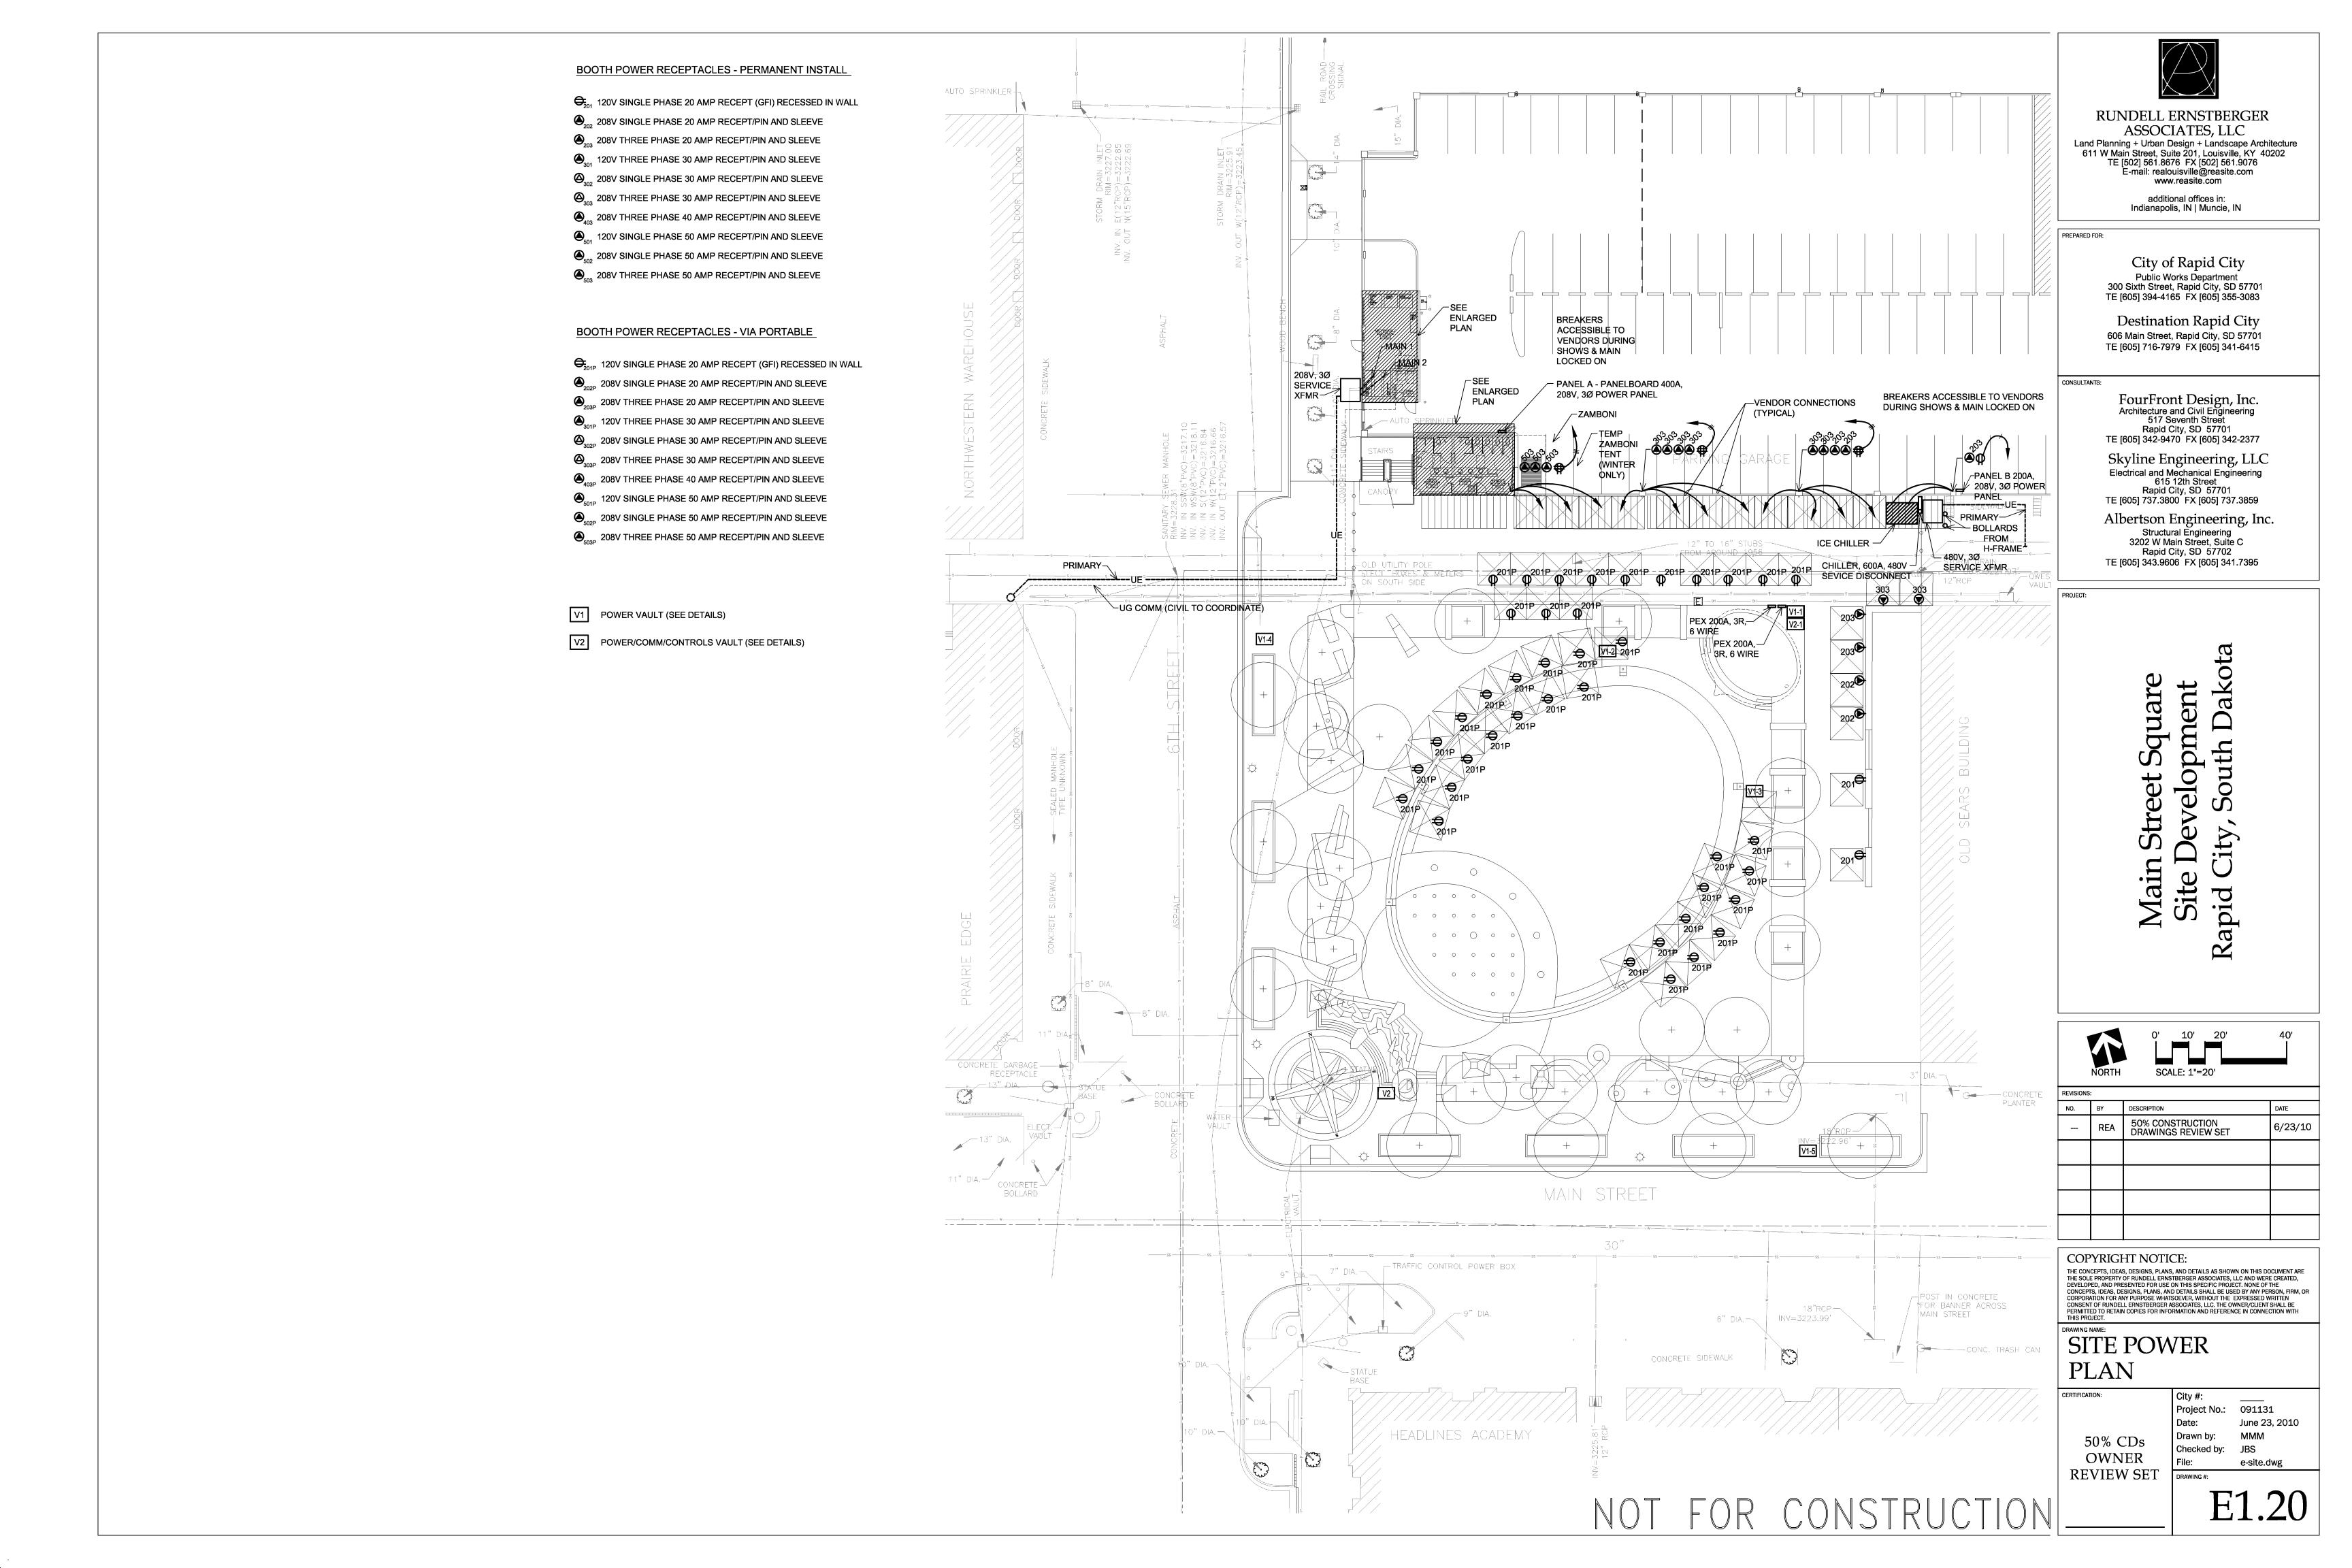
#### ELECTRICAL LEGEND SHEET INDEX


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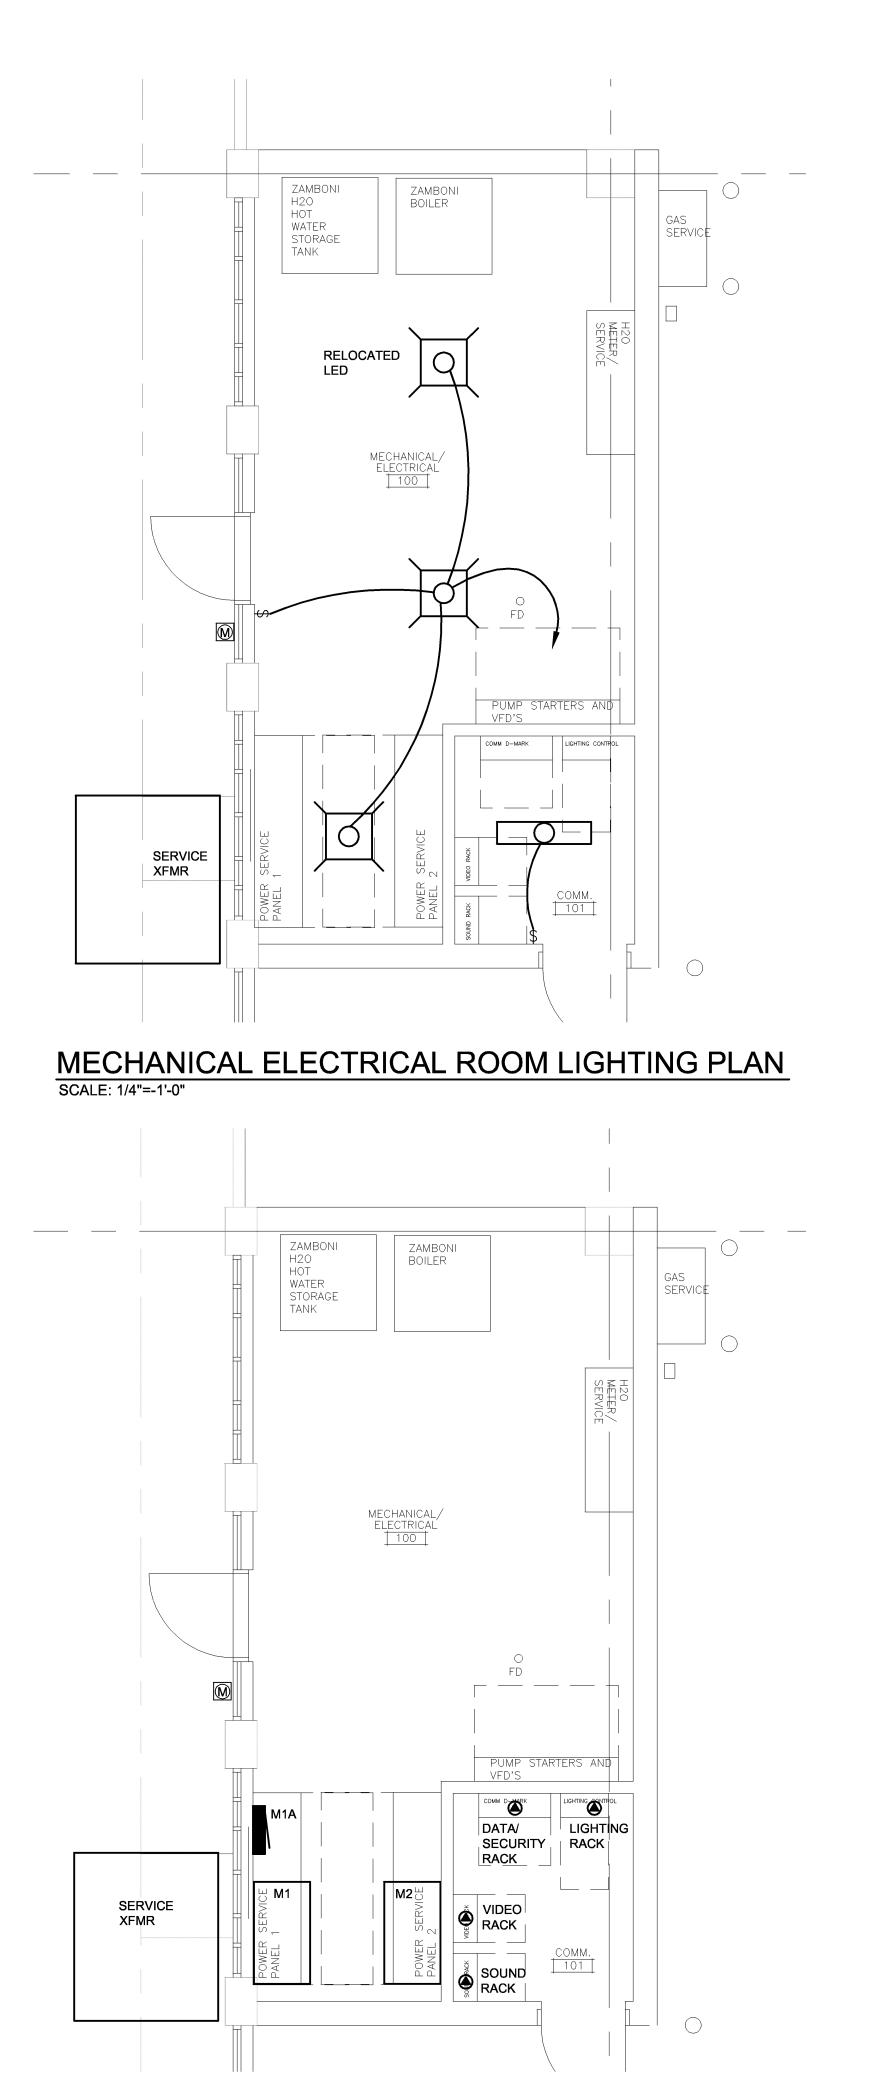
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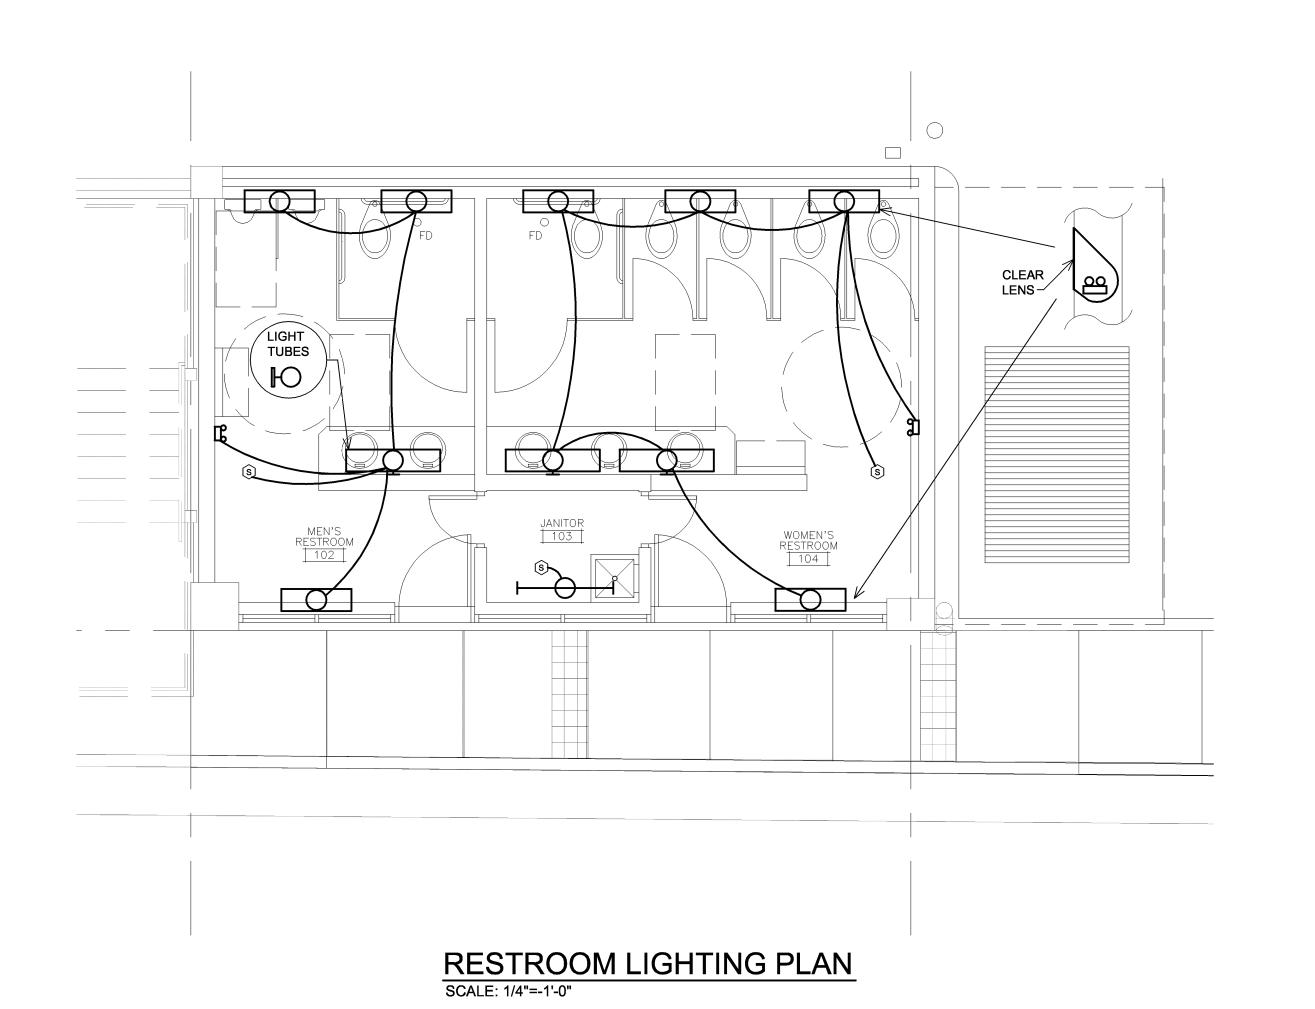







MECHANICAL ELECTRICAL ROOM POWER/SIGNAL PLAN

SCALE: 1/4"=-1'-0"

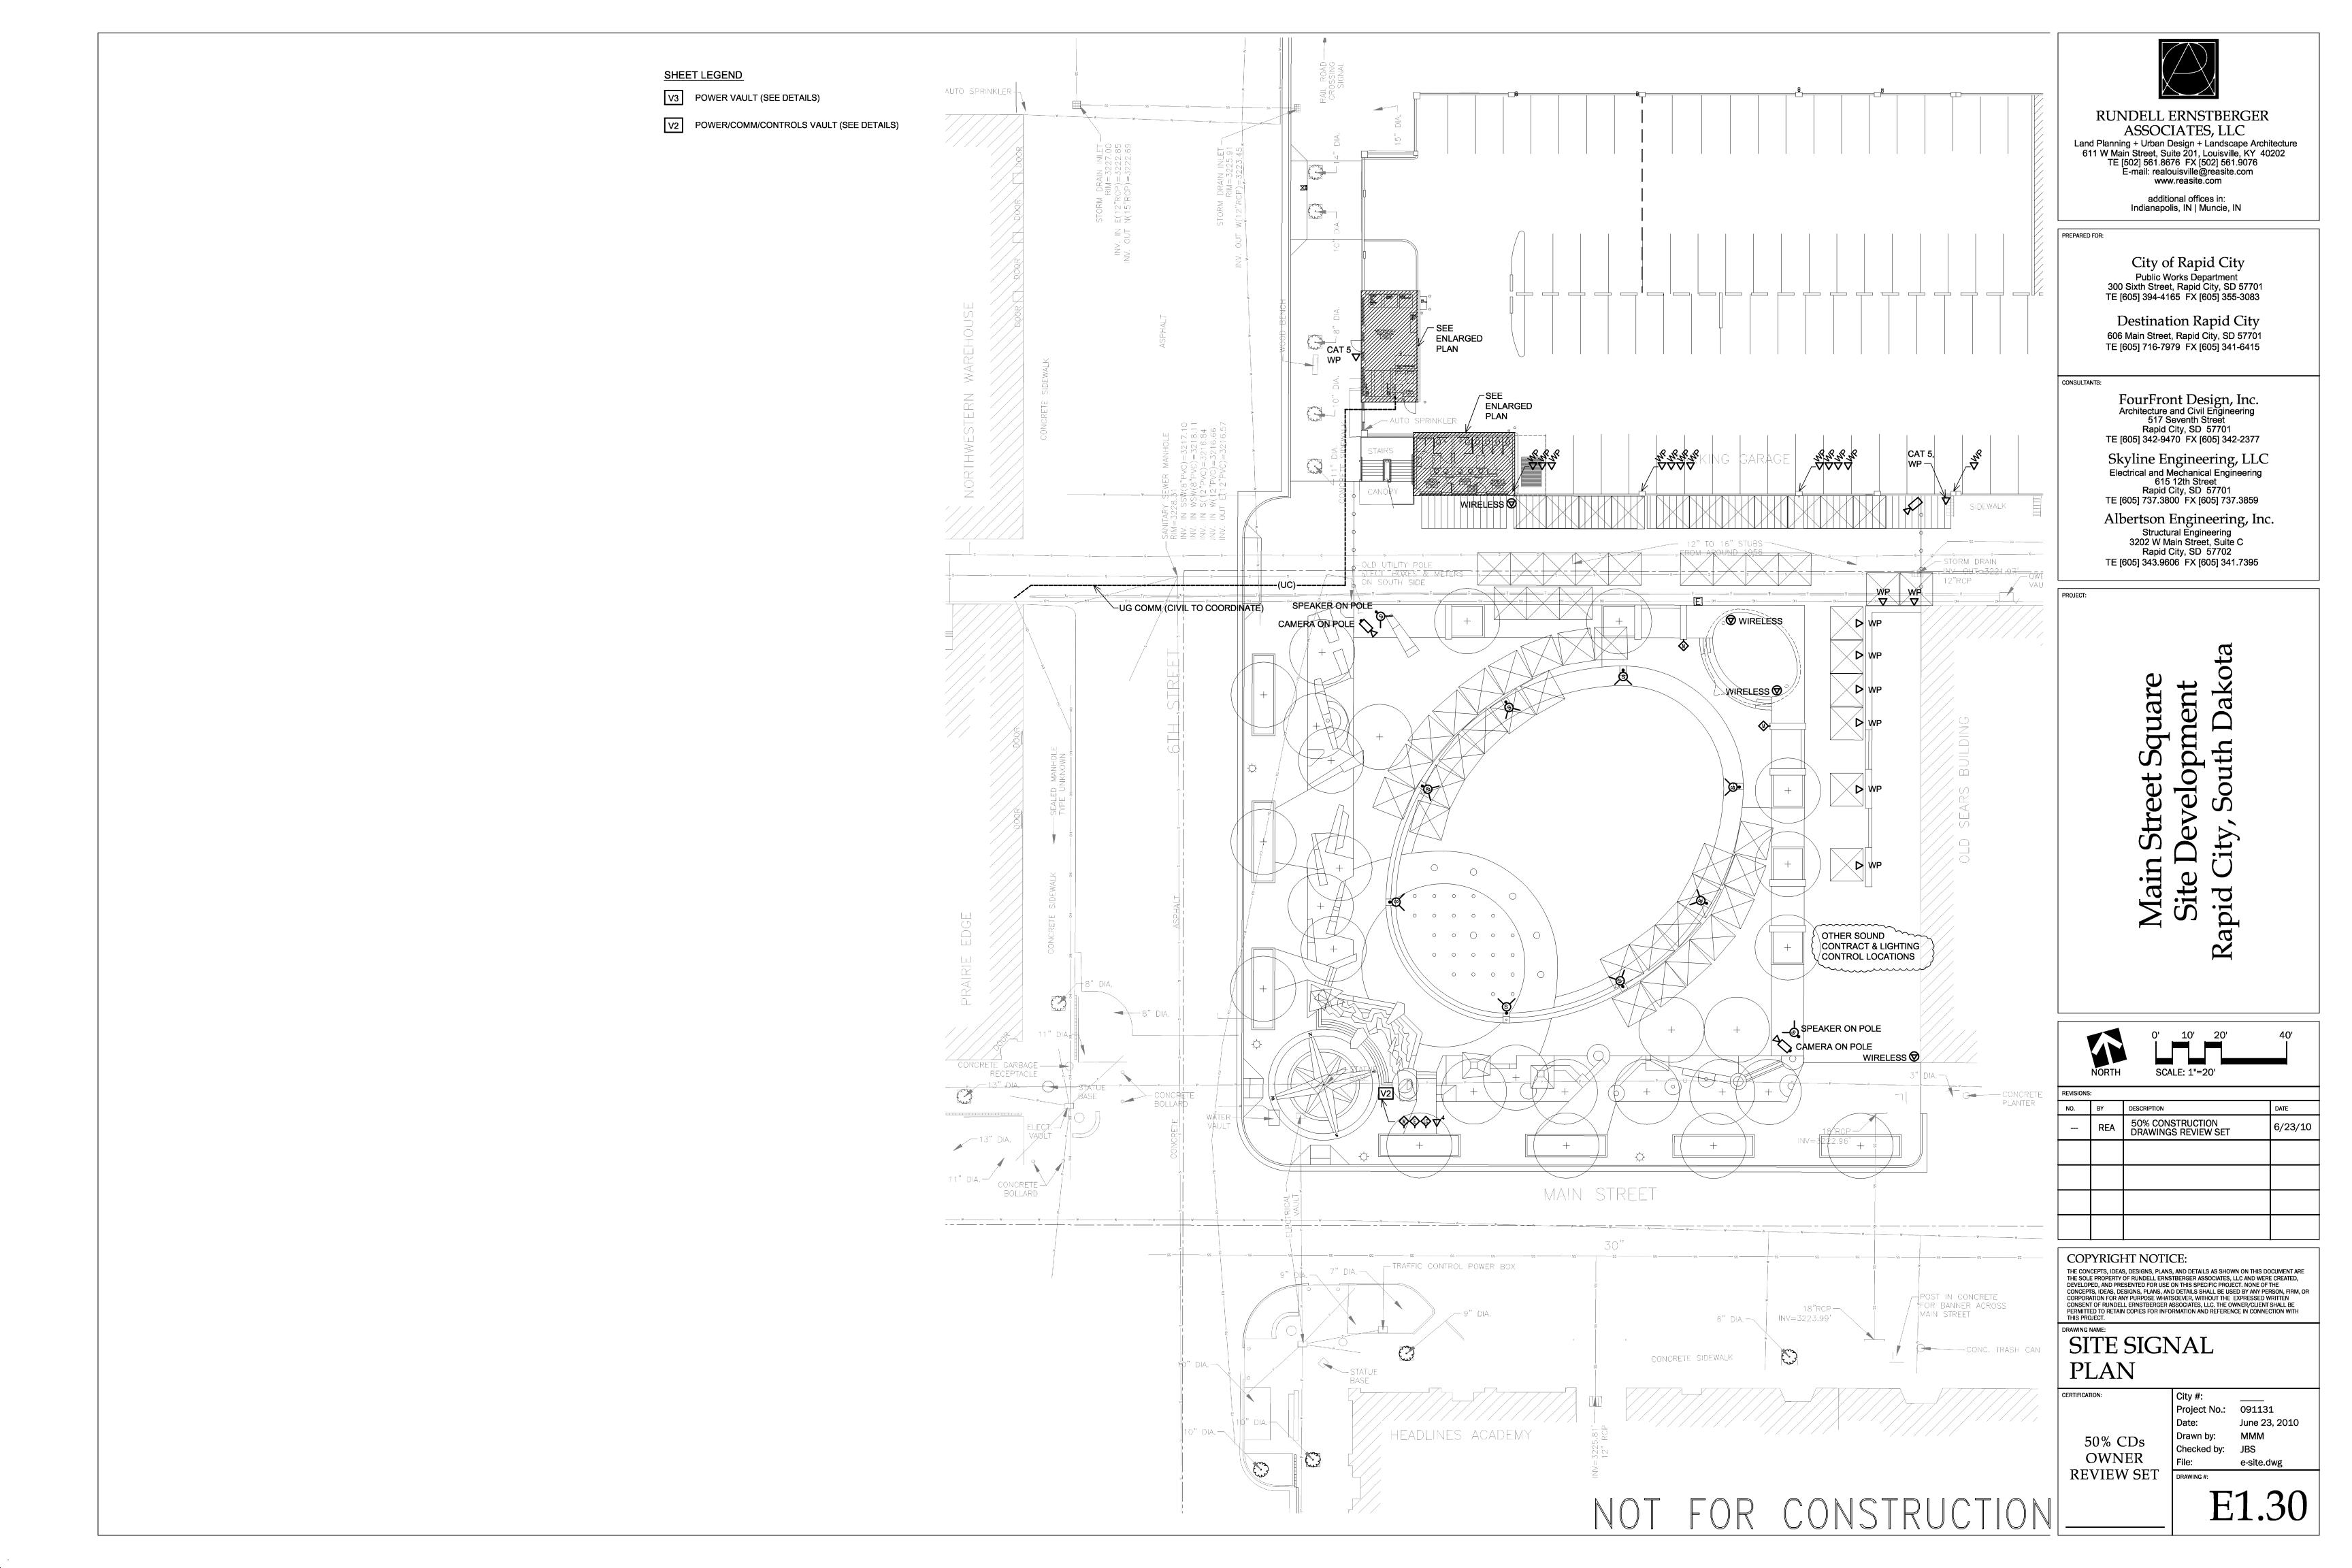


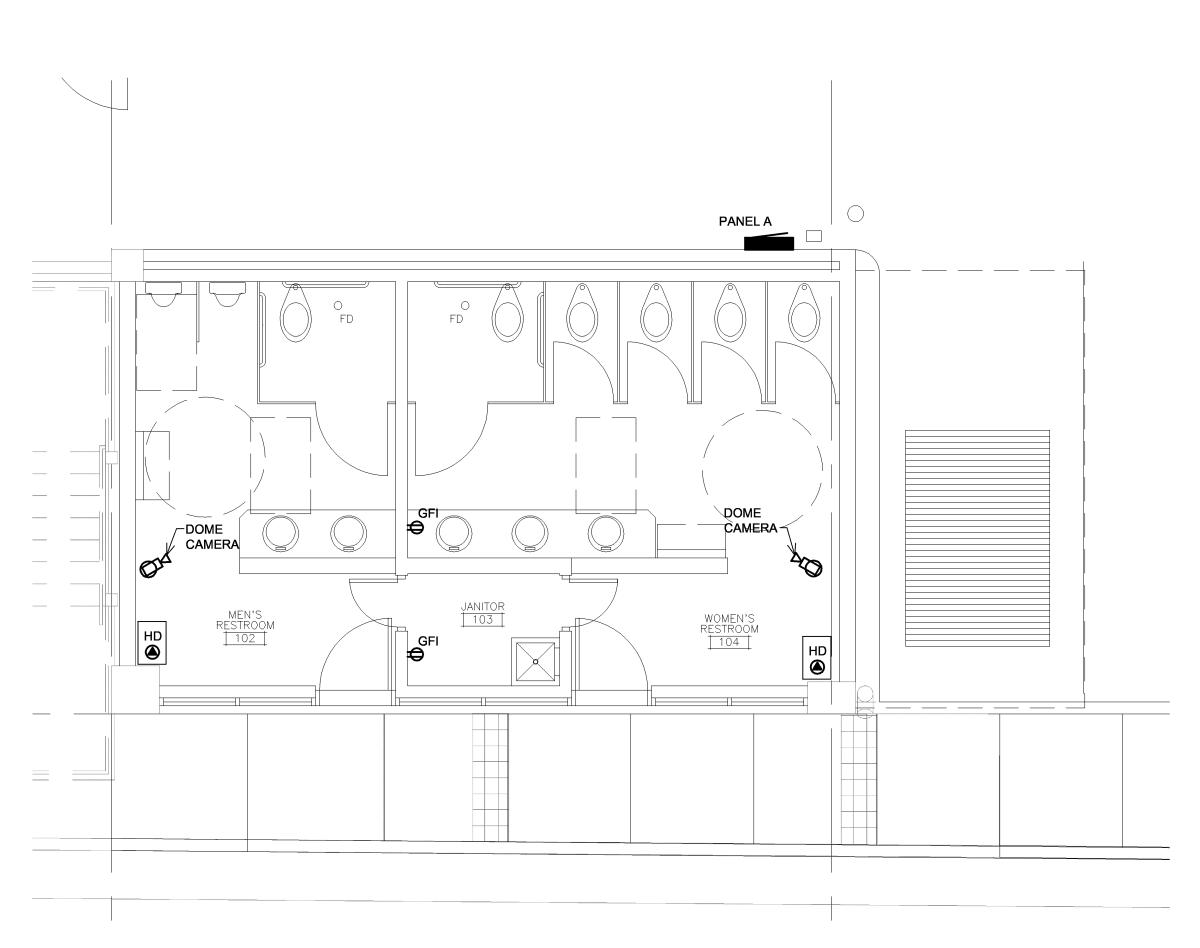

RESTROOM POWER/SIGNAL PLAN

SCALE: 1/4"=-1'-0"

NOT FOR CONSTRUCTION\_

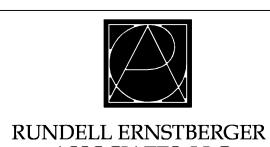

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PROJECT:

Main Street Square Site Development Rapid City, South Dakota

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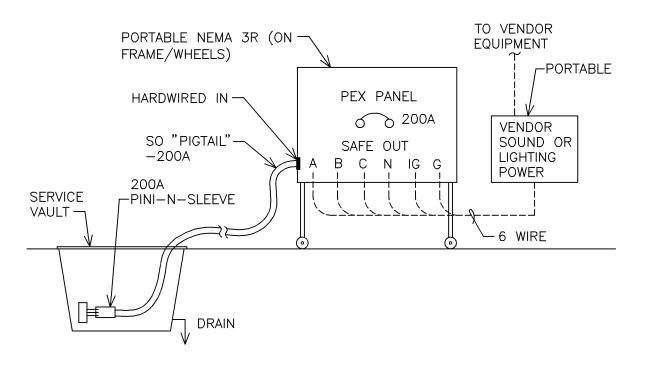
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ELECTRICAL FLOOR PLANS


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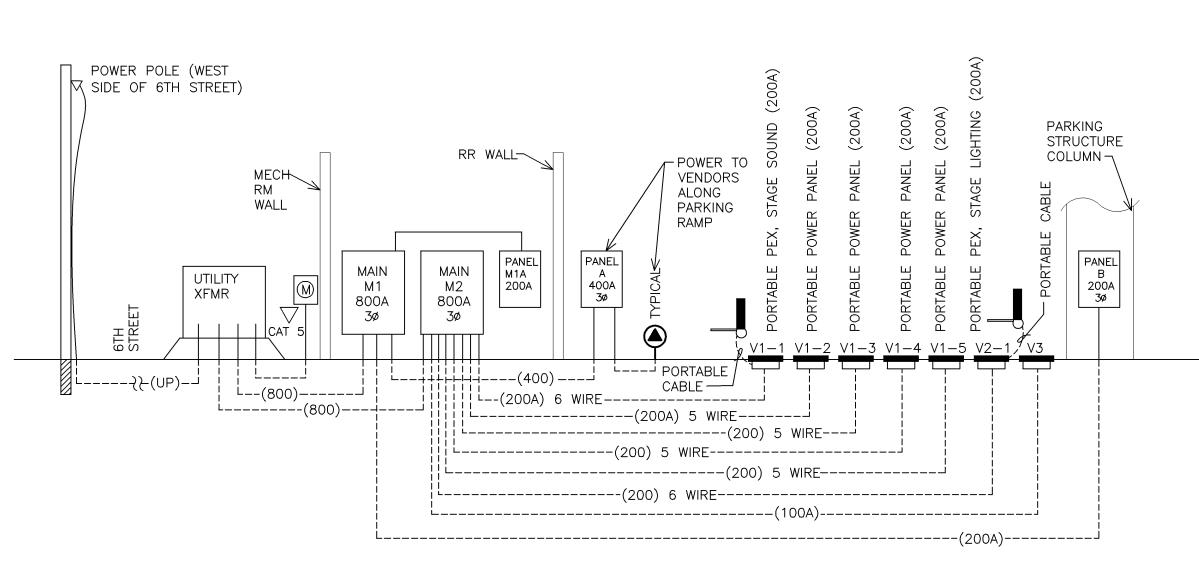
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SERVICE VAULT INTERFACE DIAGRAM TO VENDOR POWER (PEX) (TYPICAL - SOUND & LIGHTING) SCALE: NTS



SERVICE VAULT INTERFACE DIAGRAM TO TENT VENDORS (PEX) (TYPICAL - VENDOR POWER PANELS)



208V ELECTRICAL SERVICE RISER SCALE: NTS

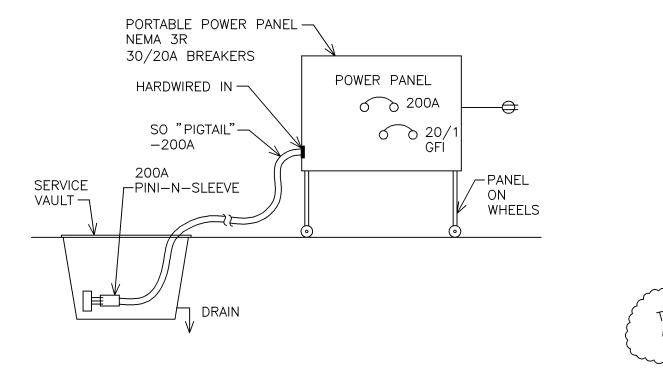

ALLEY POWER POLE - 480V, 600A, ICE CHILLER SERVICE DISCONNECT -480∨,3ø, ICE CHILLER SERVICE XFMR (BY POWER (LOCKABLE 3R) COMPANY) ICE CHILLER-BY OTHERS CAT

480V ELECTRICAL RISER

DATA RACK

TO BE EDITED

SCALE: NTS

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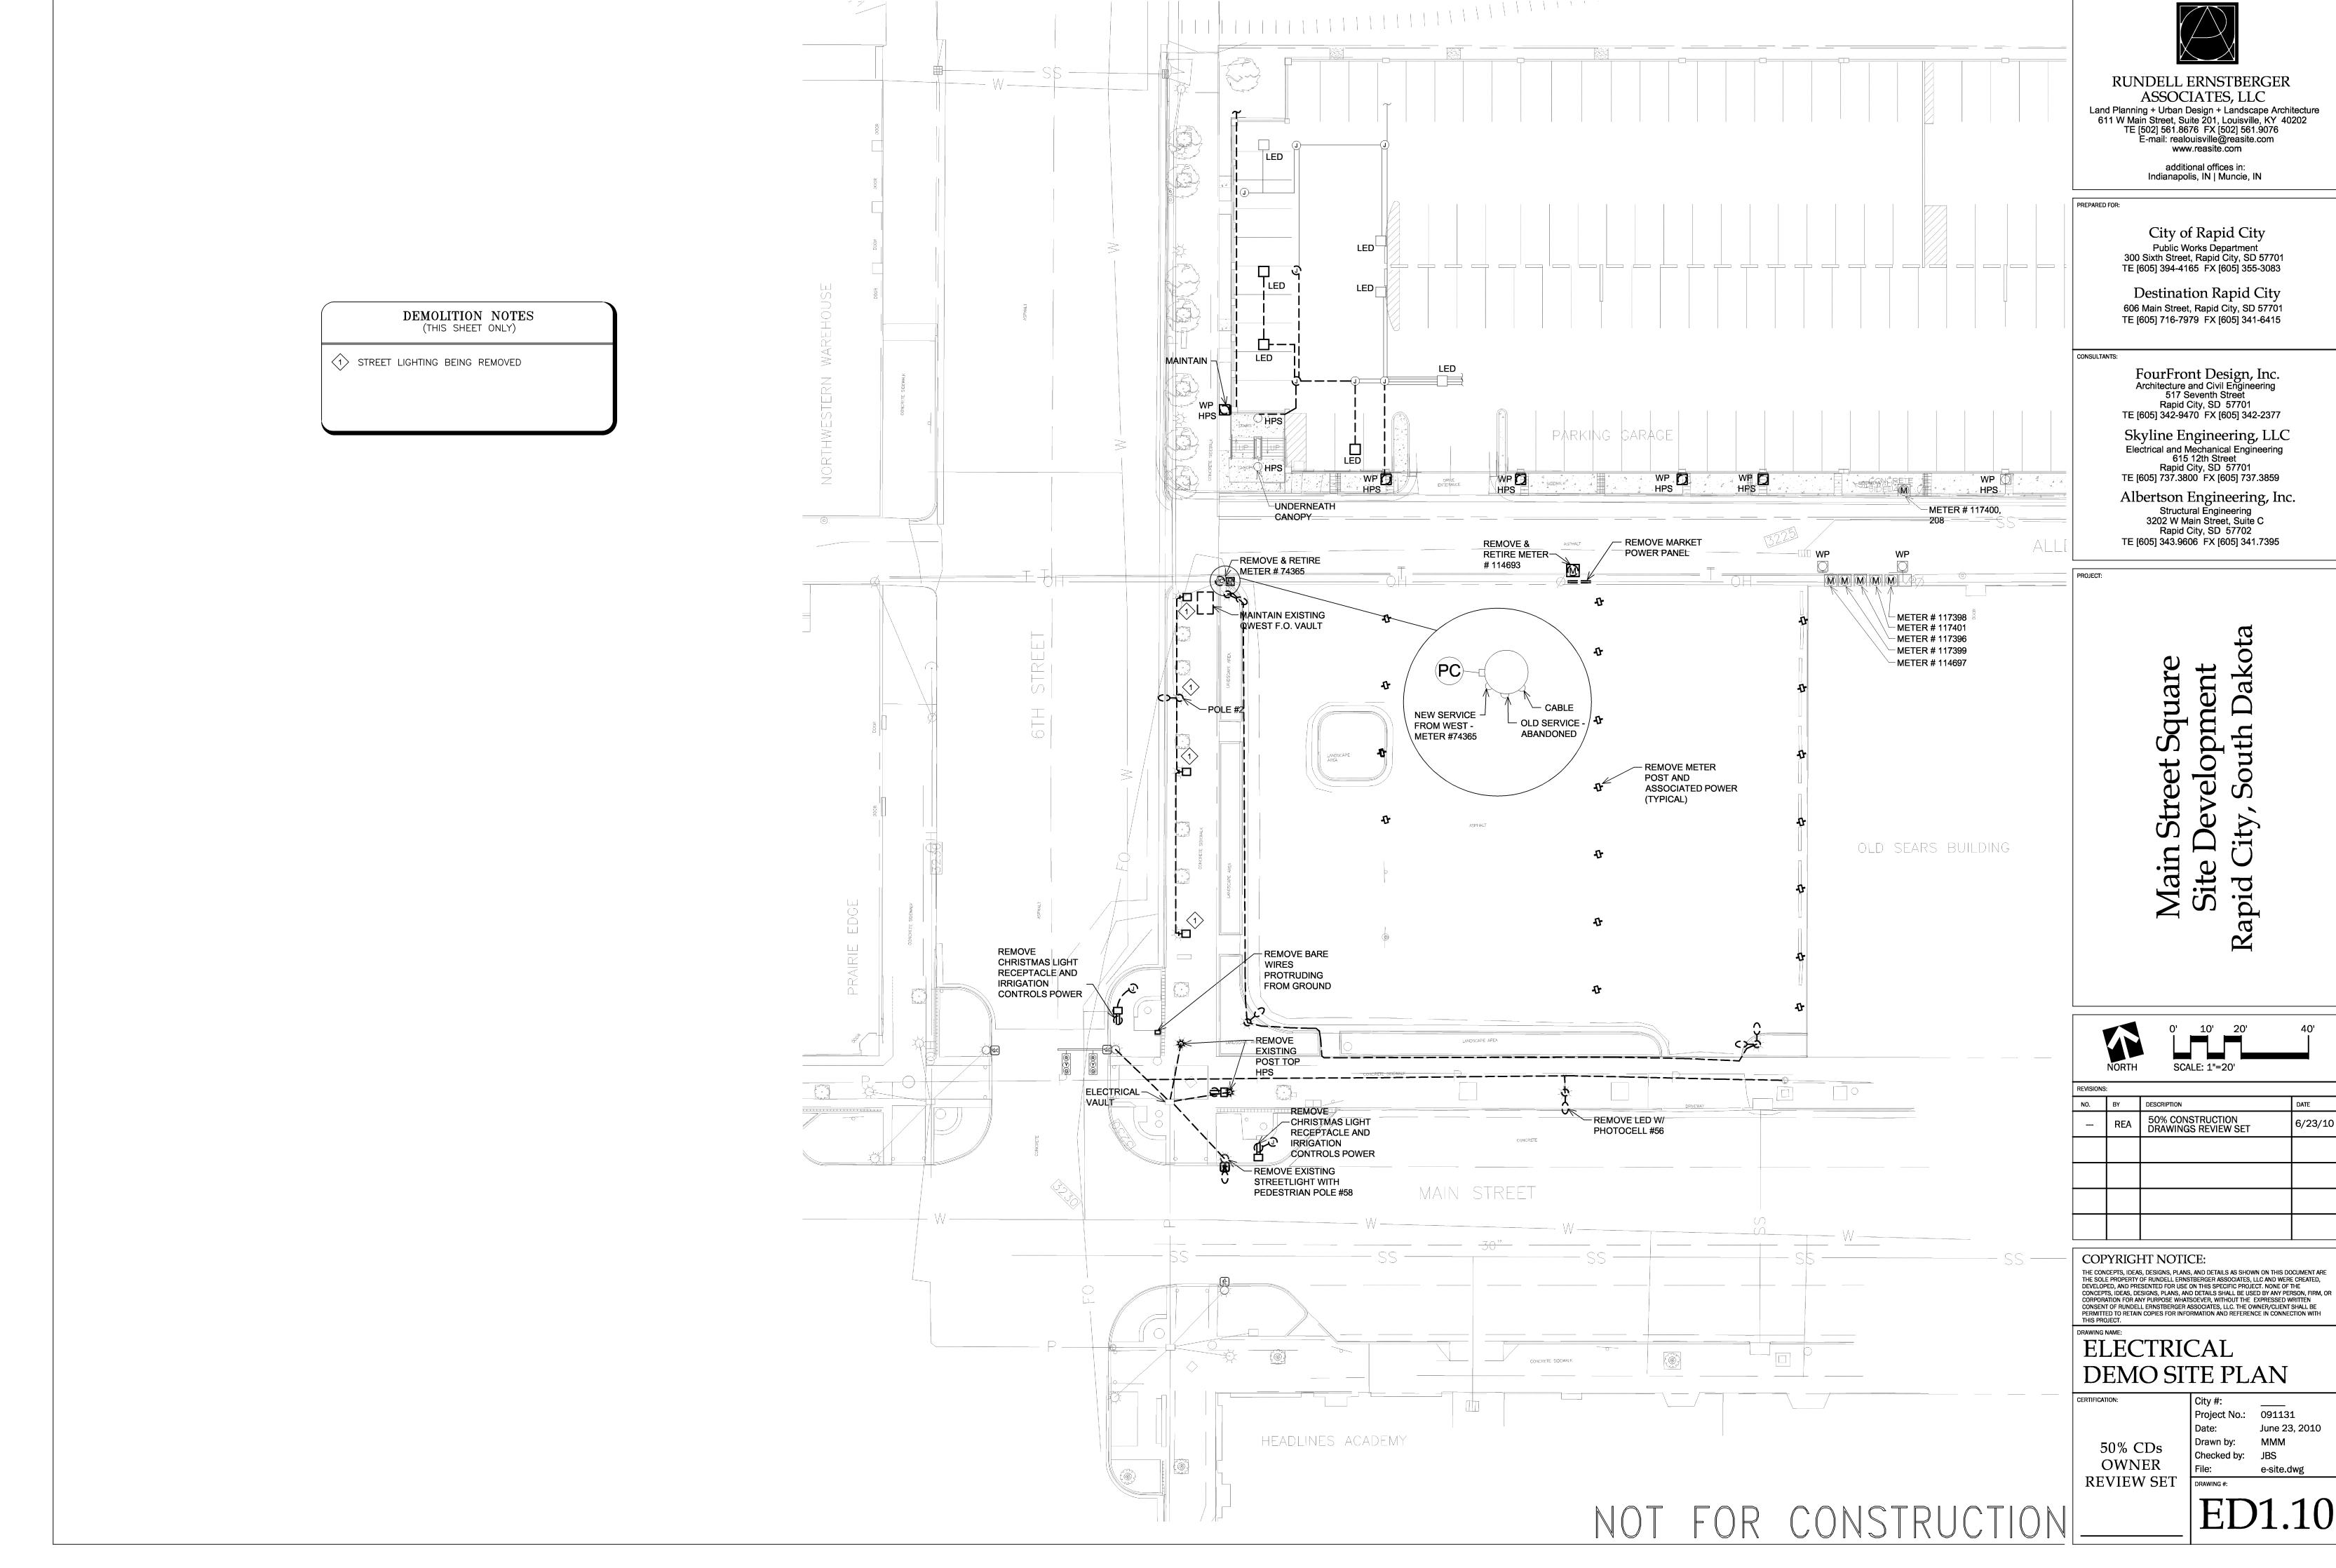
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**ELECTRICAL** SCHEDULES & RISERS

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| AC         |  |                |   |   |   |
|------------|--|----------------|---|---|---|
|            | AIR COMPRESSOR   | HTG            | HEATING   |   | M   |
| A.F.F.     | AREA DRAIN  ABOVE FINISHED FLOOR                       | HTR            | HEATER HUMIDIFIER                                   |   | DOMESTIC COLD WATER                                   |
| AFMS       | AIR FLOW MEASURING STATION                             |                | HEATING, VENTILATING                                |   | DOMESTIC HOT WATER                                    |
| AHU        | AIR HANDLING UNIT                                      | HVAC           | AND AIR CONDITIONING                                |   | RECIRCULATING HOT WATER                               |
| ANB        | ACID NEUTRALIZING BASIN                                | HWC            | HEATING WATER CIRCULATING                           | CW                                      | COLD WATER LOW PRESSURE                               |
| AP<br>ARCH | ACCESS PANEL  ARCHITECT                                | HYD            | HEAT EXCHANGER HYDRANT                              | ——HPCW————                              | HIGH PRESSURE COLD WATER HIGH PRESSURE HOT WATER      |
| AS         | AIR SEPARATOR  | HW             | HOT WATER   | SCW ——                                  | SOFTENED COLD WATER                                   |
| BD         | BUTTERFLY DAMPER                                       | ICH            | ICE CHILLER   |   | SOFTENED HOT WATER                                    |
| B/G        | BELOW GRADE  | INSUL          | INSULATION  | <del></del> 180 <del></del>             | DOMESTIC HOT WATER (TEMP.                             |
| BFP<br>BLP | BOILER FEEDER PUMP  BOILER PUMP                        | JP             | JOCKEY PUMP   |   | RECIRCULATING HOT WATER                               |
| BHW        | BOILER - HOT WATER                                     | KW             | KILOWATT  | RO                                      | REVERSE OSMOSIS WATER DEIONIZED WATER SUPPLY          |
| BST        | BOILER — STEAM   | LAT            | LEAVING AIR TEMPERATURE                             | ——————————————————————————————————————  | DEIONIZED WATER RETURN                                |
| BTU        | BRITISH THERMAL UNIT                                   | LAV            | LAVATORY  | CHS                                     | CHILLED WATER SUPPLY                                  |
| BWV        | BACKWATER VALVE  | LH             | LIGHT HAZARD  | — CHR — —                               | CHILLED WATER RETURN                                  |
| CAF        | COMBUSTION AIR FAN  COMBUSTION AIR UNIT                | LWT<br>MBH     | LEAVING WATER TEMPERATURE  BTU PER HOUR (THOUSANDS) | —— EP HWS ——  — EP HWR — —              | ENERGY PLANT HEATING WATER ENERGY PLANT HEATING WATER |
| CCF        | HUNDRED CUBIC FEET                                     | MCF            | THOUSAND CUBIC FEET                                 | LT HWS                                  | LOW TEMPERATURE HEATING WA                            |
| CFH        | CUBIC FEET PER HOUR                                    | МН             | MANHOLE   | — — LT HWR — —                          | LOW TEMPERATURE HEATING WA                            |
| CFM        | CUBIC FEET PER MINUTE                                  | MUA            | MAKE-UP AIR UNIT                                    |   | HEATING WATER SUPPLY                                  |
| CHP        | CHILLER CHILLER PUMP                                   | NC<br>NC       | NOISE CRITERIA  NORMALLY CLOSED                     | — — HWR — —                             | HEATING WATER RETURN  EXISTING PIPING TO REMAIN (LI   |
| CL         | CENTER LINE  | NEG            | NEGATIVE  | BF                                      | BOILER FEED   |
| CLG        | CEILING  | NIC            | NOT IN CONTRACT                                     | X#STM                                   | STEAM (PRESSURE INDICATED)                            |
| CO         | CLEAN OUT  | NO             | NORMALLY OPEN                                       | — ×#c — —                               | CONDENSATE (PRESSURE INDICA                           |
| CONTR      | CONDENSER UNIT  CONTRACTOR                             | NPW<br>NTS     | NON-POTABLE WATER  NOT TO SCALE                     | — PC — —                                | PUMPED CONDENSATE  RADIATION WATER SUPPLY             |
| CONV       | CONVECTOR  | OA             | OUTSIDE AIR   | ———RADS———                              | RADIATION WATER SUPPLY                                |
| CTW        | COOLING TOWER  | OBD            | OPPOSED BLADE DAMPER                                |   | ENGINE RADIATOR SUPPLY                                |
| CUH        | CABINET UNIT HEATER                                    | OH-1           | ORDINARY HAZARD 1                                   | — — RRR — —                             | ENGINE RADIATOR RETURN                                |
| CWC        | COLD WATER COOLING WATER COIL                          | ORD<br>PA      | OVERFLOW ROOF DRAIN PRIMARY AIR                     | ——————————————————————————————————————  | SNOW MELT SUPPLY                                      |
| CWP        | CHILLED WATER PUMP                                     | PAC            | PNEUMATIC AIR COMPRESSOR                            | — SMR — — FOS —                         | SNOW MELT RETURN  FUEL OIL SUPPLY                     |
| DB         | DECIBEL  | PCP            | PRIMARY COOLING PUMP                                | — — FOR — —                             | FUEL OIL RETURN                                       |
| DBC        | DESICCANT BASED COOLING                                | PD             | PRESSURE DROP OR DIFFERENCE                         | — FOV— —                                | FUEL OIL VENT   |
| DEF        | DRYER EXHAUST FAN                                      | PE             | PNEUMATIC—ELECTRIC                                  | — FOF —                                 | FUEL OIL FILL   |
| DF0<br>DIA | DRINKING FOUNTAIN  DIAMETER                            | PHP<br>PLBG    | PRIMARY HEATING PUMP PLUMBING                       | ——————————————————————————————————————  | CONDENSATE DRAIN  REFRIGERANT LIQUID                  |
| DIFF       | DIFFUSER   |                | PRESSURE REDUCING VALVE (or)                        | —— RS ——                                | REFRIGERANT SUCTION                                   |
| DISCH      | DISCHARGE  | PRV            | POWER ROOF VENTILATOR                               | RHG                                     | REFRIGERANT HOT GAS                                   |
| DMP        | DAMPER, GRAVITY  | PSIA           | POUNDS/SQ INCH ABSOLUTE                             | LPG                                     | LIQUEFIED PETROLEUM GAS                               |
| DN<br>DR   | DOWN DRAIN   | PSIG<br>PVC    | POUNDS/SQ INCH GAUGE POLY VINYL CHLORIDE            | ——————————————————————————————————————  | COMPRESSED AIR HOUSE CLEANING VACUUM                  |
| DS         | DOWNSPOUT  | RA             | RETURN AIR  | 10#A —                                  | COMPRESSED AIR (PSI INDICATE                          |
| DWG        | DRAWING  | RAD            | RADIATION HEATER                                    | 2#G(F)—                                 | NATURAL GAS FIRM SERVICE (P                           |
| DWP        | CIRCULATING WATER PUMP (DOMESTIC)                      | RCP            | REINFORCED CONCRETE PIPE                            | 2#G(I)——                                | NATURAL GAS INTERRUPTIBLE                             |
| (E)<br>EA  | EXISTING EXHAUST AIR                                   | RD<br>RECIRC   | ROOF DRAIN RECIRCULATING                            | MDC                                     | SERVICE (PSI INDICATED)                               |
| EAT        | ENTERING AIR TEMPERATURE                               | REG            | REGISTER  | —— MPG ———                              | MEDIUM PRESSURE NATURAL GA HIGH PRESSURE NATURAL GAS  |
| EDH        | ELECTRIC DUCT HEATER                                   | RET            | RETURN  | — DT — —                                | SOIL DRAINAGE TILE                                    |
| EDR        | EQUIVALENT DIRECT RADIATION                            | RF             | RETURN FAN  |   | SANITARY WASTE — BELOW GRA                            |
| EF         | EXHAUST FAN  | RH             | RELATIVE HUMIDITY REHEAT                            |   | SANITARY WASTE - ABOVE GRA                            |
| EGN<br>EJP | EMERGENCY GENERATOR  EJECTION PUMP (VACUUM WASTE SYS.) | RHT<br>RHC     | RE-HEAT COIL  | — V — — — — — — — — — — — — — — — — — — | SANITARY VENT  ACID WASTE — BELOW GRADE               |
| ELP        | ELECTRICAL LIGHTING PANEL                              | RHW            | RECIRCULATED HOT WATER                              | AW                                      | ACID WASTE - ABOVE GRADE                              |
| ELV        | ELEVATOR   | RM             | ROOM  | AV                                      | ACID VENT — BELOW GRADE                               |
| EP         | ELECTRIC – PNEUMATIC                                   | RPM            | REVOLUTIONS PER MINUTE                              | AV                                      | ACID VENT — ABOVE GRADE                               |
| ESB<br>EWC | ELECTRIC SWITCHBOARD  ELECTRIC WATER COOLER            | RPZ<br>RTU     | REDUCED ZONE BACKFLOW PREVENTER ROOF TOP UNIT       | LW                                      | LAB WASTE — BELOW GRADE  LAB WASTE — ABOVE GRADE      |
| EWT        | ENTERING WATER TEMPERATURE                             | SA             | SUPPLY AIR  | LW——LV——                                | LAB VENT — BELOW GRADE                                |
| EXH        | EXHAUST  | SAN            | SANITARY  | LV                                      | LAB VENT — ABOVE GRADE                                |
| EXP        | EXPANSION  | SCFM           | CFM, STANDARD CONDITIONS                            | GW                                      | GREASE WASTE — BELOW GRAD                             |
| FAN        | FAHRENHEIT  (EYHALIST SUPPLY)                          | SCP<br>SD      | SECONDARY COOLING PUMP                              | GW                                      | GREASE WASTE — ABOVE GRADE                            |
| FAN<br>FC  | (EXHAUST, SUPPLY)  FLUID COOLER                        | SD<br>SF       | SMOKE DAMPER SUPPLY (PRESSURIZATION) FAN            |   | STORM DRAIN — BELOW GRADE  STORM DRAIN — ABOVE GRADE  |
| FCU        | FAN COIL UNIT  | SHP            | SECONDARY HEATING PUMP                              | OSD                                     | OVERFLOW STORM DRAIN — BE                             |
| FCO        | FLOOR CLEAN OUT  | SP             | STATIC PRESSURE                                     | OSD                                     | OVERFLOW STORM DRAIN — AB                             |
| FD         | FIRE DAMPER OR FLOOR DRAIN                             | SPECS          | SPECIFICATIONS                                      | <b>ୁ</b>                                | PRESSURE GAUGE W/ PIGTAIL                             |
| FHC<br>FHR | FIRE HOSE CABINET  FIRE HOSE RACK                      | SUP<br>SQ      | SUPPLY<br>SQUARE                                    | <u> </u>                                |   |
| FLR        | FLOOR  | ST             | STORAGE TANK  | <u> </u>                                | THERMOMETER   |
| FLEX       | FLEXIBLE   | STM            | STEAM   | Ø                                       | DDECCLIDE CALICE W/ DETCC:                            |
| FM         | FIRE MAIN  | TD             | TEMPERATURE DIFFERENCE                              | <u> </u>                                | PRESSURE GAUGE W/ PETCOCK                             |
| FOP        | FUEL OIL PUMP  | TEMP           | TEMPERATURE TONS OF REFRICERATION                   | Ų                                       | PRESSURE/TEMPERATURE TEST                             |
| FPM        | FIRE PUMP FEET PER MINUTE                              | TONS<br>T-STAT | TONS OF REFRIGERATION THERMOSTAT                    |   | , ,   |
| FPS        | FEET PER SECOND  | TYP            | TYPICAL   | ——⊗——                                   | STEAM TRAP (TYPE INDICATED)                           |
| FS         | FLOOR SINK   | UB             | UP-BLAST  |   | FLOW MEACHBING STATION (FLO                           |
| FSP        | FIRE SUPPRESSION PUMP                                  | UG             | UNDERGROUND   | GPM                                     | FLOW MEASURING STATION (FLC                           |
| FT<br>F&T  | FEET OR FOOT  FLOAT AND THERMOSTATIC                   | UH             | UNIT HEATER UNIT VENTILATOR                         | □FS                                     | FLOW SWITCH   |
| FTG        | FOOTING  | UR             | URINAL  |   |   |
| FTR        | FINNED TUBE RADIATION                                  | V              | SANITARY VENT                                       |   | PRESSURE SWITCH                                       |
| FUR        | FURNACE (GAS, ELECTRIC)                                | VAV            | VARIABLE AIR VOLUME                                 | <b>■</b> WHA                            | WATER HAMMER ARRESTER                                 |
| FV<br>GA   | FACE VELOCITY  GAUGE                                   | VD<br>VEL      | VOLUME DAMPER  VELOCITY                             |   | (PDI SIZING INDICATED)                                |
| GAL        | GALLON   | VEL            | VARIABLE FREQUENCY DRIVE                            |   |   |
| GCO        | GRADE CLEANOUT   | VOL            | VOLUME  |   | THERMOMETER WELL                                      |
| GDO        | GARAGE DOOR OPENER                                     | VP             | VACUUM PUMP (VACUUM WASTE SYS.)                     |   |   |
| GHP        | GLYCOL HEATING PUMP                                    | W              | SANITARY WASTE                                      |   |   |
| GP<br>GPH  | GRINDER PUMP (VACUUM WASTE SYS.)  GALLONS PER HOUR     | W/<br>WAC      | WITH WINDOW AIR CONDITIONER                         |   |   |
| GPH<br>GPM | GALLONS PER MINUTE                                     | W/O            | WITHOUT   |   |   |
| GR         | GRILLE   | WC             | WATER CLOSET  |   |   |
|            | GAS WATER HEATER                                       | WCO            | WALL CLEAN OUT                                      |   |   |
|            |  |                |   |   |   |
| НВ         | HOSE BIBB  | WH             | WALL HYDRANT (or)                                   |   |   |
| GWH HB HD  |  |                |   |   |   |

|   |  | MECHANI  | CAL SYMBOLS LEGEND  |   |  |
|---|--|--|---|---|--|
|   | MECHANIC   | AL PIPING  |   |   | DUCTWORK   |
|   | DOMESTIC COLD WATER  |  | ELBOW DOWN  | <b>←</b> √-   | EXHAUST AIR  |
|   | DOMESTIC HOT WATER   | <u>_</u>   | CLEANOUT  | <del>&lt; //-</del>   | RETURN AIR   |
| CW                                      | RECIRCULATING HOT WATER  COLD WATER LOW PRESSURE                           |  | PIPE CAP<br>ELBOW UP  |   | SUPPLY AIR STANDARD BRANCH, NO SPLITTER —                              |
| ——HPCW———                               | HIGH PRESSURE COLD WATER   | <del></del>                                      | TEE, OUTLET UP  | 且   | SUPPLY FLOW TO RIGHT — RETURN/<br>EXHAUST FLOW TO LEFT                 |
| ——HPHW———                               | HIGH PRESSURE HOT WATER  |  | TEE, OUTLET DOWN  | ¥,  | BELLMOUTH WITH BALANCING DAMPER  |
| SCW                                     | SOFTENED COLD WATER  SOFTENED HOT WATER                                    | Î  | CONNECTION, BOTTOM  | , <u>, , , , , , , , , , , , , , , , , , </u>                                   |  |
| 180                                     | DOMESTIC HOT WATER (TEMP. INDICATED)                                       |  | ECCENTRIC REDUCER   | mmmu.   | FLEXIBLE DUCT  |
| ——HWC ———                               | RECIRCULATING HOT WATER REVERSE OSMOSIS WATER                              |  | CONCENTRIC REDUCER FLEXIBLE CONNECTION                        |   | TURNING VANES  |
| RO                                      | DEIONIZED WATER SUPPLY   | BXXXX  | EXPANSION JOINT   | ₩ *   | FLEXIBLE CONNECTION  |
| DIR                                     | DEIONIZED WATER RETURN   | ×  | PIPE ANCHOR   |   | TELABLE CONNECTION   |
| ——————————————————————————————————————  | CHILLED WATER SUPPLY CHILLED WATER RETURN                                  |  | ALIGNMENT GUIDE  CHECK VALVE                                  | <u> </u>  | MANUAL VOLUME DAMPER   |
| EP HWS                                  | ENERGY PLANT HEATING WATER SUPPLY  |  | SHUTOFF VALVE   | MD ###  | MOTORIZED DAMPER   |
| — — EP HWR — —                          | ENERGY PLANT HEATING WATER RETURN  | —— <del> </del> ŏ——                              | PLUG VALVE  | / FD  |  |
| — LT HWS — —                            | LOW TEMPERATURE HEATING WATER SUPPLY  LOW TEMPERATURE HEATING WATER RETURN | — <del>                                   </del> | BALANCING VALVE STRAINER                                      |   | FIRE DAMPER & ACCESS PANEL   |
| ——————————————————————————————————————  | HEATING WATER SUPPLY   | , <b>3</b> ,                                     |   | SD ###  | SMOKE DAMPER & ACCESS PANEL  |
| — — HWR — —                             | HEATING WATER RETURN   | <u>, A.</u>                                      | STRAINER W/BLOWDOWN VALVE AND CAP                             | FSD +##   | COMBINATION FIRE/SMOKE DAMPER  |
| BF                                      | EXISTING PIPING TO REMAIN (LIGHT LINE)  BOILER FEED                        |  | PRESSURE REDUCING VALVE (SETTING AS NOTED, PSI)               |   | & ACCESS PANEL   |
| X#STM                                   | STEAM (PRESSURE INDICATED)   | <b>—————————————————————————————————————</b>     | AUTOMATIC CONTROL VALVE, 2—WAY                                |   | RETURN OR EXHAUST GRILLE<br>OR REGISTER                                |
| ×#C                                     | CONDENSATE (PRESSURE INDICATED)  | ——————————————————————————————————————           | AUTOMATIC CONTROL VALVE, 3—WAY                                | <b>→ → →</b>  | SUPPLY GRILLE OR REGISTER  |
| — PC — — RADS — —                       | PUMPED CONDENSATE  RADIATION WATER SUPPLY                                  | Τ  | 7   |   |  |
| — RADR — —                              | RADIATION WATER RETURN   | <u></u>  | AUTOMATIC AIR VENT<br>MANUAL AIR VENT                         |   | SUPPLY DUCT UP, POSITIVE PRESSURE                                      |
| RRS                                     | ENGINE RADIATOR SUPPLY   | <del>\</del>                                     | PRESSURE RELIEF/SAFETY VALVE (SETTING AS NOTED, PSI)          |   | RETURN DUCT UP, NEGATIVE PRESSURE                                      |
| — RRR — — SMS —                         | ENGINE RADIATOR RETURN  SNOW MELT SUPPLY                                   | <b>&gt;</b>                                      | HOSE END DRAIN VALVE  |   | EXHAUST DUCT UP, NEGATIVE PRESSURE                                     |
| — SMR — —                               | SNOW MELT RETURN   | <b>───────</b>                                   | HOSE END GATE VALVE   | <b>&gt; &gt; &gt; &gt;</b>  | SUPPLY DUCT DOWN, POSITIVE PRESSURE                                    |
| FOS —                                   | FUEL OIL SUPPLY  | <b>───</b> ₩ <b>─</b> Ⅱ                          | HOSE END GLOBE VALVE  |   | RETURN DUCT DOWN, NEGATIVE PRESSURE                                    |
| — FOR — —                               | FUEL OIL RETURN FUEL OIL VENT  |  | BALL VALVE BUTTERFLY VALVE                                    | <b>₹</b>  | EXHAUST DUCT DOWN, NEGATIVE PRESSURE                                   |
| FOF                                     | FUEL OIL FILL  |  | DIAPHRAGM VALVE   |   | SUPPLY DIFFUSER/REGISTER<br>BLANKOFF INDICATED DARK                    |
| CD                                      | CONDENSATE DRAIN  REFRIGERANT LIQUID                                       | <u> </u>   | GLOBE ANGLE VALVE   |   | BLAINCOFF INDICATED DARK   |
| — RS — —                                | REFRIGERANT SUCTION  |  | O. S. & Y. VALVE  |   | RETURN GRILLE/REGISTER   |
| RHG                                     | REFRIGERANT HOT GAS  | <b>──₩</b> ₹₩ <b>─</b>                           | REDUCED PRESSURE ZONE<br>BACKFLOW PREVENTER                   |   | EXHAUST GRILLE/REGISTER  |
| LPG                                     | LIQUEFIED PETROLEUM GAS  COMPRESSED AIR                                    | [S]  | SOLENOID VALVE  |   | ·  |
| ——————————————————————————————————————  | HOUSE CLEANING VACUUM  |  | FLOW LIMITING VALVE   | F   | LINEAR DIFFUSER  |
| 10#A ———                                | COMPRESSED AIR (PSI INDICATED)   |  | REFRIGERANT SIGHT GLASS                                       |   | CONCENTRIC DUCT TRANSITION   |
| 2#G(F)                                  | NATURAL GAS FIRM SERVICE (PSI INDICATED)  NATURAL GAS INTERRUPTIBLE        |  | GLOBE VALVE   | <u></u>   | ECCENTRIC DUCT TRANSITION  |
| 2    0(1)                               | SERVICE (PSI INDICATED)  |  | GAS PRESSURE REGULATOR VALVE BACKWATER VALVE                  | "N"   | DUCT CONSTRUCTION PRESSURE CLASS—<br>IFICATION (INCHES WATER AS NOTED) |
| MPG                                     | MEDIUM PRESSURE NATURAL GAS  |  | REFRIGERANT DRYER   |   | "N" INDICATES NEGATIVE PRESSURE  |
| —— HPG ———                              | HIGH PRESSURE NATURAL GAS  SOIL DRAINAGE TILE                              |  | FLOW DIRECTION  FLOW DIRECTION WITH PITCH                     | <b></b>   | ROUND—TO—RECTANGULAR DUCT TRANSITION                                   |
|   | SANITARY WASTE — BELOW GRADE   |  |   | <u> </u>  | SUPPLY TROFFER   |
| w                                       | SANITARY WASTE — ABOVE GRADE   | 8  | DUPLEX STRAINER   | FAV \   | VAV BOX (FAN POWERED, INDUCTION BOX                                    |
| — V — — — — — — — — — — — — — — — — — — | SANITARY VENT  ACID WASTE — BELOW GRADE                                    |  | PIPE UNION PIPE FLANGE  |   | W/ WATER HEATING COIL)   |
| AW                                      | ACID WASTE — ABOVE GRADE   |  | PUMP  | VAV ###   | VAV BOX W/ REHEAT COIL   |
| AV                                      | ACID VENT — BELOW GRADE  | •  | FLOOR DRAIN   |   | REHEAT COIL  |
| AV                                      | ACID VENT — ABOVE GRADE  LAB WASTE — BELOW GRADE                           |  | FLOOR SINK  |   | NEITENT GOIL   |
| LW                                      | LAB WASTE — ABOVE GRADE  | WH   | WALL HYDRANT HOSE BIBB  |   | EXISTING DUCT TO REMAIN (LIGHT LINE)                                   |
| LV                                      | LAB VENT — BELOW GRADE   | Ф  | FLOOR CLEANOUT  | DN UP   | DUCT OFFSETS   |
| LV                                      | LAB VENT — ABOVE GRADE  GREASE WASTE — BELOW GRADE                         | <u> </u>   | GRADE CLEANOUT  |   |  |
| GW                                      | GREASE WASTE - ABOVE GRADE   |  | WALL CLEANOUT  GAS COCK VALVE                                 |   | CONTROLS   |
| SD                                      | STORM DRAIN — BELOW GRADE  STORM DRAIN — ABOVE GRADE                       | 0  | ROOF DRAIN  | (sp)  | SMOKE DETECTOR   |
| ——————————————————————————————————————  | OVERFLOW STORM DRAIN — BELOW GRADE   | <b>⊚</b>   | OVERFLOW ROOF DRAIN   | 0   | THERMOSTAT SENSOR  |
| OSD                                     | OVERFLOW STORM DRAIN — ABOVE GRADE   | ⊗<br>⊗   | DRAIN ABOVE CURB STOP   | <u> </u>  | DUCT THERMOSTAT SENSOR   |
| <b>0</b>                                | PRESSURE GAUGE W/ PIGTAIL & PETCOCK  | ( <del>P</del> )                                 | CATCH BASIN   | (F)   | SPACE TEMPERATURE SENSOR HUMIDISTAT OR SPACE R.H. SENSOR               |
| <del></del> _                           | · ·  |  |   | (SP)  | STATIC PRESSURE SENSOR   |
|   | THERMOMETER  | ( )  | MANHOLE   | (P)   | DIFFERENTIAL PRESSURE SENSOR   |
| <u> </u>                                | PRESSURE GAUGE W/ PETCOCK  |  | DE DESTECTION   | <u> </u>  | AQUA STAT  OCCUPANCY SENSOR  |
| <u> </u>                                | DDECCUDE /TEMPERATURE  | ļ  | RE PROTECTION   | -   |  |
| <u> </u>                                | PRESSURE/TEMPERATURE TEST PORT   | F — F  | FIRE PROTECTION  POST INDICATOR VALVE (PIV)                   | <b> </b>  | ANNOTATION   |
| ——⊗——                                   | STEAM TRAP (TYPE INDICATED)  | <u></u> ≪-¢                                      | FIRE HYDRANT WITH SHUTOFF VALVE                               | X   | DETAIL NUMBER  |
|   | · · · · · · · · · · · · · · · · · · ·                                      | FDVC   | RECESSED FIRE DEPT CABINET                                    | X   | -SHEET NUMBER  |
| GPM                                     | FLOW MEASURING STATION (FLOW INDICATED)                                    | FDVC   | SURFACE MTD FIRE DEPT CABINET                                 | x   | —SECTION NUMBER  |
| Fs                                      | FLOW SWITCH  | 8  | FIRE PROTECTION RISER   | X X   | —SHEET NUMBER  |
| □PS                                     | PRESSURE SWITCH  | <u></u> ⊗  | UPRIGHT SPRINKLER HEAD W/GUARD PENDANT SPRINKLER HEAD         |   | POINT OF CONNECTION NEW TO EVICTIVE                                    |
| <u></u>                                 | PRESSURE SWITCH  | 0  | UPRIGHT SPRINKLER HEAD  | 0   | POINT OF CONNECTION, NEW TO EXISTING                                   |
| WHA                                     | WATER HAMMER ARRESTER<br>(PDI SIZING INDICATED)                            | O <sub>6</sub>                                   | UPRIGHT HEAD SERVED OFF GLYCOL SYSTEM SIDEWALL SPRINKLER HEAD | •   | POINT OF DISCONNECTION   |
|   | ,  | <b>□ □ □ □</b>                                   | SIDEWALL SPRINKLER HEAD WITH GUARD                            |   | DIFFUSER, REGISTER, GRILLE DESIGNATION                                 |
| ————                                    | THERMOMETER WELL   | O <sub>c</sub>                                   | CONCEALED SPRINKLER HEAD                                      | X -   | -CFM FLOW  |
| <u> </u>                                |  | O <sub>SR</sub>                                  | SEMI—RECESSED SPRINKLER HEAD EXTENDED COVERAGE HEAD           |   | EQUIPMENT DESIGNATION  |
|   |  | O <sub>EC</sub> €C                               | EXTENDED COVERAGE HEAD  EXTENDED COVERAGE SEMI—RECESSED HEAD  | $\left\langle \begin{array}{c} \hat{x} \\ \end{array} \right\rangle$            | — EQUIPMENT DESIGNATION — EQUIPMENT NUMBER                             |
|   |  | <del>б</del> т <u>s</u>                          | BUTTERFLY VALVE W/TAMPER SWITCH                               | TAC   | -VAV FAV FOU DECIDALATION  |
|   |  |  | DETECTOR CHECK W/BYPASS METER GRADE FIRE DEPT CONNECTION      | TAG   | VAV, FAV, FCU DESIGNATIONINDIVIDUAL DESIGNATION                        |
|   |  | п  | FLUSH FIRE DEPT CONNECTION                                    |   |  |
|   |  | FDV K  | FIRE DEPT VALVE W/CAP AND CHAIN                               | $\left  \left\langle \begin{array}{c} x \\ x \end{array} \right\rangle \right $ | —RADIANT HEATER DESIGNATION<br>—EQUIPMENT NUMBER                       |
|   |  |  | O. S. & Y VALVE W/ TAMPER SWITCH                              |   |  |
|   |  |  | DRYPIPE VALVE   |   |  |
|   |  | <u></u>  | PREACTION VALVE   |   |  |

SHEET INDEX

MO.00 MECHANICAL LEGEND AND SHEET INDEX

M1.00 UNDER FLOOR PLUMBING PLAN

M1.10 MECHANICAL PIPING AND PLUMBING PLAN

M2.10 HVAC PLAN AND DETAILS

M3.10 MECHANICAL SITE PLAN M4.00 MECHANICAL DETAILS AND PLUMBING RISERS M5.00 MECHANICAL SCHEDULES

ME1.0 MECHANICAL/ELECTRICAL SCHEDULES

#### GENERAL NOTES

- INSTALL VOLUME DAMPER IN DUCT TAKEOFF TO EACH DIFFUSER, GRILLE, AND REGISTER, UNLESS SAID DEVICE HAS AN INTEGRAL
- ALL DUCT TAKEOFFS TO BE HIGH EFFICIENCY TYPE UNLESS NOTED OTHERWISE.
- IN GENERAL, ALL PIPING AND DUCTWORK SHALL BE RUN CONCEALED IN SUSPENDED CEILING SPACES AND IN SHAFTS PROVIDED UNLESS NOTED OR INDICATED OTHERWISE. MECHANICAL CONTRACTOR IS RESPONSIBLE FOR ALL SLEEVES
- AND/OR OPENINGS WHERE REQUIRED TO RUN PIPES AND DUCTS THROUGH FOUNDATIONS, FLOOR SLABS, WALLS, BRIDGING AND BEAMS, EXCEPT WHERE OTHERWISE INDICATED. PENETRATION SEALANT RATING TO MATCH STRUCTURE RATING.
- 5. VERIFY ALL DUCT CONNECTION SIZES TO FANS AND COILS.
- 6. COOPERATE WITH THE OTHER TRADES TO ELIMINATE ANY CONFLICTS BETWEEN PIPING, DUCTWORK, STRUCTURAL, ELECTRICAL WORK, ETC. CONTRACTOR TO COORDINATE DUCTWORK WITH ALL TRADES AND DISCIPLINES TO ELIMINATE OBSTRUCTIONS (INCLUDING EXISTING CONDITIONS) TO ROUTING.
- DIFFUSER, REGISTER, AND SPRINKLER HEAD LOCATIONS SHALL BE COORDINATED WITH LIGHT FIXTURE LOCATIONS AND SHALL CORRESPOND WITH CEILING PATTERNS AS SHOWN ON ARCHITECTURAL REFLECTED CEILING PLANS.
- ALL SQUARE DIFFUSERS SHALL HAVE THE AIR VOLUME DIRECTED EQUALLY IN FOUR DIRECTIONS UNLESS INDICATED OTHERWISE.
- 9. ALL DUCT DIMENSIONS ARE CLEAR INSIDE DIMENSIONS.
- 10. IN GENERAL, PLUMBING, PIPING, AND DUCTWORK SYSTEMS ARE SHOWN IN SCHEMATIC FORM ONLY. CONTRACTOR SHALL PROVIDE OFFSETS AND TRANSITIONS TO FIT MECHANICAL SYSTEMS IN TO SPACE AVAILABLE.
- 11. COORDINATE INTERRUPTION OF BUILDING SERVICES WITH OWNERS REPRESENTATIVE.
- 12. CONTRACTOR SHALL USE ALUMINUM DUCTWORK FOR EXHAUST DUCTWORK IN SHOWER AREAS. EXTENT OF ALUMINUM DUCT SHALL BE FROM EXHAUST GRILLE SERVING SHOWER AREA TO THE MAIN TRUNK DUCT. DUCT SHALL BE SLOPED TOWARDS EXHAUST GRILLE.
- 13. CONTRACTOR TO VERIFY ADEQUATE RETURN AIR PATH IN ALL RETURN AIR PLENUMS.



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PROJECT:

Square velopment South Dako Site Dev

| REVISIONS | :   |   |         |
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| NO.       | ВУ  | DESCRIPTION                             | DATE    |
|           | REA | 50% CONSTRUCTION<br>DRAWINGS REVIEW SET | 6/23/10 |
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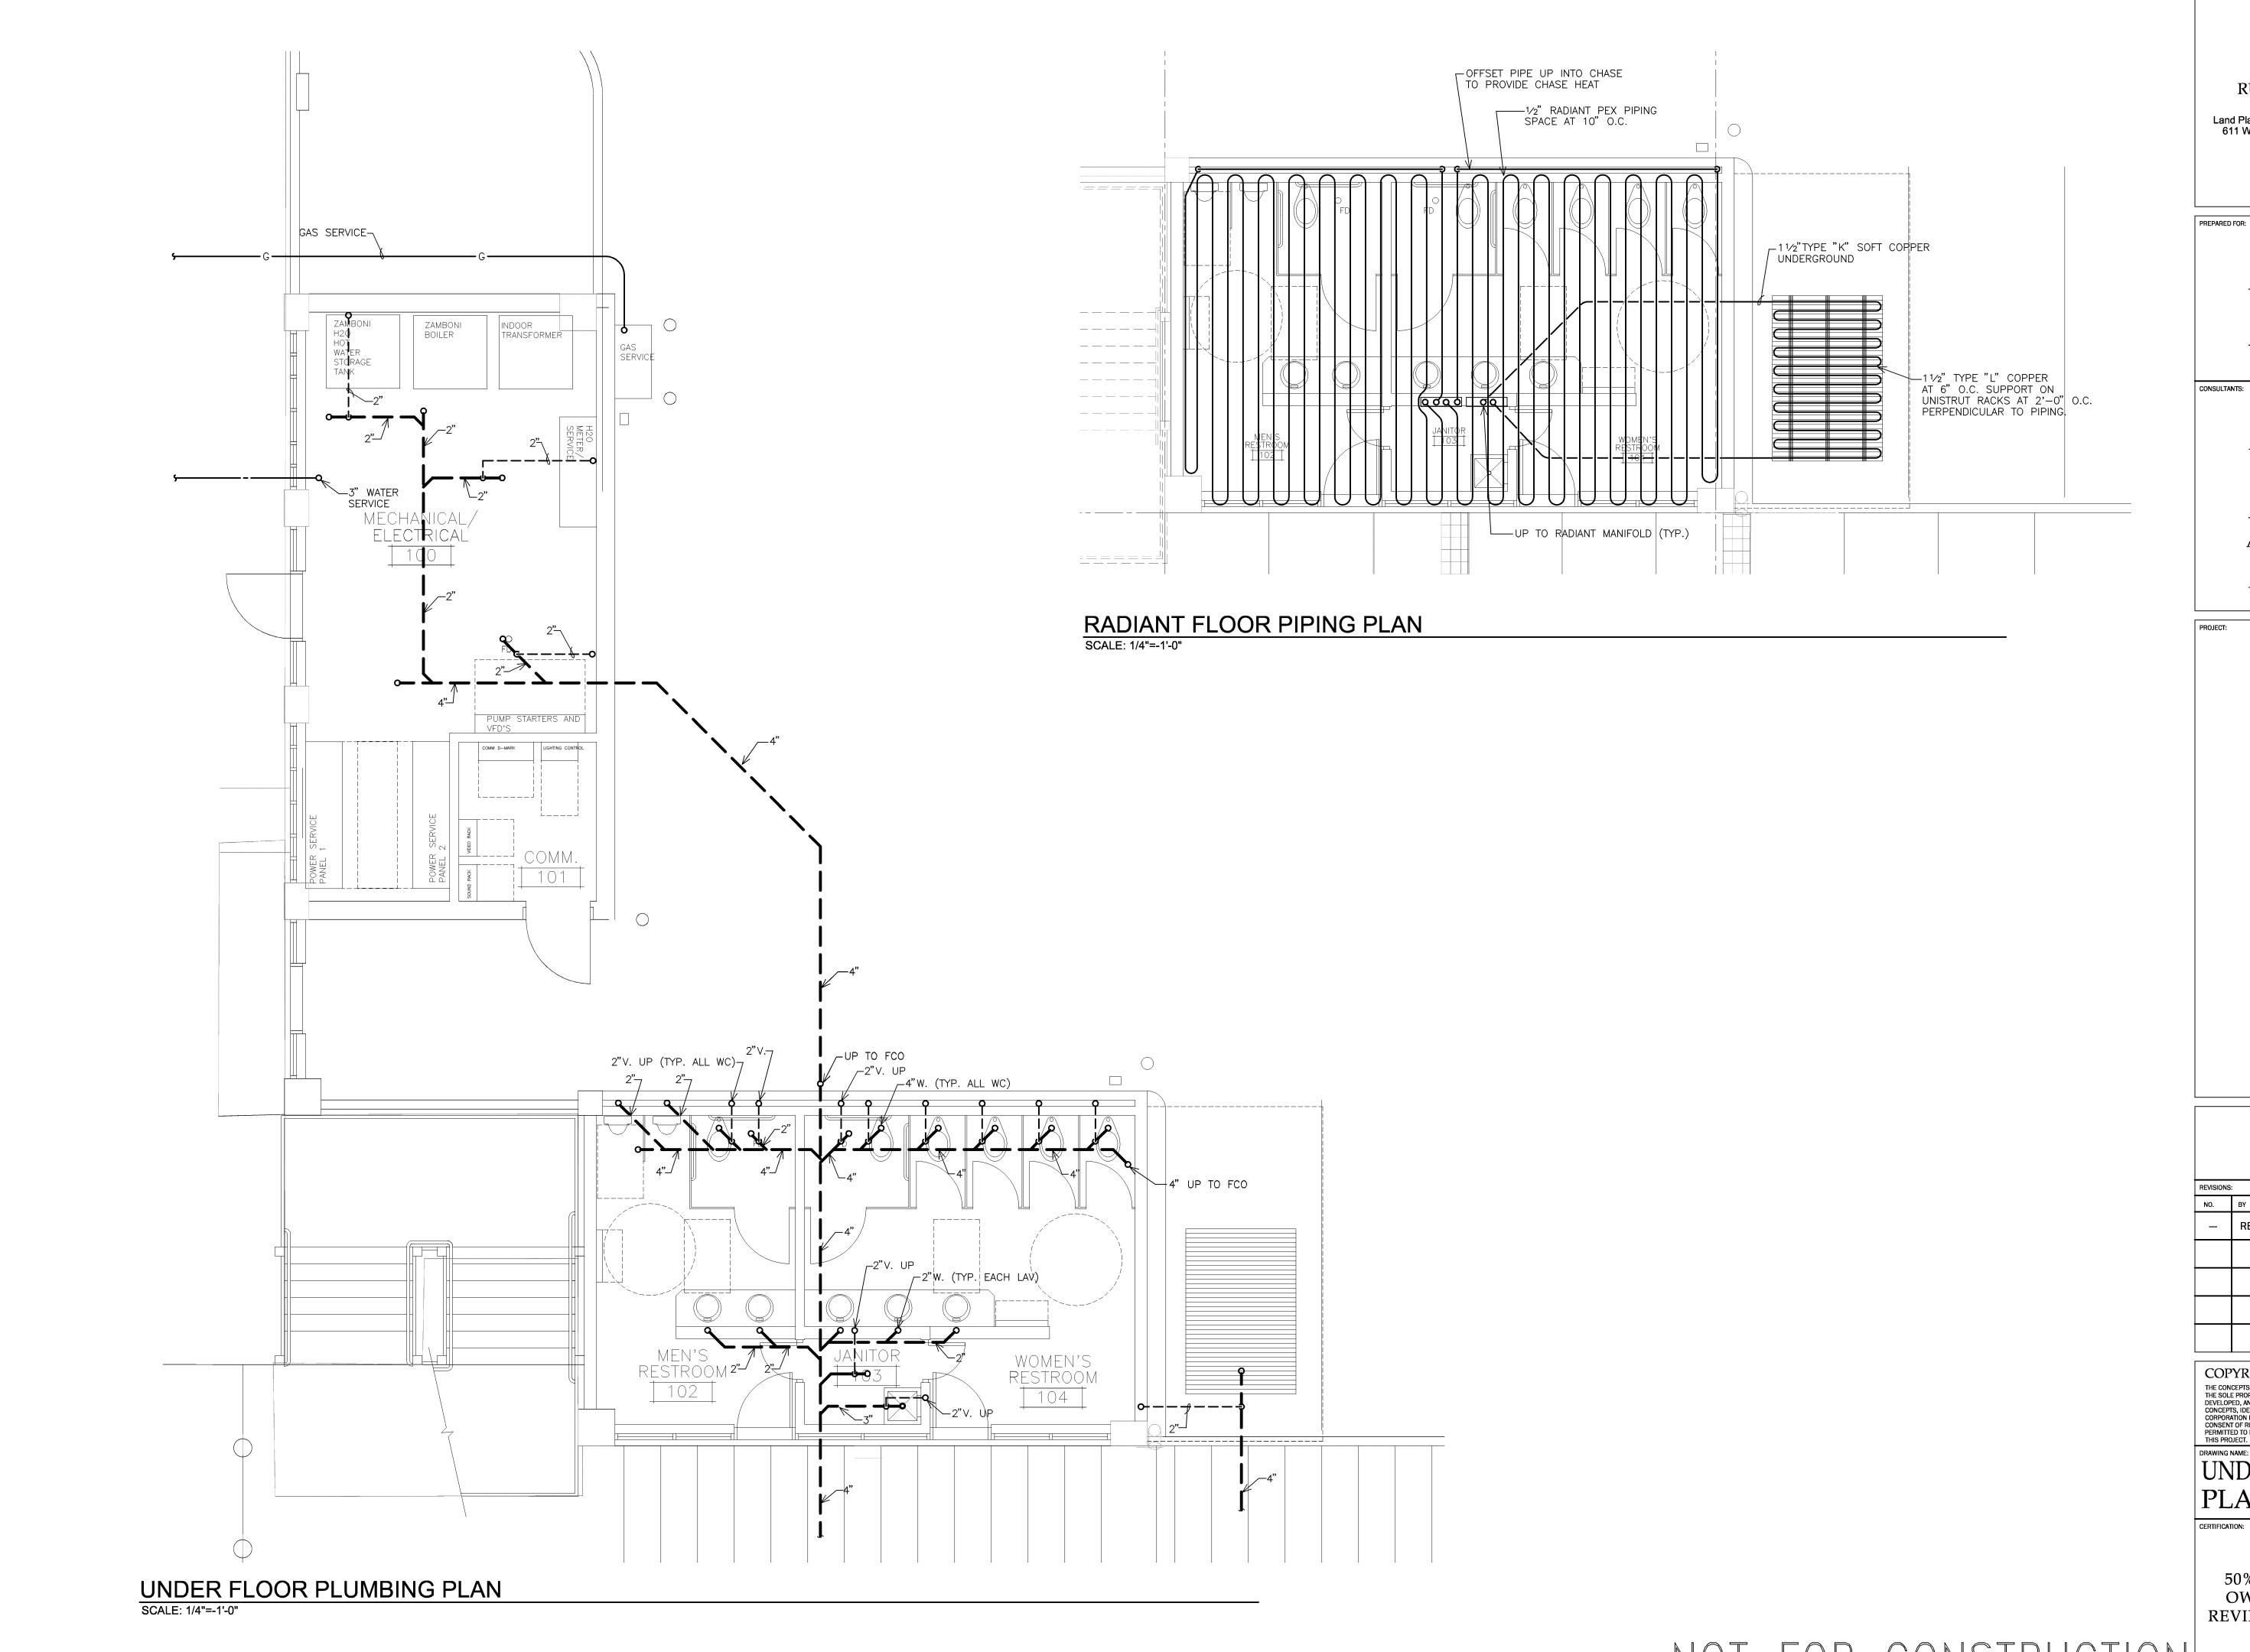
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#### MECHANICAL LEGEND SHEET INDEX

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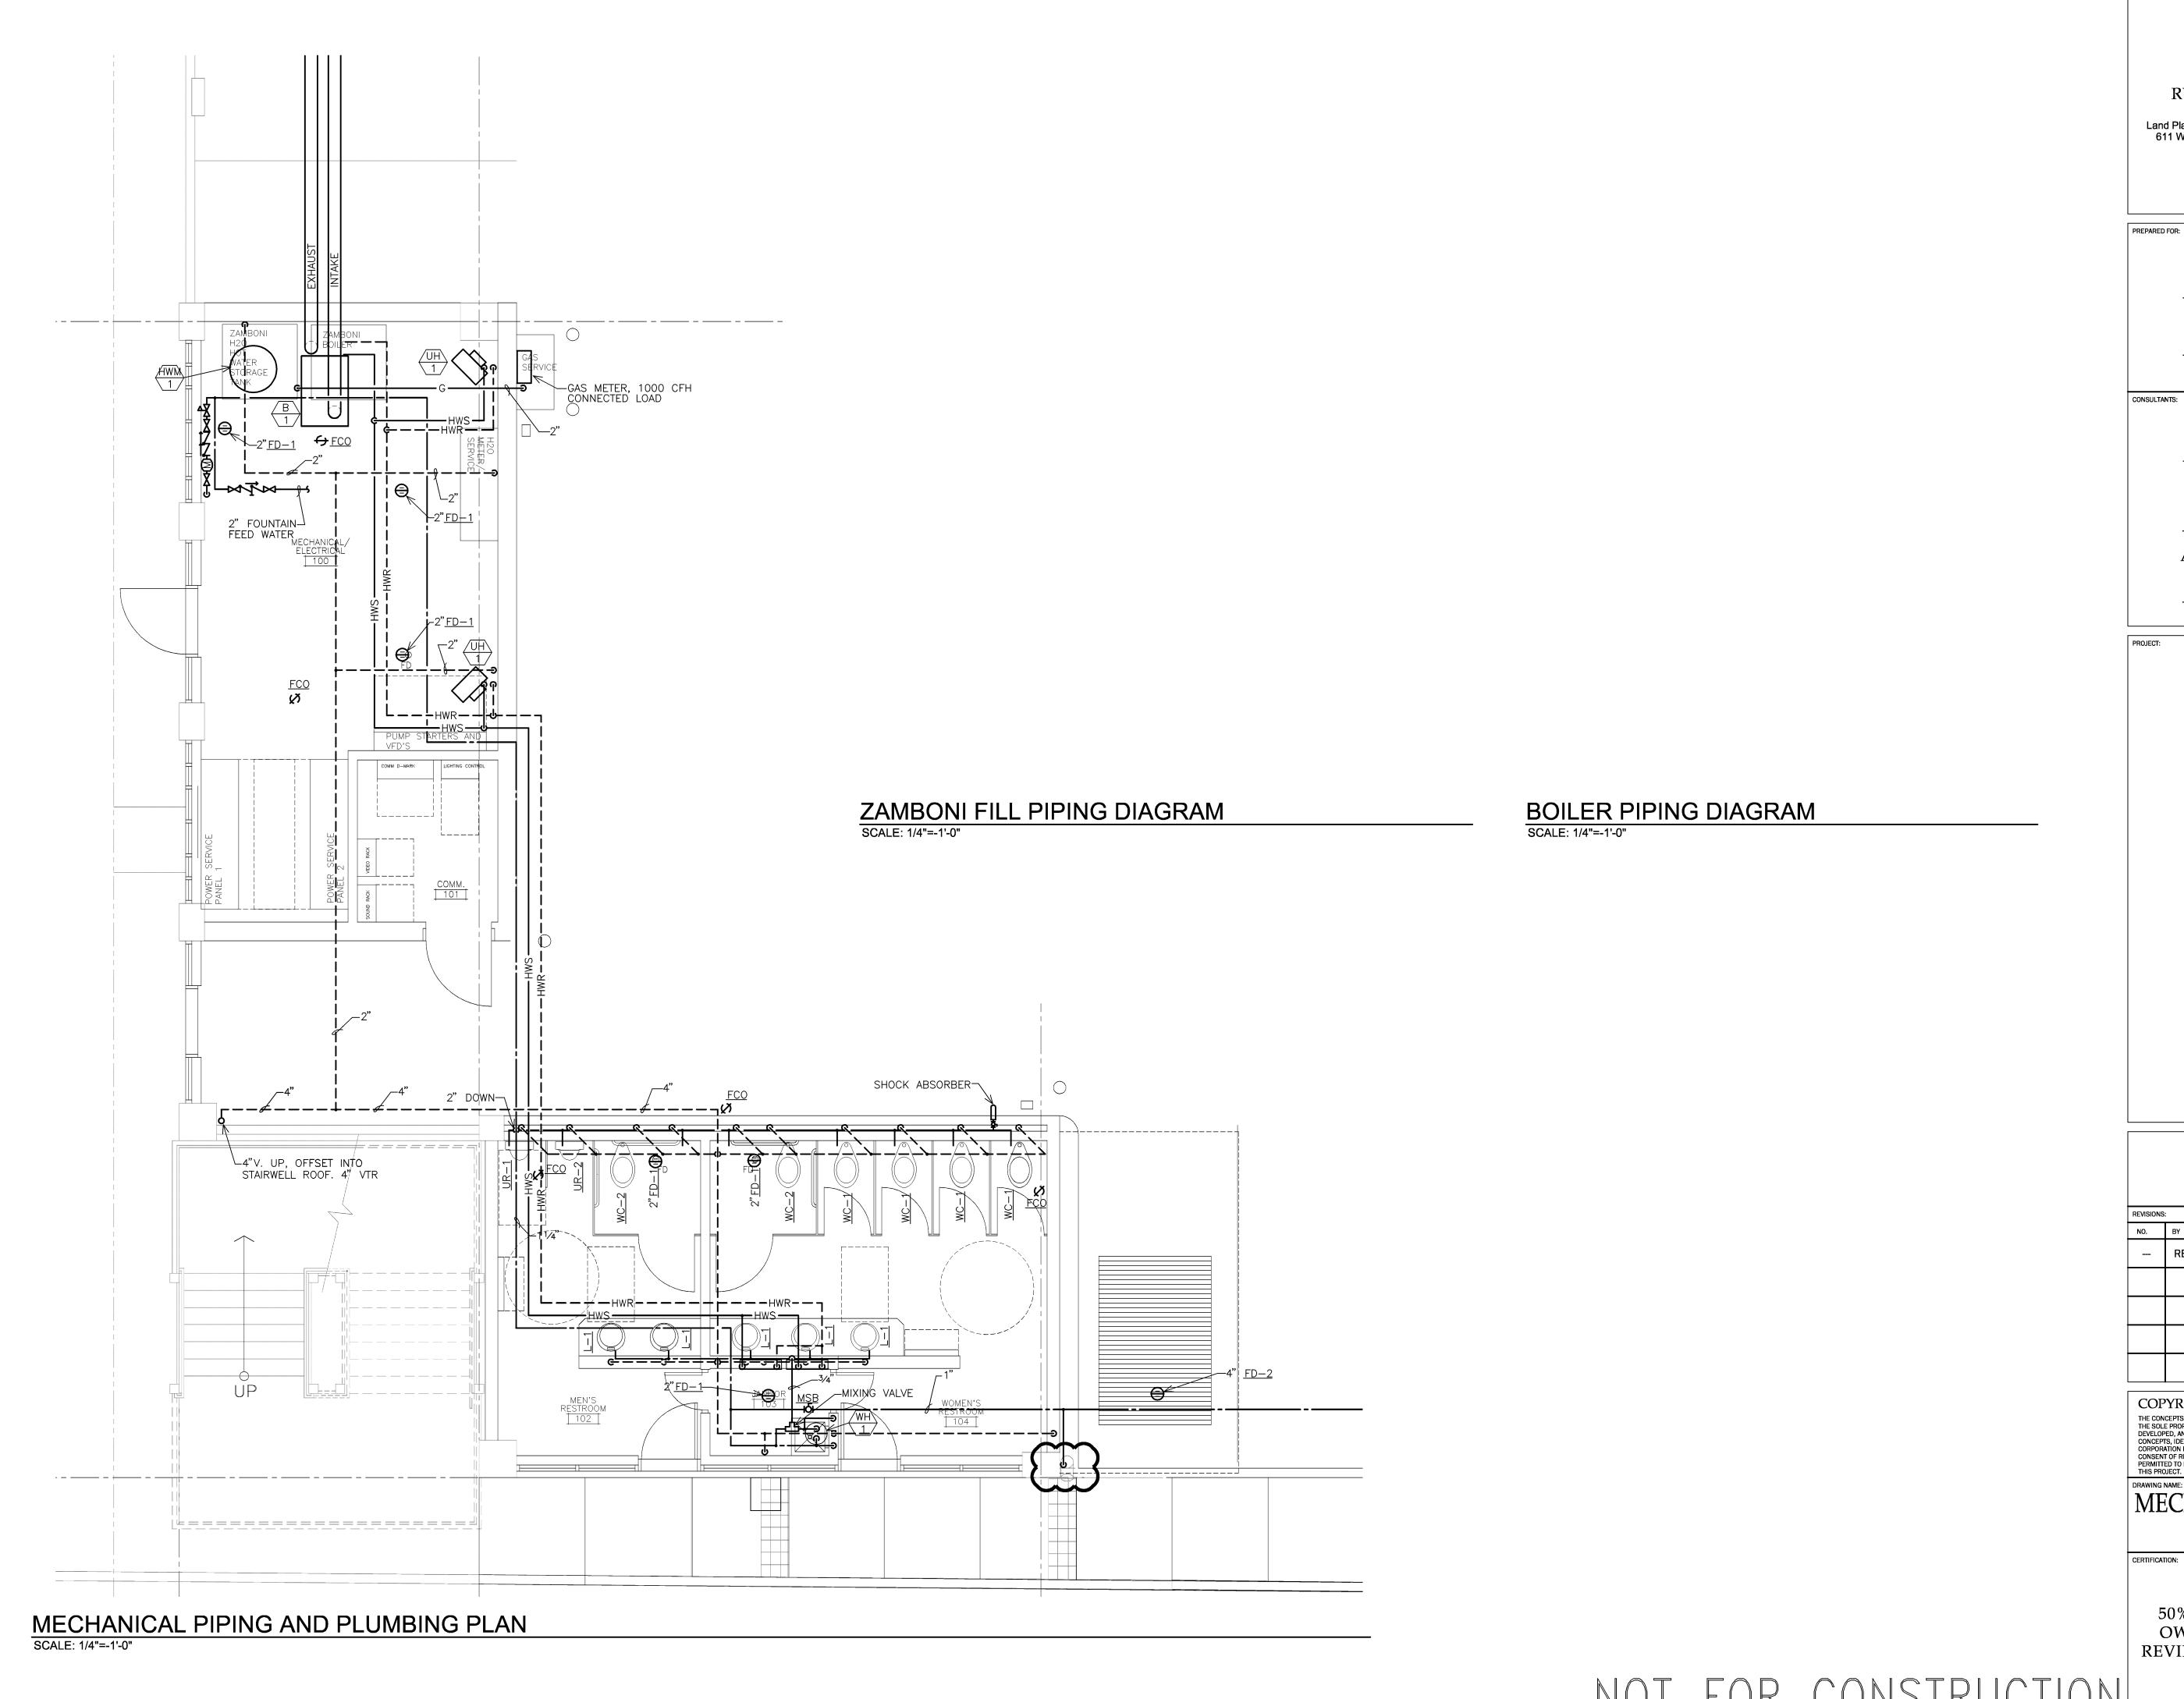
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UNDER FLOOR PLUMBING PLAN

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> Dakota Square Site Development pid City, South Dak

| REVISIONS | REVISIONS: |             |          |  |  |  |  |  |  |  |  |
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| NO.       | ВҮ         | DESCRIPTION | DATE     |  |  |  |  |  |  |  |  |
|           | REA        | 6/23/10     |          |  |  |  |  |  |  |  |  |
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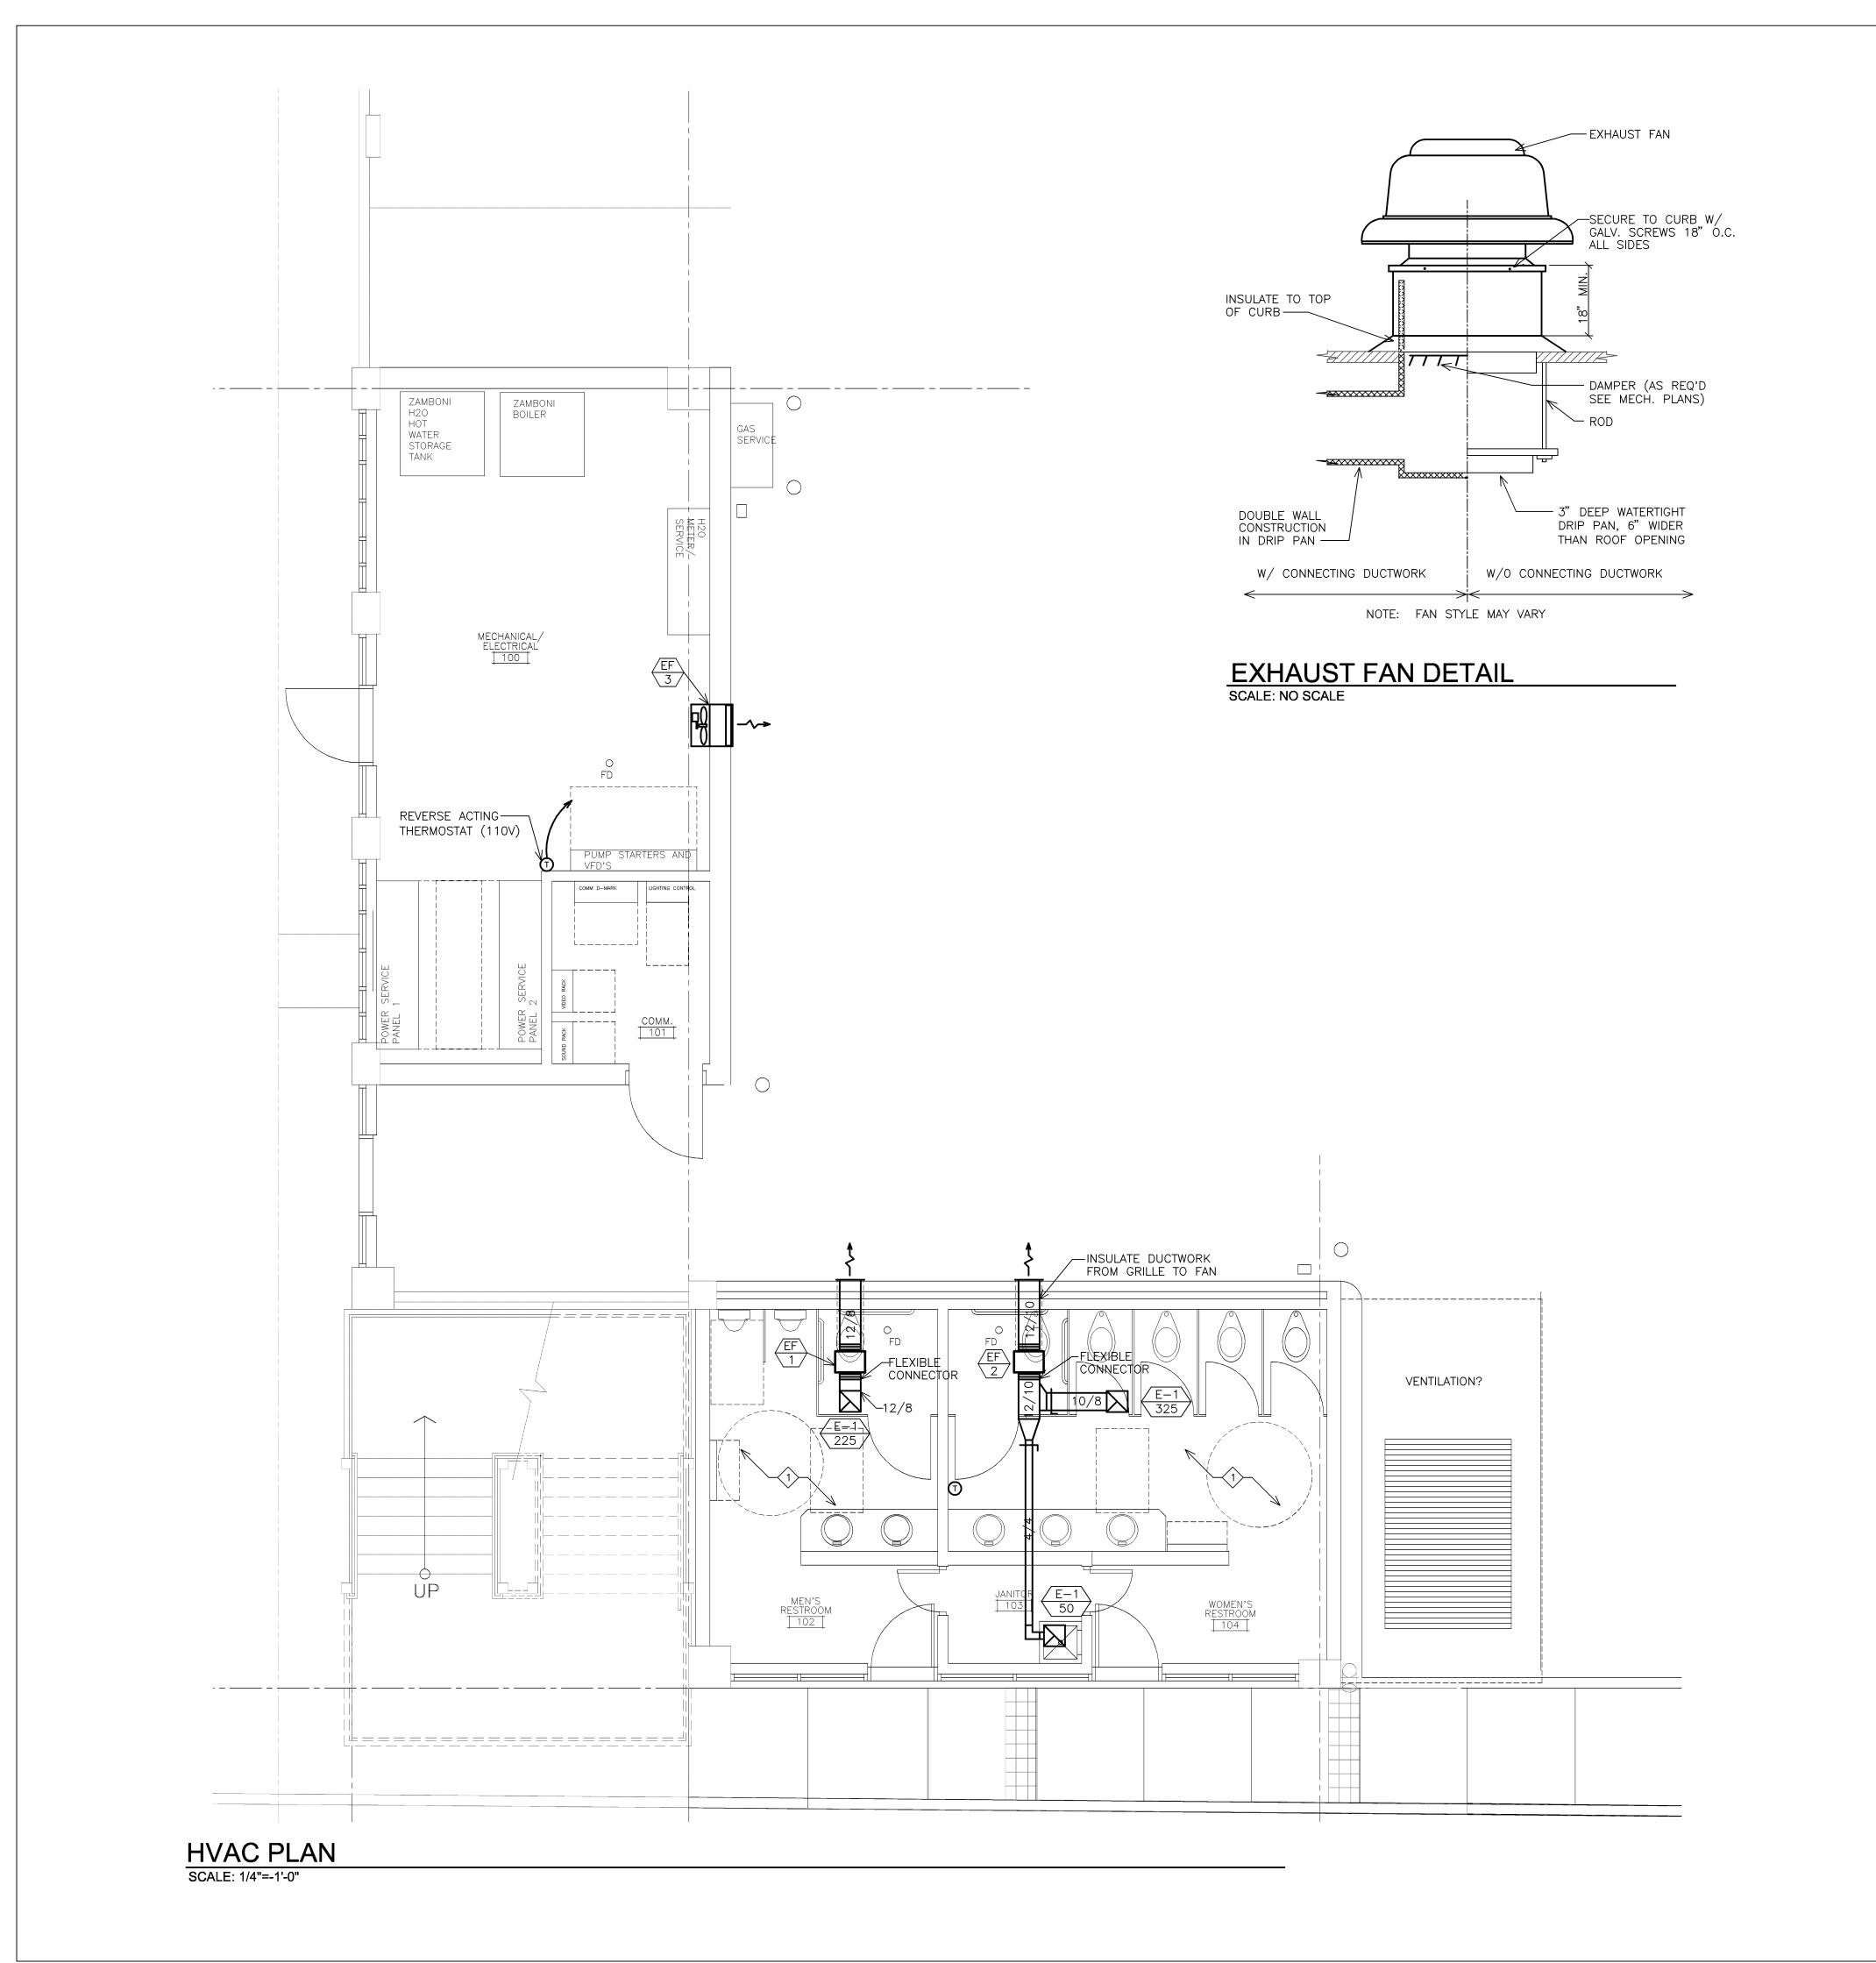
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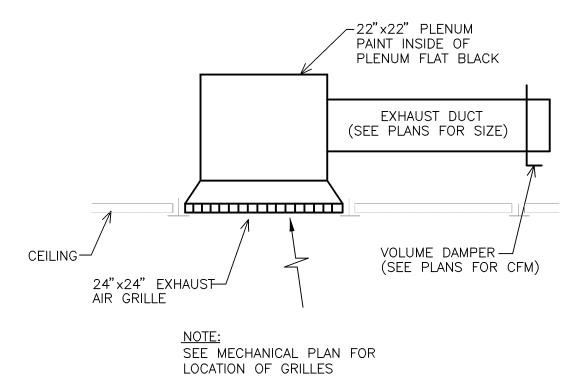
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#### MECHANICAL PIPING AND PLUMBING PLAN

50% CDs OWNER **REVIEW SET** 

Project No.: 091131 June 23, 2010 AGA Drawn by: Checked by: GJK M1-00.dwg





DUCT TO EXHAUST GRILLE CONNECTION DETAIL SCALE: NO SCALE



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Destination Rapid City 606 Main Street, Rapid City, SD 57701 TE [605] 716-7979 FX [605] 341-6415

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Square Site Development pid City, South Dak

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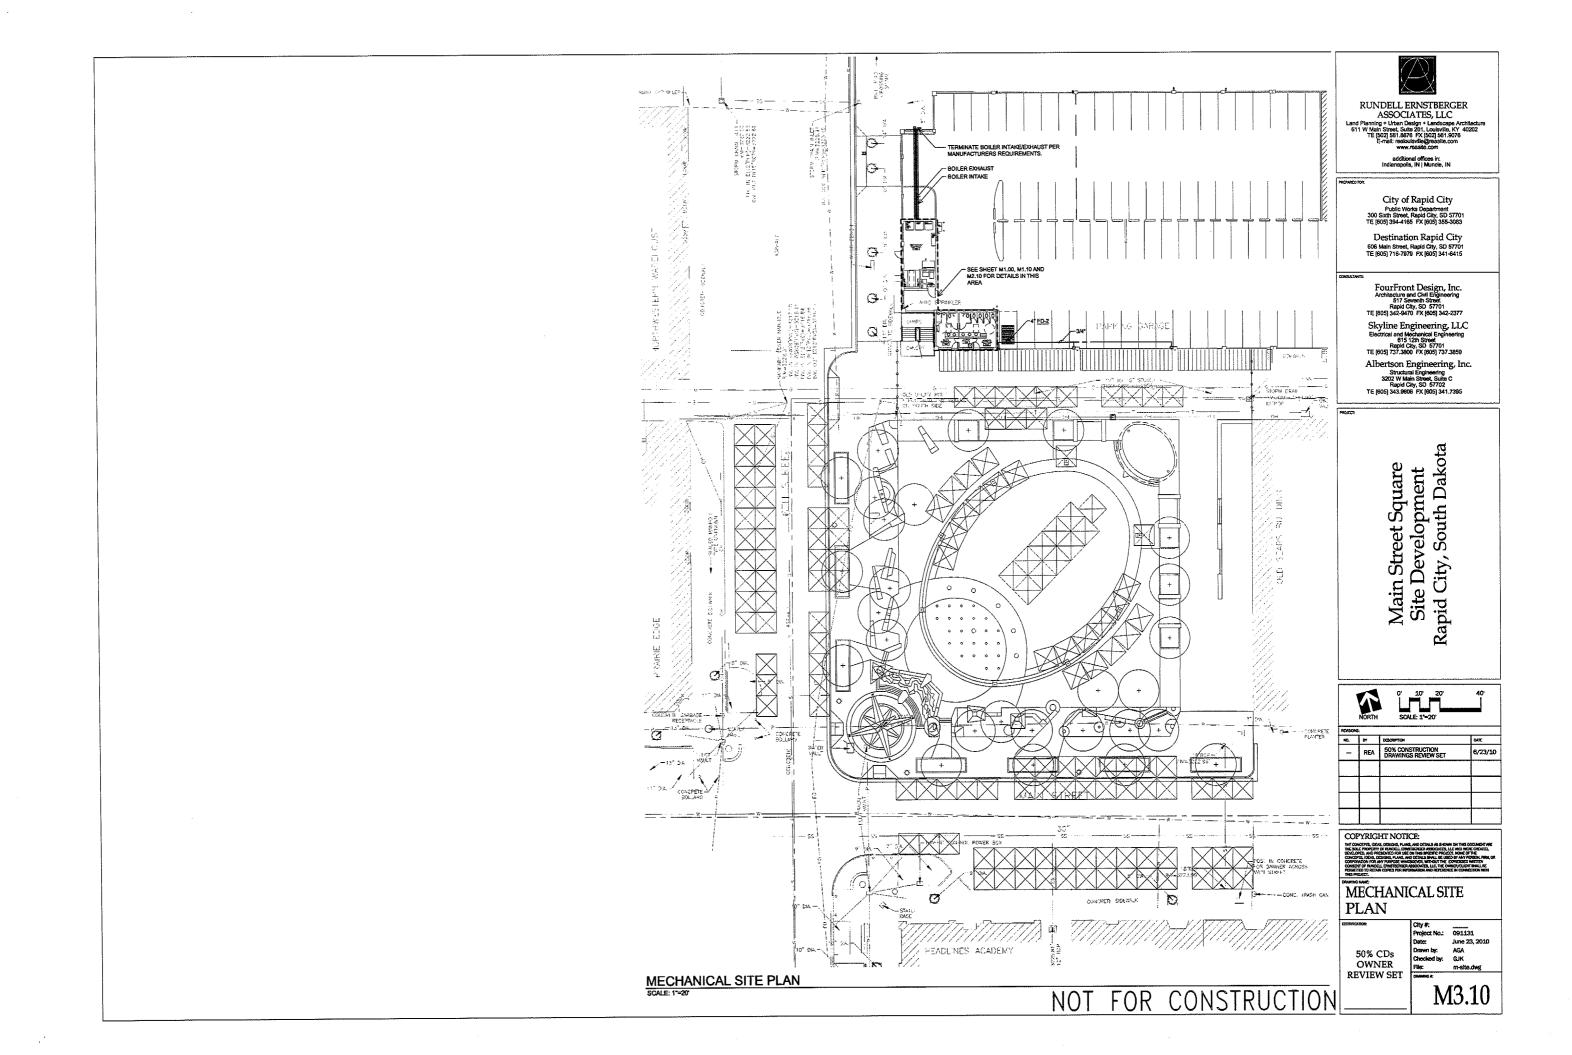
DRAWING NAME:
HVAC PLAN


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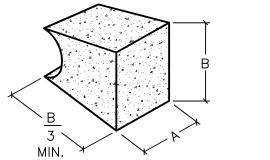
OWNER


Project No.: 091131 June 23, 2010 AGA Drawn by: Checked by: GJK M1-00.dwg **REVIEW SET** 

M2.10





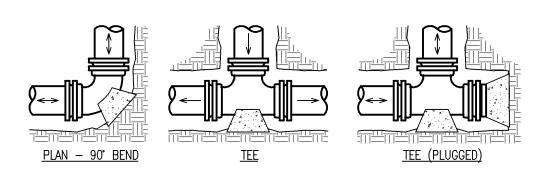

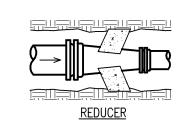


| THRUST BLOCKING DIMENSIONS |        |        |        |           |        |                       |       |               |  |  |
|----------------------------|--------|--------|--------|-----------|--------|-----------------------|-------|---------------|--|--|
| PIPE SIZE                  | TEES & | PLUGS  | 90° E  | 90° BENDS |        | 45° BENDS<br>AND WYES |       | ERS &<br>BEND |  |  |
|                            | A      | В      | Α      | В         | Α      | В                     | Α     | В             |  |  |
| 3" & 4"                    | 1'-10" | 1'-5"  | 1'-10" | 1'-6"     | 1'-8"  | 1'-0"                 | 1'-7" | 0'-6"         |  |  |
| 6"                         | 2'-3"  | 1'-11" | 2'-8"  | 2'-4"     | 2'-0"  | 1'-8"                 | 1'-9" | 1'-0"         |  |  |
| 8"                         | 3'-0"  | 2'-6"  | 3'-6"  | 3'-2"     | 2'-8"  | 2'-3"                 | 2'-0" | 1'-6"         |  |  |
| 10"                        | 3'-8"  | 3'-3"  | 4'-4"  | 4'-0"     | 3'-3"  | 2'-10"                | 2'-5" | 2'-0"         |  |  |
| 12"                        | 4'-3"  | 4'-0"  | 5'-1"  | 4'-10"    | 3'-10" | 3'-6"                 | 2'-9" | 2'-6"         |  |  |
|                            |        |        |        |           |        |                       |       |               |  |  |


#### NOTES:

- 1. THIS TABLE IS BASED ON 150 PSI MAIN PRESSURE AND 1500 PSF SOIL BEARING PRESSURE.
- 2. BEARING SURFACE SHALL BE UNDISTURBED SOIL OR COMPACTED TO AT LEAST 90% STANDARD PROCTOR DENSITY.


THRUST BLOCK DETAIL SCALE: NO SCALE

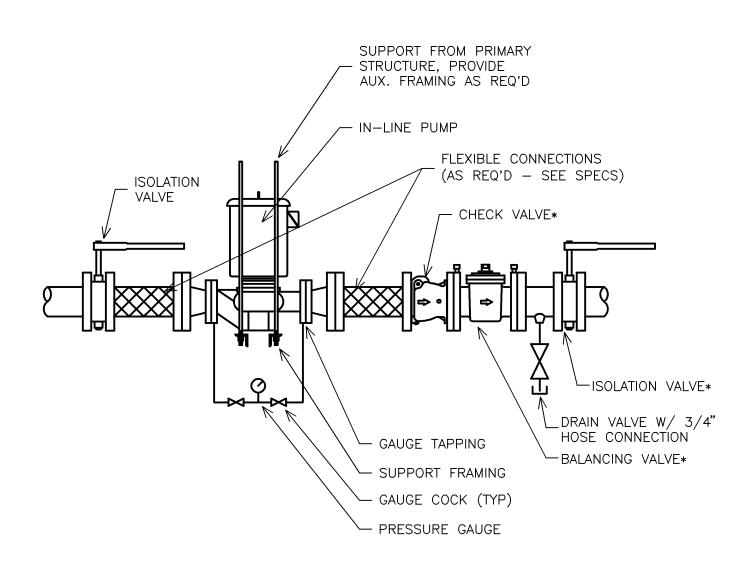


IN-LINE PUMP DETAIL SCALE: NO SCALE

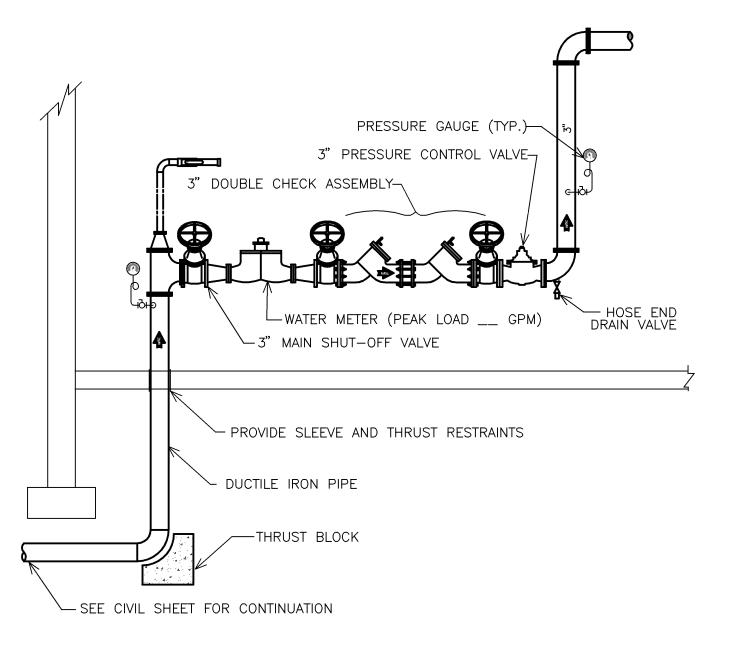

WATER SERVICE ENTRANCE DIAGRAM SCALE: NO SCALE

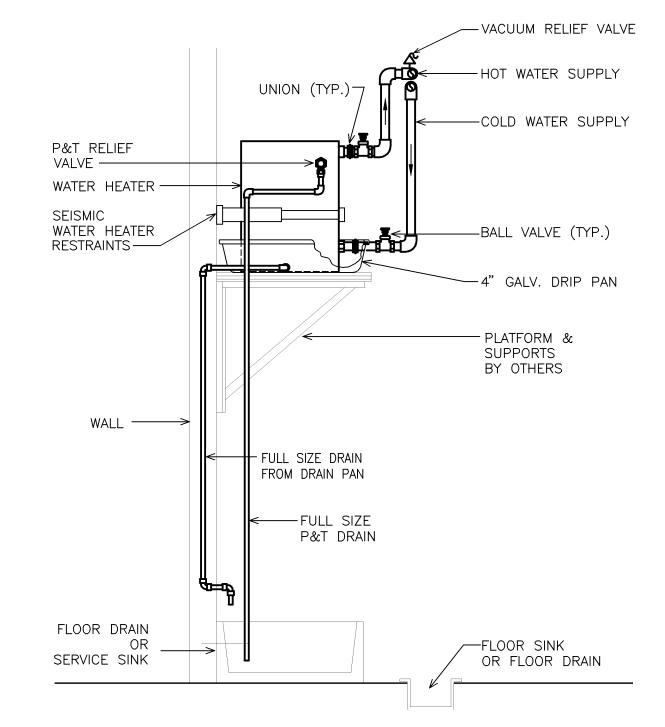

**ELECTRIC WATER HEATER DETAIL** SCALE: NO SCALE

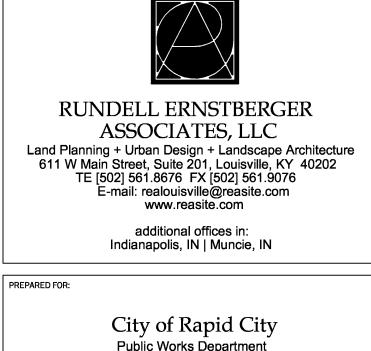

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Square Dak relopment Site Dev

| BY  | DESCRIPTION                             | DATE                             |
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| REA | 50% CONSTRUCTION<br>DRAWINGS REVIEW SET | 6/23,                            |
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MECHANICAL DETAILS AND PLUMBING RISERS

50% CDs OWNER **REVIEW SET** 

Project No.: 091131 June 23, 2010 AGA Drawn by: GJK Checked by: M4-00.dwg DRAWING #:

WATER RISER DIAGRAM SCALE: NO SCALE

WASTE RISER DIAGRAM SCALE: NO SCALE

MANIFOLD PIPING DIAGRAM SCALE: NO SCALE

| INDIR  | INDIRECT FIRED WATER HEATER SCHEDULE |                  |          |                         |                                 |                    |               |                |                            |        |           |       |
|--------|--------------------------------------|------------------|----------|-------------------------|---------------------------------|--------------------|---------------|----------------|----------------------------|--------|-----------|-------|
| EQUIP. | LOCATION                             | BOILER REQU      | IREMENTS |                         | PERFORMANCE                     | TANK SPECIFICATION |               |                | CATION                     | MANUF. | MODEL NO. | MECH. |
| NO.    |                                      | FLUID FLOW (GPM) | EWT LWT  | PWD CONN.<br>(PSI) (IN) | RECOVERY GPH<br>90 DEG. F. RISE |                    | CONN.<br>(IN) | TANK<br>VOLUME | MAX. WORKING<br>TEMP. (°F) |        |           | NOTES |
| HWM-1  | MECH. ROOM                           | 30% GLYCOL 18    | 180 150  |                         | 479                             |                    | _             | 120            | -                          | AMTROL | WHS-120ZC | _     |
|        |                                      |                  |          |                         |                                 |                    |               |                |                            |        |           |       |

#### MECH. NOTES:

| AIR SEI      | AIR SEPARATOR SCHEDULE |            |               |                    |                 |                      |                           |        |           |             |  |
|--------------|------------------------|------------|---------------|--------------------|-----------------|----------------------|---------------------------|--------|-----------|-------------|--|
| EQUIP<br>NO. | SERVICE                | LOCATION   | FLOW<br>(GPM) | MAX. FLOW<br>(GPM) | CONN. SIZE (IN) | PRESS. DROP<br>(PSI) | AIR REMOVAL<br>PERCENTAGE | MANUF. | MODEL NO. | MECH. NOTES |  |
| AS-1         | XXX<br>XXX             | XXX<br>XXX | XXX           | XXX                | XXX             | XXX                  | XXX                       | XXX    | XXX       | XXX         |  |

| EXPA          | NSION TAN | < SCHE | EDULE              |                    |  |                     |  |                      |                         |        |           |
|---------------|-----------|--------|--------------------|--------------------|--|---------------------|--|----------------------|-------------------------|--------|-----------|
| EQUIP.<br>NO. | TYPE      | FLUID  | MAX. TEMP.<br>(°F) | MIN. TEMP.<br>(°F) | STATIC FILL<br>PRESS. (PSI)<br>(AT 70°F) | MAX PRESS.<br>(PSI) | TANK DESIGN<br>PRESS. (PSI)<br>(ASME VIII) | SYSTEM<br>VOL. (GAL) | EXPANSION<br>VOL. (GAL) | MANUF. | MODEL NO. |
| ET-1          | XXX       | XXX    | XXX                | XXX                | XXX                                      | XXX                 | XXX  | XXX                  | XXX                     | XXX    | XXX       |

| FIXTURE<br>NO | TYPE  | WASTE<br>(IN) | TRAP<br>(IN) | VENT<br>(IN) | CW<br>(IN) | HW<br>(IN)       | TRIM                                     | MANUF.           | MODEL NO.                    | REMARKS   |
|---------------|---|---------------|--------------|--------------|------------|------------------|--|------------------|------------------------------|---|
| WC-1          | FLOOR MOUNTED BACK SPUD FLUSH VALVE STAINLESS STEEL WATER CLOSET                | 4"            |              | 2"           | 1"         |                  | ZURN<br>ZEMS6140AV *<br>W/ ZEMS6199-BX17 | ACORN            | 2120-W-3-ULF-<br>HS-OFLC     | PROVIDE BLACK OPEN FRONT SEAT   |
| WC-2          | (A.D.A.) FLOOR MOUNTED<br>BACK SPUD FLUSH VALVE<br>STAINLESS STEEL WATER CLOSET | 4"            |              | 2"           | 1"         |                  | ZURN<br>ZEMS6140AV *<br>W/ ZEMS6199-BX17 | ACORN            | 2120-W-3-ULF-<br>ADA-HS-OFLC | PROVIDE BLACK OPEN FRONT SEAT   |
| UR-1          | WALL MOUNTED<br>BACK SPUD FLUSH VALVE<br>STAINLESS STEEL URINAL                 | 2"            |              | 1-1/2"       | 3/4"       |                  | ZURN<br>ZEMS6140AV *<br>W/ ZEMS6199-BX17 | ACORN            | 2158-W-1                     | PROVIDE CARRIER   |
| UR-2          | (A.D.A.) WALL MOUNTED<br>BACK SPUD FLUSH VALVE<br>STAINLESS STEEL URINAL        | 2"            |              | 1-1/2"       | 3/4"       |                  | ZURN<br>ZEMS6140AV *<br>W/ ZEMS6199-BX17 | ACORN            | 2158-W-1                     | PROVIDE CARRIER, MOUNT URINAL PER ADA                                       |
| L-1           | LAVATORY — UNDERMOUNT<br>STAINLESS STEEL  | 1-1/2"        | 1-1/4"       | 1-1/2"       |            | 1/2"<br>TEMPERED | ZURN<br>ZEMS6140AV *<br>W/ ZEMS6199-BX17 | ELKAY            | 2158-W-1                     | PROVIDE SUPPLIES, STOPS, 17 GA. P-TRAF<br>AND TRUE-BRO HANDI LAV TRAP GUARD |
| MSB           | MOP SERVICE BASIN<br>MOLDED STONE/FIBERGLASS                                    | 3"            | 3"           | 1-1/2"       | 1/2"       | 1/2"             | MUSTEE<br>63.600A                        | MUSTEE           | 63M (24X24)                  | PROVIDE HOSE AND HOSE HOLDER, MOP HANGER, AND WALL GUARDS                   |
| DF            | FREEZELESS DRINKING<br>FOUNTAIN — STONE AGGREGATE                               | 1-1/2"        | 1-1/2"       | 1-1/2"       | 1/2"       |                  |  | HALSEY<br>TAYLOR | 4593FR                       | PROVIDE HANGER AND FREEZE RESISTANT VALVE PACKAGE                           |
| НВ            | HOSE BIB  |               |              |              | 3/4"       |                  |  | ZURN             |                              |   |
| WH-1          | WALL HYDRANT  |               |              |              | 3/4"       |                  |  | WOODFORD         |                              |   |
| WH-2          | FREEZELESS WALL HYDRANT   |               |              |              | 3/4"       |                  |  | WOODFORD         |                              |   |
| FD-1          | FLOOR DRAIN   | 2"            | 2"           | 2"           |            |                  |  | ZURN             |                              |   |
| FD-2          | ZAMBONI PIT FLOOR DRAIN WITH<br>STAND PIPE                                      | 4"            | 4"           | 2"           |            |                  |  | ZURN             |                              | <br>  |

\* PROVIDE LOW VOLTAGE TRANSFORMER.

| DIFFU         | JSER, RE | GISTER, AND GRI | LLE SCHEDULE |                      |                       |       |               |        |        |       |             |             |
|---------------|----------|-----------------|--------------|----------------------|-----------------------|-------|---------------|--------|--------|-------|-------------|-------------|
| EQUIP.<br>NO. | SERVICE  | TYPE            | MOUNTING     | NECK<br>SIZE<br>(IN) | PANEL<br>SIZE<br>(IN) | MAT'L | FLOW<br>(CFM) | FINISH | MANUF. | MODEL | ACCESSORIES | MECH. NOTES |
| E-1           | EXHAUST  |                 |              |                      | 24"×24"               | STEEL | SEE DWGS      | WHITE  |        |       |             |             |

- -PROVIDE ALL TRANSITIONS (SUCH AS SQUARE-TO-ROUND), AS REQUIRED FOR A COMPLETE INSTALLATION. -PROVIDE BALANCE DAMPERS ON ALL DUCT MOUNTED GRILLES AND REGISTERS.
- -COORDINATE REQUIRED FRAME TYPES WITH THE ARCHITECTURAL REFLECTED CEILING PLANS.
- -ADJUST DIFFUSER PATTERN AS SHOWN ON DRAWINGS. WHERE NOT INDICATED, ADJUST TO FULLY DIFFUSE AIR OVER ENTIRE FLOOR AREA SERVED.

#### MECH. NOTES:

- PROVIDE NECK-MOUNTED BALANCING DAMPER.
   PROVIDE EQUALIZING GRID.
- 3. ---

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Main Street کہاسے Site Development مسنط City, South Dakota

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| NO.       | BY  | DESCRIPTION                             | DATE   |
|           | REA | 50% CONSTRUCTION<br>DRAWINGS REVIEW SET | 6/23/: |
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DRAWING NAME: MECHANICAL SCHEDULES

50% CDs OWNER **REVIEW SET** 

Project No.: 091131 June 23, 2010 AGA Drawn by: Checked by: GJK M5-00.dwg DRAWING #:

| BOIL         | ER SCHE           | EDULE                  |                              |                               |--------------|-------------------|------------------------|------------------------------|-------------------------------|-----------------------|----------------------|-----------------------|----------------------------------|----------------------|----------------------------|--------------------|---------------------------|--------------------------------|-------------------------|--------------|-----------|----------------|------------|---------|----------|---|---|-------------------|----------------|-----------|----------------|----|-------------------------|-----------------|
| GENEF        | AL                |                        | MECHANICA                    | L                             |                       |                      |                       |                                  |                      |                            |                    |                           |                                |                         |              |           |                | ELECTRICAL | _       |          |   |   |                   |                |           |                |    | •                       |                 |
| EQUIP<br>NO. | LOCATION          | SERVICE<br>DESCRIPTION | TYPE                         | WORKING<br>PRESS (PSI)<br>MAX | GROSS<br>INPUT<br>MBH | NET<br>OUTPUT<br>MBH | TURN<br>DOWN<br>RATIO | FLUE I<br>SIZE C<br>(IN DIA) (IN | INLET CONN. (IN DIA) | OUTLET<br>CONN.<br>IN DIA) | DRAIN<br>IN DIA) - | FU<br>TYPE INLET<br>CONN. | JEL<br>INLET PF<br>(IN.<br>MAX | RESSURE<br>W.C.)<br>MIN | MANUFACTURER | MODEL NO. | MECH.<br>NOTES |            | CA/ VOI | LTS PHAS |   |   | FARTER<br>SIZE BY | MO<br>LOCATION | TOR DISCO | ONNECT<br>SIZE | BY | POWER BY E.C.<br>FEEDER | CIRCUIT # ELEC. |
| B-1          | MECH. ROOM<br>100 | ZAMBONI/<br>HEAT       | GAS FIRE HI-EF.<br>CAST IRON | 100                           | 1000                  | 880                  | 5:1                   | 6"                               | 3"                   | 3"                         | *                  | NG 2"                     | *                              | *                       | HYDROTHERM   | KN-10     | *              | 8 AMPS     | * 12    | 20 1     | * | * | * *               | *              | *         | *              | *  | *                       | * *             |

FLEC. NOTES:

| PUM   | SCHEDU   | LE          |        |       ,              |
|-------|----------|-------------|--------|-------|-----------------|-----|-----------|--------------|----------|----------------|-------|-------|-------|-------|----------|------|---------|------|----------|------|-------|----|---------------|-----------|----------------|
| GENEF | RAL      |             | MECHAN | ICAL  |                 |     |           |              |          |                | ELECT | RICAL |       |       |          |      |         |      |          |      |       |    |               |           |                |
| EQUIP | LOCATION | APPLICATION | TYPE   |       | TOTAL DISCHARGE |     |           | MANUFACTURER | MODEL NO | MECH.<br>NOTES | HP OR | MCA/  | VOLTS | PHASE |          |      | STARTER |      |          |      | CONNE |    | POWER BY E.C. |           | ELEC.<br>NOTES |
| NO.   |          |             |        | (GPM) | HEAD (FT)       | RPM | SIZE (IN) |              |          | NOTES          | LOAD  | MOCP  |       |       | LOCATION | TYPE | SIZE    | BY I | LOCATION | TYPE | SIZE  | BY | FEEDER        | CIRCUIT # | NOTES          |
| Х     | X        | X           | Х      | X     | X               | Х   | Х         | X            | X        | X              |       |       |       |       |          |      |         |      |          |      |       |    |               |           |                |
| Х     | X        | X           | Х      | X     | X               | Х   | Х         | X            | X        | X              | *     | *     | *     | *     | *        | *    | *       | *    | *        | *    | *     | *  | *             | *         | *              |
| Х     | X        | X           | X      | X     | X               | ×   | X         | X            | X        | X              |       |       |       |       |          |      |         |      |          |      |       |    |               |           |                |
|       |          
ELEC. NOTES:

| WATER         | R HEATER          | R SCHEDUL          | .E                  |                 |                  |                    |              |           |                |               |              |             |                   |         |                    |   |         |                |    |                         |           |                |
|---------------|-------------------|--------------------|---------------------|-----------------|------------------|--------------------|--------------|-----------|----------------|---------------|--------------|-------------|-------------------|---------|--------------------|---|---------|----------------|----|-------------------------|-----------|----------------|
| GENERA        | \L                |                    | MECHANICA           | \L              |                  |                    |              |           |                | ELECT         | RICAL        |             |                   |         |                    |   |         |                |    |                         |           |                |
| EQUIP.<br>NO. | LOCATION          | APPLICATION        | STORAGE<br>CAPACITY | GPH<br>RECOVERY | TEMP<br>RISE (F) | NO. OF<br>ELEMENTS | MANUFACTURER | MODEL NO. | MECH.<br>NOTES | HP OR<br>LOAD | MCA/<br>MOCP | VOLTS PHASE | CONTR<br>LOCATION | OLLER / | STARTER<br>SIZE BY |   | OR DISC | ONNECT<br>SIZE | BY | POWER BY E.C.<br>FEEDER | CIRCUIT # | ELEC.<br>NOTES |
| WH            | JANITOR<br>CLOSET | LAVATORY<br>DOM HW | 15                  | 23              | 80               | 1                  | A.O. SMITH   | DEL-15    | *              | 4.5 KW        | *            | 208 1       | *                 | *       | * *                | * | *       | *              | *  | *                       | *         | *              |

MECH. NOTES:

| UNIT H        | HEATER SC    | CHEDULE          |            |                  |---------------|--------------|------------------|------------|------------------|------|------------------------|--------------------------------|--------------|--------------|-----------|----------------|---------------|-------|-------|--------------------|-----------|-----------------|----|----------------------------|------------------|-------------------------|-----------|------------------|
| GENERAL       | •            |                  | MECHAN     | IICAL            |      |                        |                                |              |              |           |                | ELECTF        | RICAL |       |                    |           |                 |    |                            |                  |                         |           |                  |
| EQUIP.<br>NO. | LOCATION     | APPLICATION      | TYPE       | AIRFLOW<br>(CFM) | МВН  | HOT V<br>FLOW<br>(GPM) | VATER DATA  AVG WPD  TEMP (FT) | MOTOR<br>RPM | MANUFACTURER | MODEL NO. | MECH.<br>NOTES | HP OR<br>LOAD | VOLTS | PHASE | CONTRI<br>LOCATION | OLLER / S | STARTER<br>SIZE | BY | MOTOR DIS<br>LOCATION TYPE | SCONNECT SIZE BY | POWER BY E.C.<br>FEEDER | CIRCUIT # | ELEC.<br># NOTES |
| UH-1          | SEE<br>PLANS | SPACE<br>HEATING | HORIZONTAL | 630              | 33.0 |                        | 165 0.8                        | 1550         | MCQUAY       | UH-33     | 1              | 1/12          | 120   | 1     | AT UNIT            | TSTAT A   | AS REQ'D        | TC | AT UNIT MRT                | 20/1 MC          | :                       |           |                  |

MECH. NOTES:

1. PROVIDE WITH HANGER SUPPORT AND NEOPRENE VIBRATION ISOLATION PADS.

MECH. NOTES:

MECH. NOTES:

FLEC. NOTES:

1. E.C. TO COORDINATE CONTROLS CONDUIT AND BACKBOXES

| EXHA          | UST FAN             | SCHEDU             | LE                |                |                 |              |           |                |               |              |            |                 |                  |                   |    |         |        |                              |      |                         |           |                |
|---------------|---------------------|--------------------|-------------------|----------------|-----------------|--------------|-----------|----------------|---------------|--------------|------------|-----------------|------------------|-------------------|----|---------|--------|------------------------------|------|-------------------------|-----------|----------------|
| GENER         | AL                  |                    | MECHA             | ANICAL         |                 |              |           |                | ELECT         | RICAL        |            |                 |                  |                   |    |         |        |                              |      |                         |           |                |
| EQUIP.<br>NO. | LOCATION            | APPLICATION        | TYPE              | AIRFLOW<br>CFM | EXT.<br>SP (IN) | MANUFACTURER | MODEL NO. | MECH.<br>NOTES | HP OR<br>LOAD | MCA/<br>MOCP | VOLTS PHAS | E CO<br>LOCATIO | NTROLLER ON TYPE | / STARTER<br>SIZE | BY |         | OR DIS | SCONNEC <sup>-</sup><br>SIZE | T BY | POWER BY E.C.<br>FEEDER | CIRCUIT # | ELEC.<br>NOTES |
| EF-1          | MEN'S<br>RESTROOM   | GENERAL<br>EXHAUST | IN-LINE<br>BLOWER | 225            | 0.25            | соок         | GN-520    | 1              | 171W          | *            | 120 1      | AT UNI          | OS POWER         | R AS REQ'D        | EC | AT UNIT | MRT    | 20/1                         | EC   |                         | SEE PLAN  | 1              |
| EF-2          | WOMEN'S<br>RESTROOM | GENERAL<br>EXHAUST | IN-LINE<br>BLOWER | 375            | 0.25            | соок         | GN-520    | 1              | 171W          | *            | 120 1      | AT UNI          | OS POWER<br>PACK | R AS REQ'D        | EC | AT UNIT | MRT    | 20/1                         | EC   |                         | SEE PLAN  | 1              |
| EF-3          | MECH.<br>ROOM       | GENERAL<br>EXHAUST | SIDEWALL<br>PROP  |                | 0.25            | СООК         |           |                |               | *            | 120 1      | AT UNI          | OS POWER         | R AS REQ'D        | EC | AT UNIT | MRT    | 20/1                         | EC   |                         | SEE PLAN  | 1              |

MECH. NOTES:

1. PROVIDE WITH FAN SPEED CONTROLLER. FAN TO BE CONTROLLED BY RESTROOM OCCUPANCY SENSOR. ONCE EITHER RESTROOMS OCCUPANCY SENSOR DETECTS OCCUPANTS FAN SHALL START.

ELEC. NOTES:

1. SEE MECHANICAL NOTES FOR CONTROLS COORDINATION.

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PROJECT:

Main Street Square Site Development Rapid City, South Dakota

| DE #OLONG |     |   |         |
|-----------|-----|---|---------|
| NO.       | ву  | DESCRIPTION                             | DATE    |
|           | REA | 50% CONSTRUCTION<br>DRAWINGS REVIEW SET | 6/23/10 |
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SCHEDULES

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50% CDs OWNER REVIEW SET

Project No.: 091131
Date: June 23, 2010
Drawn by: AGA
Checked by: GJK
File: ME1.0.dwg

ME1.0

NOT FOR CONSTRUCTION \_\_\_\_