




SITE PLAN DATE: 10/8/09 DN BY: RJT CK BY: RS REVS: PROJECT NUMBER: SCALE: SHEET:

0.1

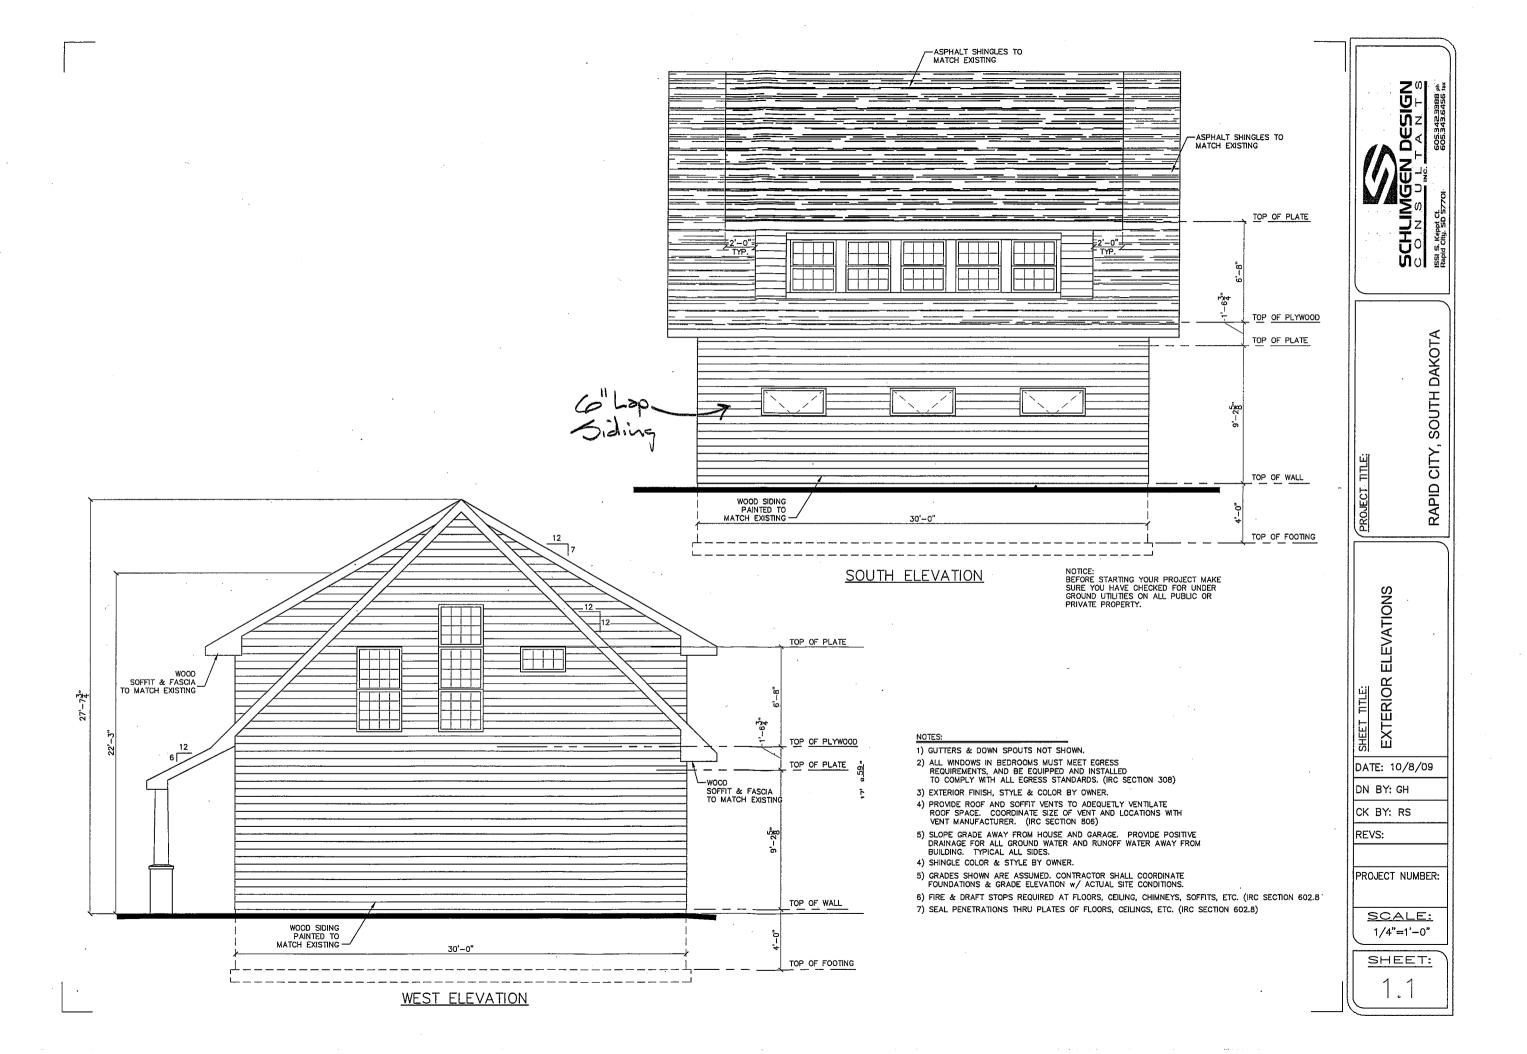

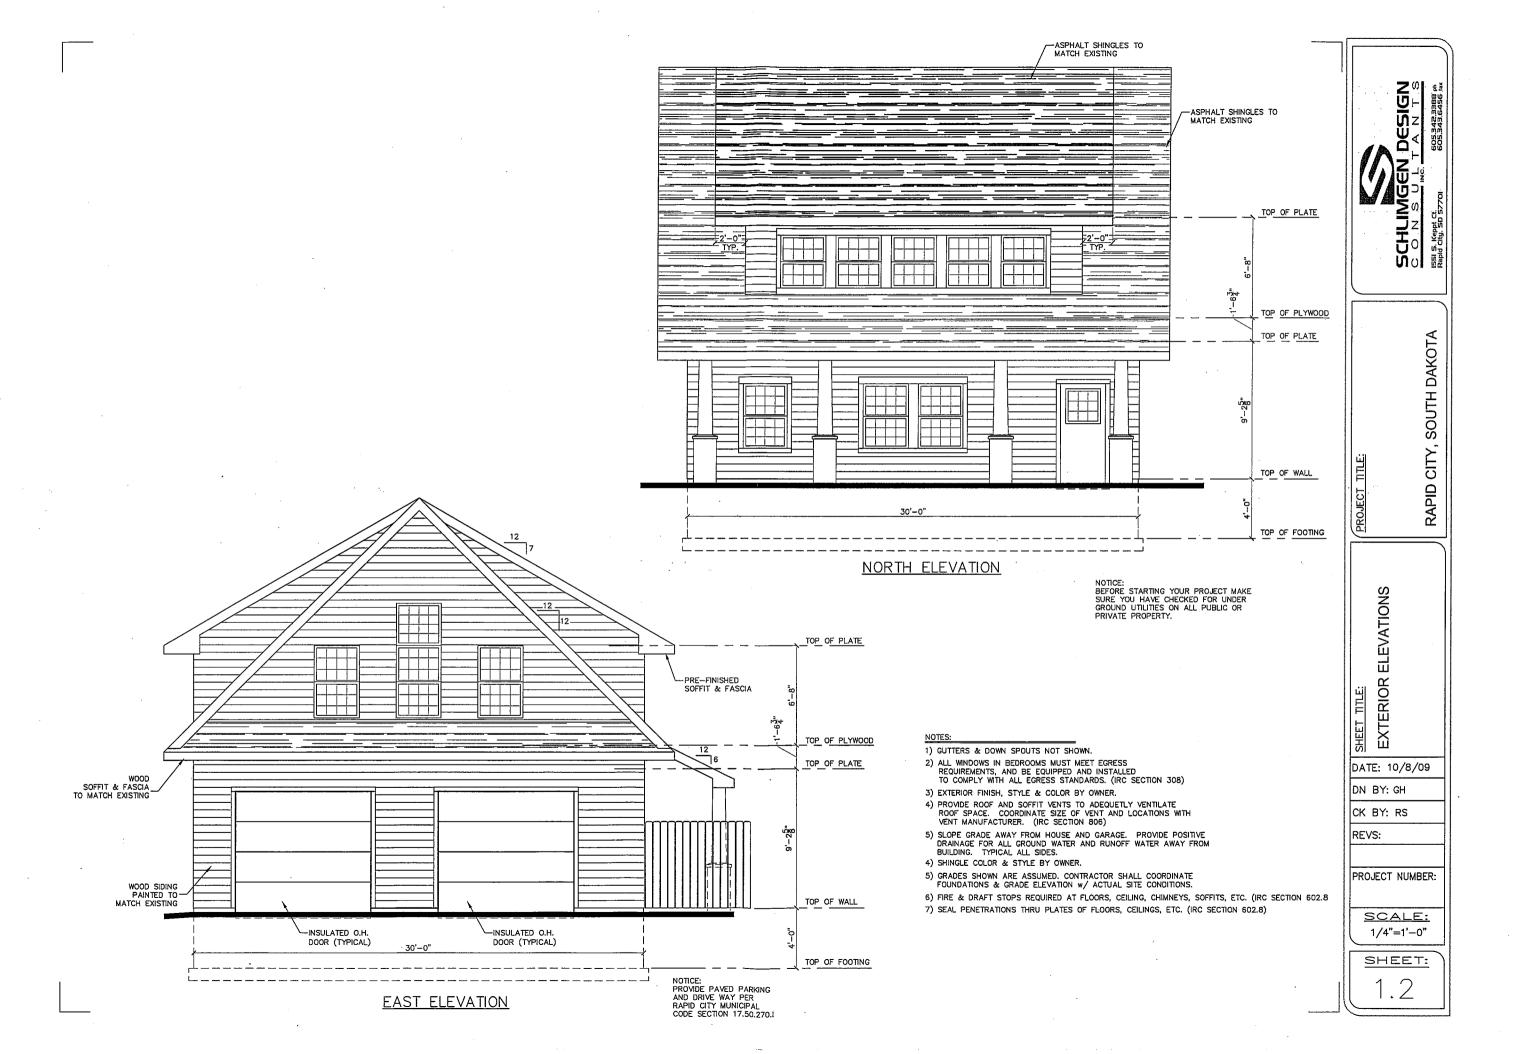

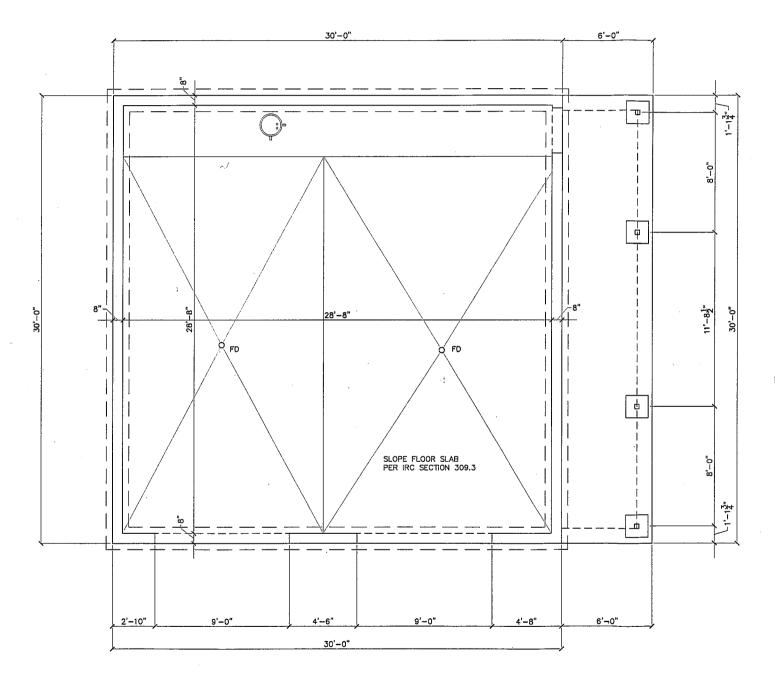

MINIMUM SUGGESTED FOUNDATION ANCHORAGE:

MINIMUM SUGGESTED FOUNDATION ANCHORAGE:

TREATED WOOD SILL PLATES SHALL BE ANCHORED TO THE FOUNDATION WITH ANCHOR BOLTS SPACED AT 6'o.c. MAXIMUM. THERE SHALL BE A MINIMUM OF (2) BOLTS PER PLATE SECTION WITH (1) BOLT LOCATED NOT MORE THAN 12" OR LESS THAN (7) BOLT DIAMETERS FROM EACH END OF THE PLATE SECTION. ANCHOR BOLTS SHALL BE AT LEAST 1/2" AND SHALL EXTEND A MINIMUM OF 7" INTO FOUNDATION. A NUT AND WASHER SHALL BE THETHED ON EACH BOLT TO THE PLATE. INTERIOR BEARING WALL BOTTOM PLATES SHALL BE ANCHORED WITH APPROVED FASTENERS. SILL PLATES SHALL BE PROTECTED AGAINST DECAY AS REQUIRED BY IRC SECTIONS R318, AND R319. ALL WOOD IN CONTACT W/GRADE OR CONCRETE SHALL BE TREATED OR DECAY—INSECT RESISTANT.

FOUNDATION PLAN



BEFORE STARTING YOUR PROJECT MAKE SURE YOU HAVE CHECKED FOR UNDER GROUND UTILITIES ON ALL PUBLIC OR

PLAN NOTES:

- 1) CONTRACTOR/SUBCONTRACTOR SHALL VERIFY ALL CONDITIONS AND DIMENSIONS IN THE FIELD.
- 2) ALL DIMENSIONS ARE FROM ROUGH FRAME FACE OF EXTERIOR WALLS TO ROUGH FRAME FACE OF INTERIOR WALLS.
- 3) ALL WINDOW DESIGNATIONS ARE NOMINAL VERIFY ROUGH OPENING WITH MANUFACTURER. VERIFY TYPE OF DOOR AND WINDOW WITH OWNER AND GENERAL CONTRACTOR. PROVIDE EGRESS WINDOWS PER LOCAL, AND STATE CODE. CENTER WINDOWS IN WALL SPACE U.N.O.
- 4) ALL INTERIOR WALLS ARE 2x4 CONSTRUCTION UNLESS NOTED OTHERWISE AND ALL EXTERIOR WALLS ARE 2x6 CONSTRUCTION UNLESS NOTED OTHERWISE. ALL FRAMING MEMBERS SHALL BE NO. 2 OR BETTER.
- 5) ALL TRADES TO COMPLY TO ALL STATE, COUNTY, AND LOCAL CODES AND REGULATIONS.
- 6) ALL FLOOR TRUSSES TO BE PRE—ENGINEERED AND BUILT BY A TRUSS MANUFACTURER. TRUSS MANUFACTURER TO VERIFY ALL LOADING & BEARING LOCATIONS.
- 7) ALL FLOOR TRUSSES SHALL BE BRACED AS PER TRUSS MANUFACTURERS RECOMMENDATIONS.
- 8) HANDRAIL PER IRC SECTION 311.
- 9) FIRE ESCAPE & RESCUE WINDOWS REQUIRED PER IRC SECTION 310 AND LOCAL AMMENDMENTS.
- 10) ALL WOOD FRAME CONSTRUCTION PER IRC.
- 11) ALL ROOF TRUSSES TO BE PRE-ENGINEERED AND BUILT BY A TRUSS MANUFACTURER. TRUSS MANUFACTURER TO VERIFY ALL CEILING HEIGHTS, VAULT LOCATIONS, AND BEARING POINTS W/ GENERAL CONTRACTOR PRIOR TO STATE OF ENGINEERS. TO START OF FRAMING.
- 12) ALL WOOD IN CONTACT w/ GRADE OR CONCRETE SHALL BE TREATED OR DECAY-INSECT RESISTANT. RE: IRC SECTION R319 & R320.
- 13) INSTALL SMOKE ALARMS AS REQUIRED PER IRC SECTION R313.2

PLAN LEGEND:

- IRC DENOTES APPLICABLE INTERNATIONAL RESIDENTIAL CODE. IF NO APPLICABLE IRC, USE LOCAL REQUIREMENTS, IF NO LOCAL REQUIREMENTS, USE LATEST IRC.
- R&S DENOTES ROD AND SHELF IN CLOSET
- DENOTES FLOOR DRAIN
- G.C. DENOTES GENERAL CONTRACTOR
- + DENOTES HOSE BIB (VERIFY LOCATIONS W/ OWNER)
- DENOTES STEP IN FLOOR ELEVATION

WALL BRACING LEGEND

WALL CONSTRUCTION PER IRC R602

NOTE: BRACED WALL LINES 32'-0"o.c. BRACED WALL PANELS 25'-0"o.c.

BRACED WALL PANEL CONSTRUCTION METHODS PER R602.10.3

* DENOTES HOLD DOWN LOCATION FOR SHEAR WALL (ALTERNATE BRACED WALL PANELS - R602.10.6)

GYPSUM BOARD SHEATHING - (METHOD 5) (1/2" GYPSUM BOARD BOTH SIDES)

WOOD STRUCTURAL WALL PANEL - (METHOD 3)

CHLIMGEN DESIGN

ที่ง

SOUTH DAKOTA CITY, RAPID

FOUNDATION PI

DATE: 10/8/09

DN BY: GH


CK BY: RS

REVS:

PROJECT NUMBER:

SCALE: 1/4"=1'-0"

SHEET:

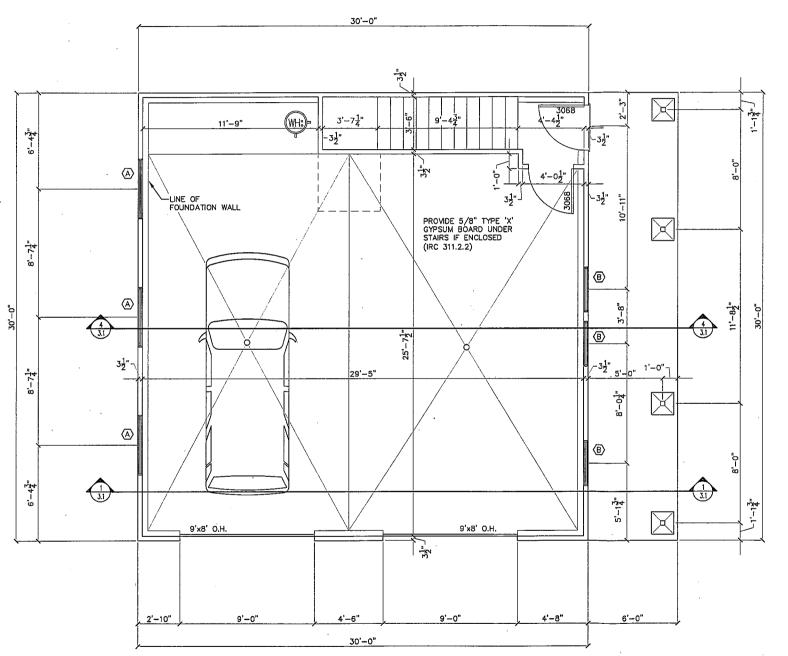

MAIN FLOOR PLAN



SQUARE FOOTAGE GARAGE UPPER FLOOR - 900 - 1,800

PLAN NOTES:

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PLAN LEGEND:

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- R&S DENOTES ROD AND SHELF IN CLOSET
- FD DENOTES FLOOR DRAIN
- G.C. DENOTES GENERAL CONTRACTOR
- \dagger denotes hose bib (verify locations w/ owner)
- DENOTES STEP IN FLOOR ELEVATION

WALL BRACING LEGEND

WALL CONSTRUCTION PER IRC R602

NOTE: BRACED WALL LINES 32'-0"o.c. BRACED WALL PANELS 25'-0"o.c.

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GYPSUM BOARD SHEATHING - (METHOD 5) (1/2" GYPSUM BOARD BOTH SIDES)

WOOD STRUCTURAL WALL PANEL - (METHOD 3)

DESIGN T A N T S GOS 342 3388 Ph SCHLIMGEN I CONSULT ISSIS. Kept Ct. Rapid Ctg. SD 57701

> SOUTH DAKOTA CITY,

RAPID

PLAN MAIN FLOOR SHEET

DATE: 10/8/09

DN BY: GH


CK BY: RS

REVS:

PROJECT NUMBER:

SCALE: 1/4"=1'-0"

SHEET:

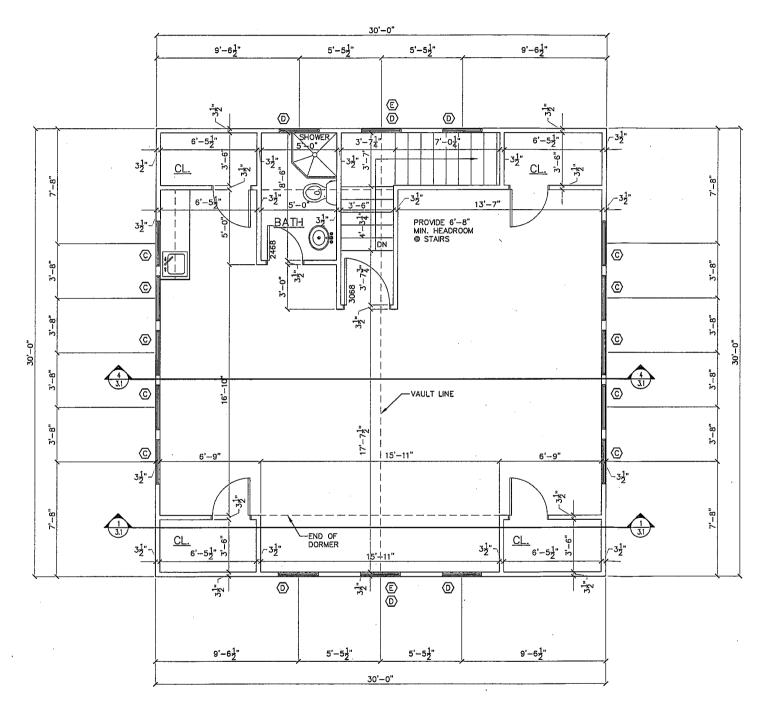

UPPER FLOOR PLAN



PLAN NOTES:

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WALL BRACING LEGEND

WALL CONSTRUCTION PER IRC R602

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(ALTERNATE BRACED WALL PANELS — R602.10.6)

GYPSUM BOARD SHEATHING - (METHOD 5) (1/2" GYPSUM BOARD BOTH SIDES)

WOOD STRUCTURAL WALL PANEL - (METHOD 3)

MGEN DESIGN

SCHCIM CONN ISSIS, Kepat Ct. Rapid City, SD S77

СІТҮ, SOUTH DAKOTA

RAPID

SHEET TITLE:
UPPER FLOOR PLA

DATE: 10/8/09

DN BY: GH

CK BY: RS


REVS:

PROJECT NUMBER:

SCALE: 1/4"=1'-0"

SHEET:

2.3

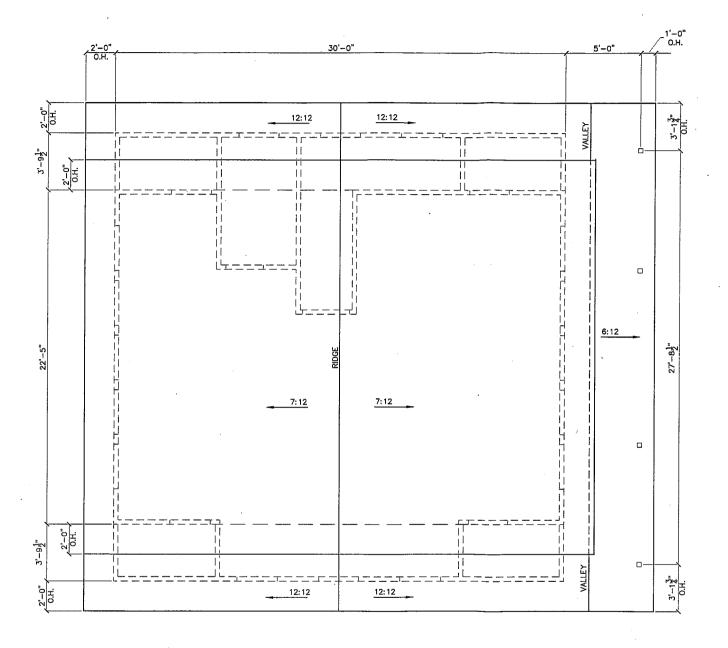

ROOF PLAN



- NOTES:

 TRUSS MANUFACTURER TO VERIFY ALL LOADING & BEARING LOCATIONS.
- ROOF PLAN SHOWN WAS USED FOR COMPLETING DESIGN CONCEPT IN THESE DRAWINGS, AND SHALL BE MODIFIED AS NECESSARY BY ROOF TRUSS DESIGNER/MANUFACTURER.
- SEE TRUSS MANUFACTURER FOR ROOF FRAMING DESIGN & SHOP DRAWINGS.
- PROVIDE ATTIC VENTILATION PER IRC 806
- PROVIDE ICE & WATER SHIELD PER IRC 905.2.7
- VERIFY ALL RIDGE VENT SIZES w/ GENERAL CONTRACTOR.
- HEADERS & LINTEL DESIGN TO BE PROVIDED BY GENERAL CONTRACTOR (TYPICAL)

SCHUMGE CONSU ISSI S. Keptr Ct. Rapid City. SC 57701

RAPID CITY, SOUTH DAKOTA

SHEET 117LE ROOF PLAN

DATE: 10/8/09

DN BY: GH

CK BY: RS REVS:

PROJECT NUMBER:

SCALE: 1/4"=1'-0"

SHEET:

