


CANYON LAKE LITTLE LEAGUE MAJORS FIELD FENCE RELOCATION

RAPID CITY, SD
MAY 2013

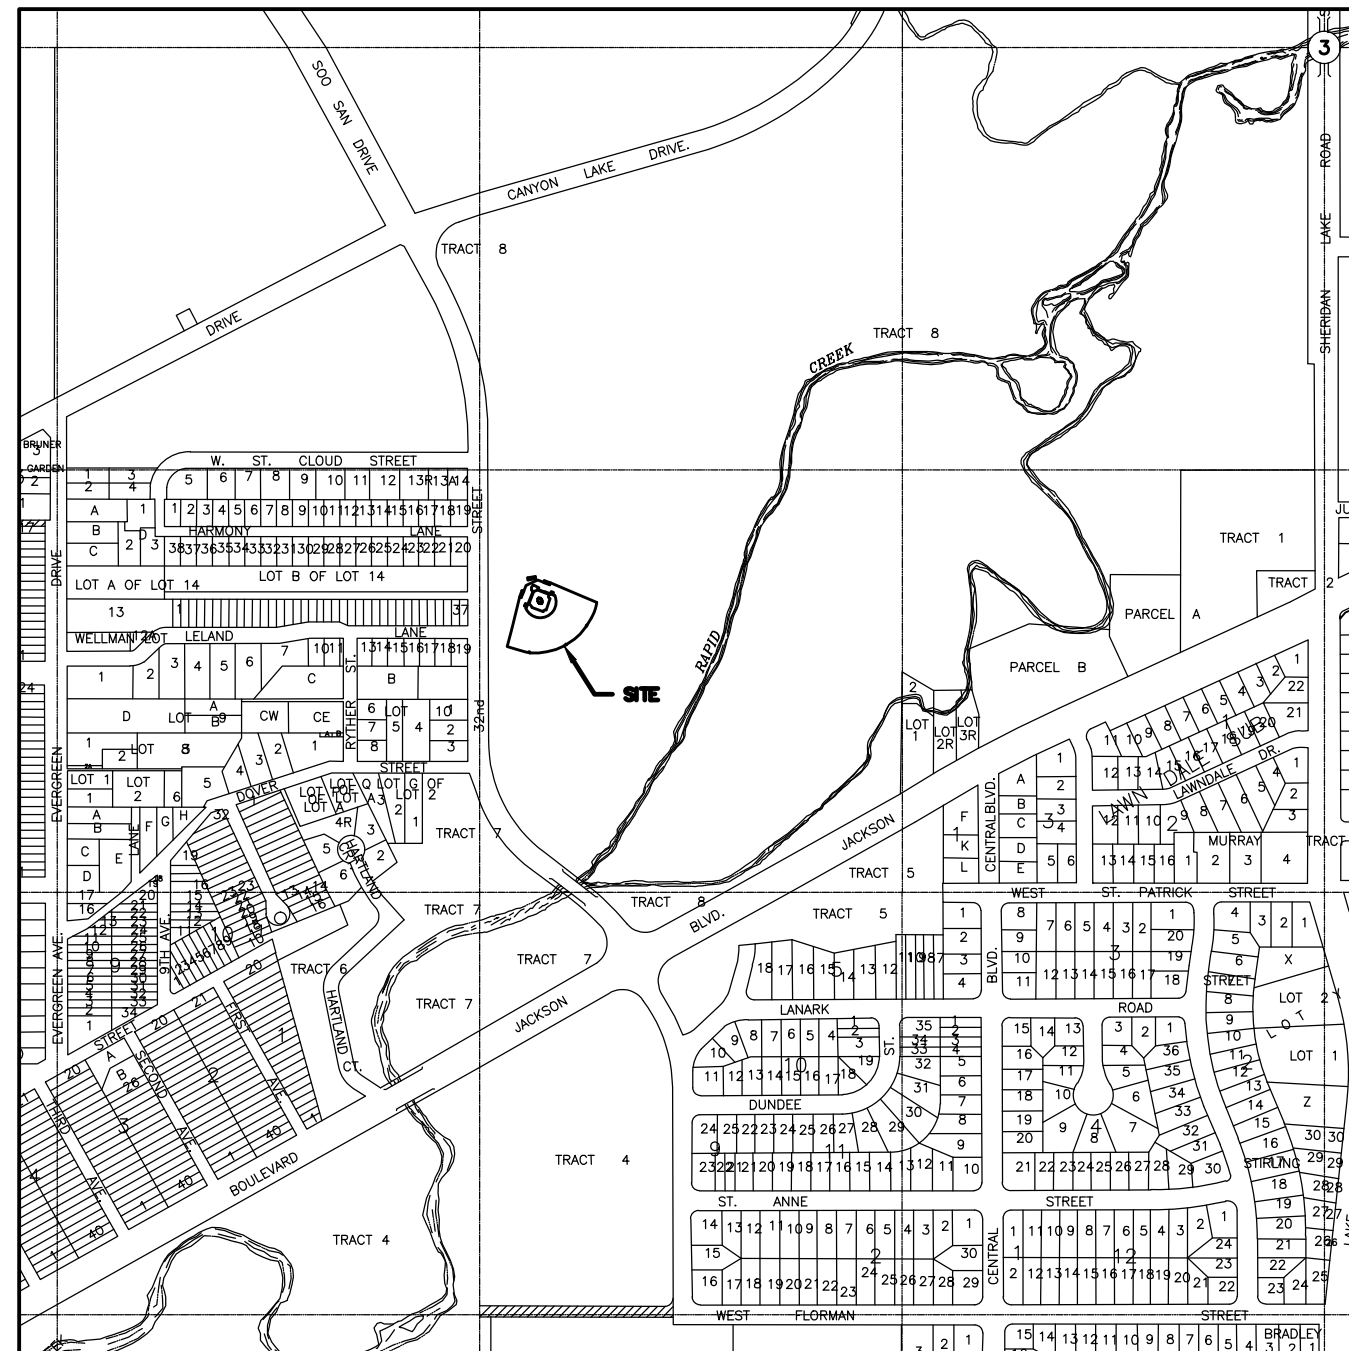

VICINITY MAP
SCALE: 1" = 300'

INDEX OF SHEETS

- 1 TITLE SHEET
- 2 NOTES
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- 4 PROFILE AND CROSS SECTIONS
- 5 GRADING DETAILS
- 6 STORMWATER POLLUTION AND PREVENTION PLAN
- 7 SEDIMENT AND EROSION CONTROL PLAN
- 8 EROSION CONTROL DETAILS
- 9 DUGOUT PLAN
- 10 DUGOUT ELEVATIONS
- 11 DUGOUT DETAILS

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CANYON LAKE LITTLE LEAGUE
MAJORS FIELD FENCE RELOCATION

Sheet Title:
TITLE

Sheet:
1 of 11

1. SPECIFICATIONS TO BE USED

Work shall be in accordance with the 2007 Edition of the City of Rapid City Standard Specifications for Public Works Construction and any current revisions and/or additions, Special Provisions or requirements on the drawings or in the proposal. Dugouts shall be constructed in accordance with 2012 IBC.

2. UTILITIES

All utilities within the limits of the work are to be adjusted by the individual utility owners unless otherwise indicated on the plans. The Contractor is required to call and coordinate with the private utility companies. The Contractor is responsible for coordinating his work schedule with the various private utilities. It is possible the existing telephone duct bank located on the west side of Elm Avenue may need to be supported for utility construction, coordinate with the utilities contractor for this. No extra payment or contract time extension will be made as the result of delays that may be caused by private utility work. Payment for utility coordination will be made under Lump Sum Contract Amount for "Private Utility Coordination".

The One Call number was called for utility locates during survey activities for project design. The utilities shown on the drawings are from the One Call markings. The Contractor is responsible to verify the locations of all utilities. No extra payment will be made as a result of different utility locations or any other utilities that may be present.

3. CONSTRUCTION STAKING

All construction staking will be furnished by the Contractor.

4. AIR QUALITY CONSTRUCTION PERMIT FROM THE RAPID CITY AREA AIR QUALITY DIVISION OF THE DEVELOPMENT SERVICE CENTER

The Contractor shall comply with the requirements of Section 7.28 of the Standard Specifications regarding fugitive emission control. Environmental permits shall be obtained prior to beginning work.

Contractor shall provide measures for dust control.

4. STORM WATER FLOWS

The Contractor is notified that the project is located near the mouth of a large urban drainage basin. Flows will be encountered during storm/rain events.

5. CLEARING AND GRUBBING

Trees approved for removal are shown on the plan drawings. Trees shown with an "X" are scheduled for removal.

6. EXCAVATION

It is estimated that excess excavation will result. The Contractor is responsible to dispose of all excess excavation at a location furnished by the Contractor.

TABLE OF EXCAVATION QUANTITIES

| | UNIT | QUANTITY |
|------------------|------|----------|
| TOTAL EXCAVATION | CY | 270 |

| | UNIT | QUANTITY |
|------------------|------|----------|
| EMBANKMENT | CY | 53 |
| 20% SHRINKAGE | CY | 11 |
| TOTAL EMBANKMENT | CY | 64 |

| | UNIT | QUANTITY |
|------------|------|----------|
| EXCAVATION | CY | 270 |
| EMBANKMENT | CY | - 64 |

| | UNIT | QUANTITY |
|------------------|------|----------|
| WASTE EXCAVATION | CY | 206 |

7. SAWING EXISTING PAVEMENT OR SIDEWALK

Where new concrete sidewalk is placed next to existing sidewalk, the existing sidewalk shall be sawed full depth to a true line with a vertical face.

8. DUGOUTS

Contractor shall salvage existing metal dugout doors to be used on the new dugouts. New hinges and hardware shall be used when the dugout doors are installed on the new dugouts.

Wood framed roof shall be salvaged. Care shall be taken not to damage roof during removal and installation on new dugouts. New 2x sill plates will be needed for installation onto new dugouts.

Dugouts shall be constructed for 8x8x16 CMU's with a minimum compressive strength (F'm) of 1500 psi. Type S mortar cement shall be used with a minimum compressive strength of 1800 psi. CMU's shall be constructed using running bond.

9. CHAIN LINK FENCE

Existing chain link fence shall be salvaged where possible and constructed in accordance with the details.

The location of the new dugouts will require relocation of the existing fence around the entrance to the dugouts. The contractor shall verify the dimensions of the entrance are reconstruct to similar dimensions. Refer to plan drawings locations of chain link fence.

10. PITCHER WARMUP AREAS

Pitcher mounds in the warm up areas along the playing field fence will need to be relocated due to the location of the new dugouts. Canyon Lake Little League will dictate where these warmup areas will be located.

11. REMOVALS

Concrete next to existing dugouts shall be removed and disposed of.

Existing dugouts shall be removed and disposed of with the exception of the benches inside, roof including wooden frame components, and metal doors.

Contractor shall dispose removed materials at a state licensed waste facility.

12. WOOD COMPONENTS

Wood components shall be treated for use in outdoor environments and shall be Spruce-Pine-Fir (SPF) No. 2 or better

13. CONCRETE

All concrete shall have a minimum compressive strength of 3000 psi at 28 days.

14. PVC DUGOUT DRAINS

Dugouts shall be constructed with drains as shown in the drawings. All pipe and fitting leading from these drains shall be PVC meeting the requirements of ASTM D-3034 (saintary sewer pipe).

A metal grate provided by the contractor shall be placed in the concrete floor of the dugouts in the location of the drain.

15. EROSION CONTROL BLANKET

Erosion control blanket shall be installed at the locations noted in the table and at locations determined by the Engineer during construction.

The erosion control blanket provided shall be from the SD DOT approved product list. The approved product list for erosion control blanket may be viewed at the following internet site:

<http://www.state.sd.us/Applications/HC54ApprovedProducts/main.asp>

The Contractor shall install erosion control blanket according to the manufacturer's installation instructions.

An additional quantity of 50 square yards of Type 2 Erosion Control Blanket has been added to the Estimate of Quantities for "Erosion Control Blanket, SD DOT Type 2".

16. TOPSOIL

The Contractor shall salvage 6" of topsoil and stockpile at a designated location near the project. Erosion control wattles shall be placed around the topsoil stockpile to prevent loss of topsoil and storm water pollution. Location of topsoil stockpile shall be shown on Sheet E2 along with wattles.

17. SEEDING AND SODDING

The contractor shall use a non-irrigated seed mixture in accordance with the standard specifications for the channel side slopes and bottom.

Sod shall be used in all other locations.

18. FERTILIZING

Sod and new seed shall be fertilized in accordance with the Standard Specifications.

19. WATER QUALITY AND EROSION CONTROL

Canyon Lake Little League is responsible for procuring coverage for the project under the SD DENR General Permit for Storm Water Discharges Associated with Construction Activities and the Rapid City Erosion Control Permit. The Contractor is solely responsible for implementation of the requirements of these Permits. FMG will assist Canyon Lake Little League for the procurement of these permits.

Erosion control and water pollution control work shall also be in accordance with Section 18 of the Standard Specifications. A Storm Water Pollution and Prevention Plan (SWPPP) and Erosion and Sediment Control drawings are provided to help guide the Contractor to meet the minimum requirements for Water Pollution Control. The Contractor is responsible for implementation of the SWPPP and make changes is necessary.

The Contractor is advised that environmentally sensitive areas are located within and downstream of the project and that the requirements of his Permit and Erosion and Sediment Control Plan must be fully implemented. Several agencies have authority to "stop work" if the pollution prevention controls are not implemented or are not effective in prevention of environmental damage.

Storm water pollution prevention plan is shown on sheets E1 through E3. Maintenance of temporary erosion devices will be the sole responsibility of the contractor.

CONTROL TABLE

| | NORTHING | EASTING | ELEVATION | DESCRIPTION |
|------------|----------|---------|-----------|---|
| BENCH MARK | 4302.72 | 5217.65 | 3305.19 | CITY BENCHMARK LOCATED SOUTH OF FIELD ALONG 32ND STREET |

CHANNEL ALIGNMENT TABLE

| Desc. | Station | Spiral/Curve Data | Northing | Easting | Tangent Data |
|-------|---------|--|----------------------------|---------|---|
| | | | | | 3+27.80 3+59.25 Length: 31.45 Course: N 81° 55' 37" E |
| PI | 1+00 | Length: 105.75 Course: N 68° 02' 45" E | 5046.08 N 68° 02' 45" E | 5046.06 | |
| | | Circular Curve Data | | | |
| PC | 2+05.75 | | 5085.62 | 5144.14 | |
| RP | | | 5141.27 | 5121.70 | |
| PT | 2+26.99 | | 5096.84 | 5162.03 | |
| | | Delta: 20° 16' 46" type: LEFT | | | |
| | | Radius: 60.00' DOC: 95° 29' 35" | | | |
| | | Length: 21.24 Tangent: 10.73 | | | |
| | | Mid-Ord: 0.937 External: 0.952 | | | |
| | | Chord: 21.13 Course: S 57° 54' 22" E | | | |
| | | Tangent Data | | | |
| | 2+26.99 | | 5096.84 | 5162.03 | |
| | 2+92.02 | | 5140.56 | 5210.19 | |
| | | Length: 65.04 Course: N 47° 45' 59" E | | | |
| Desc. | Station | Spiral/Curve Data | Northing | Easting | |
| | | Circular Curve Data | | | |
| PC | 2+92.02 | | 5140.56 | 5210.19 | |
| RP | | | 5096.13 | 5250.52 | |
| PT | 3+27.80 | | 5155.54 | 5242.09 | |
| | | Delta: 34° 09' 38" Type: RIGHT | | | |
| | | Radius: 60.00' DOC: 95° 29' 35" | | | |
| | | Length: 35.77 Tangent: 18.44 | | | |
| | | Mid-Ord: 2.65 External: 2.77 | | | |
| | | Chord: 35.25 Course: N 64° 50' 48" E | | | |





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| Surveyed By: | Survey Date: |
| FISK ENG. | UNKNOWN |
| Revisions: | |

CANYON LAKE LITTLE LEAGUE
MAJORS FIELD FENCE RELOCATION

Sheet Title:
GENERAL NOTES

32nd Street

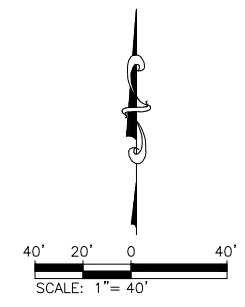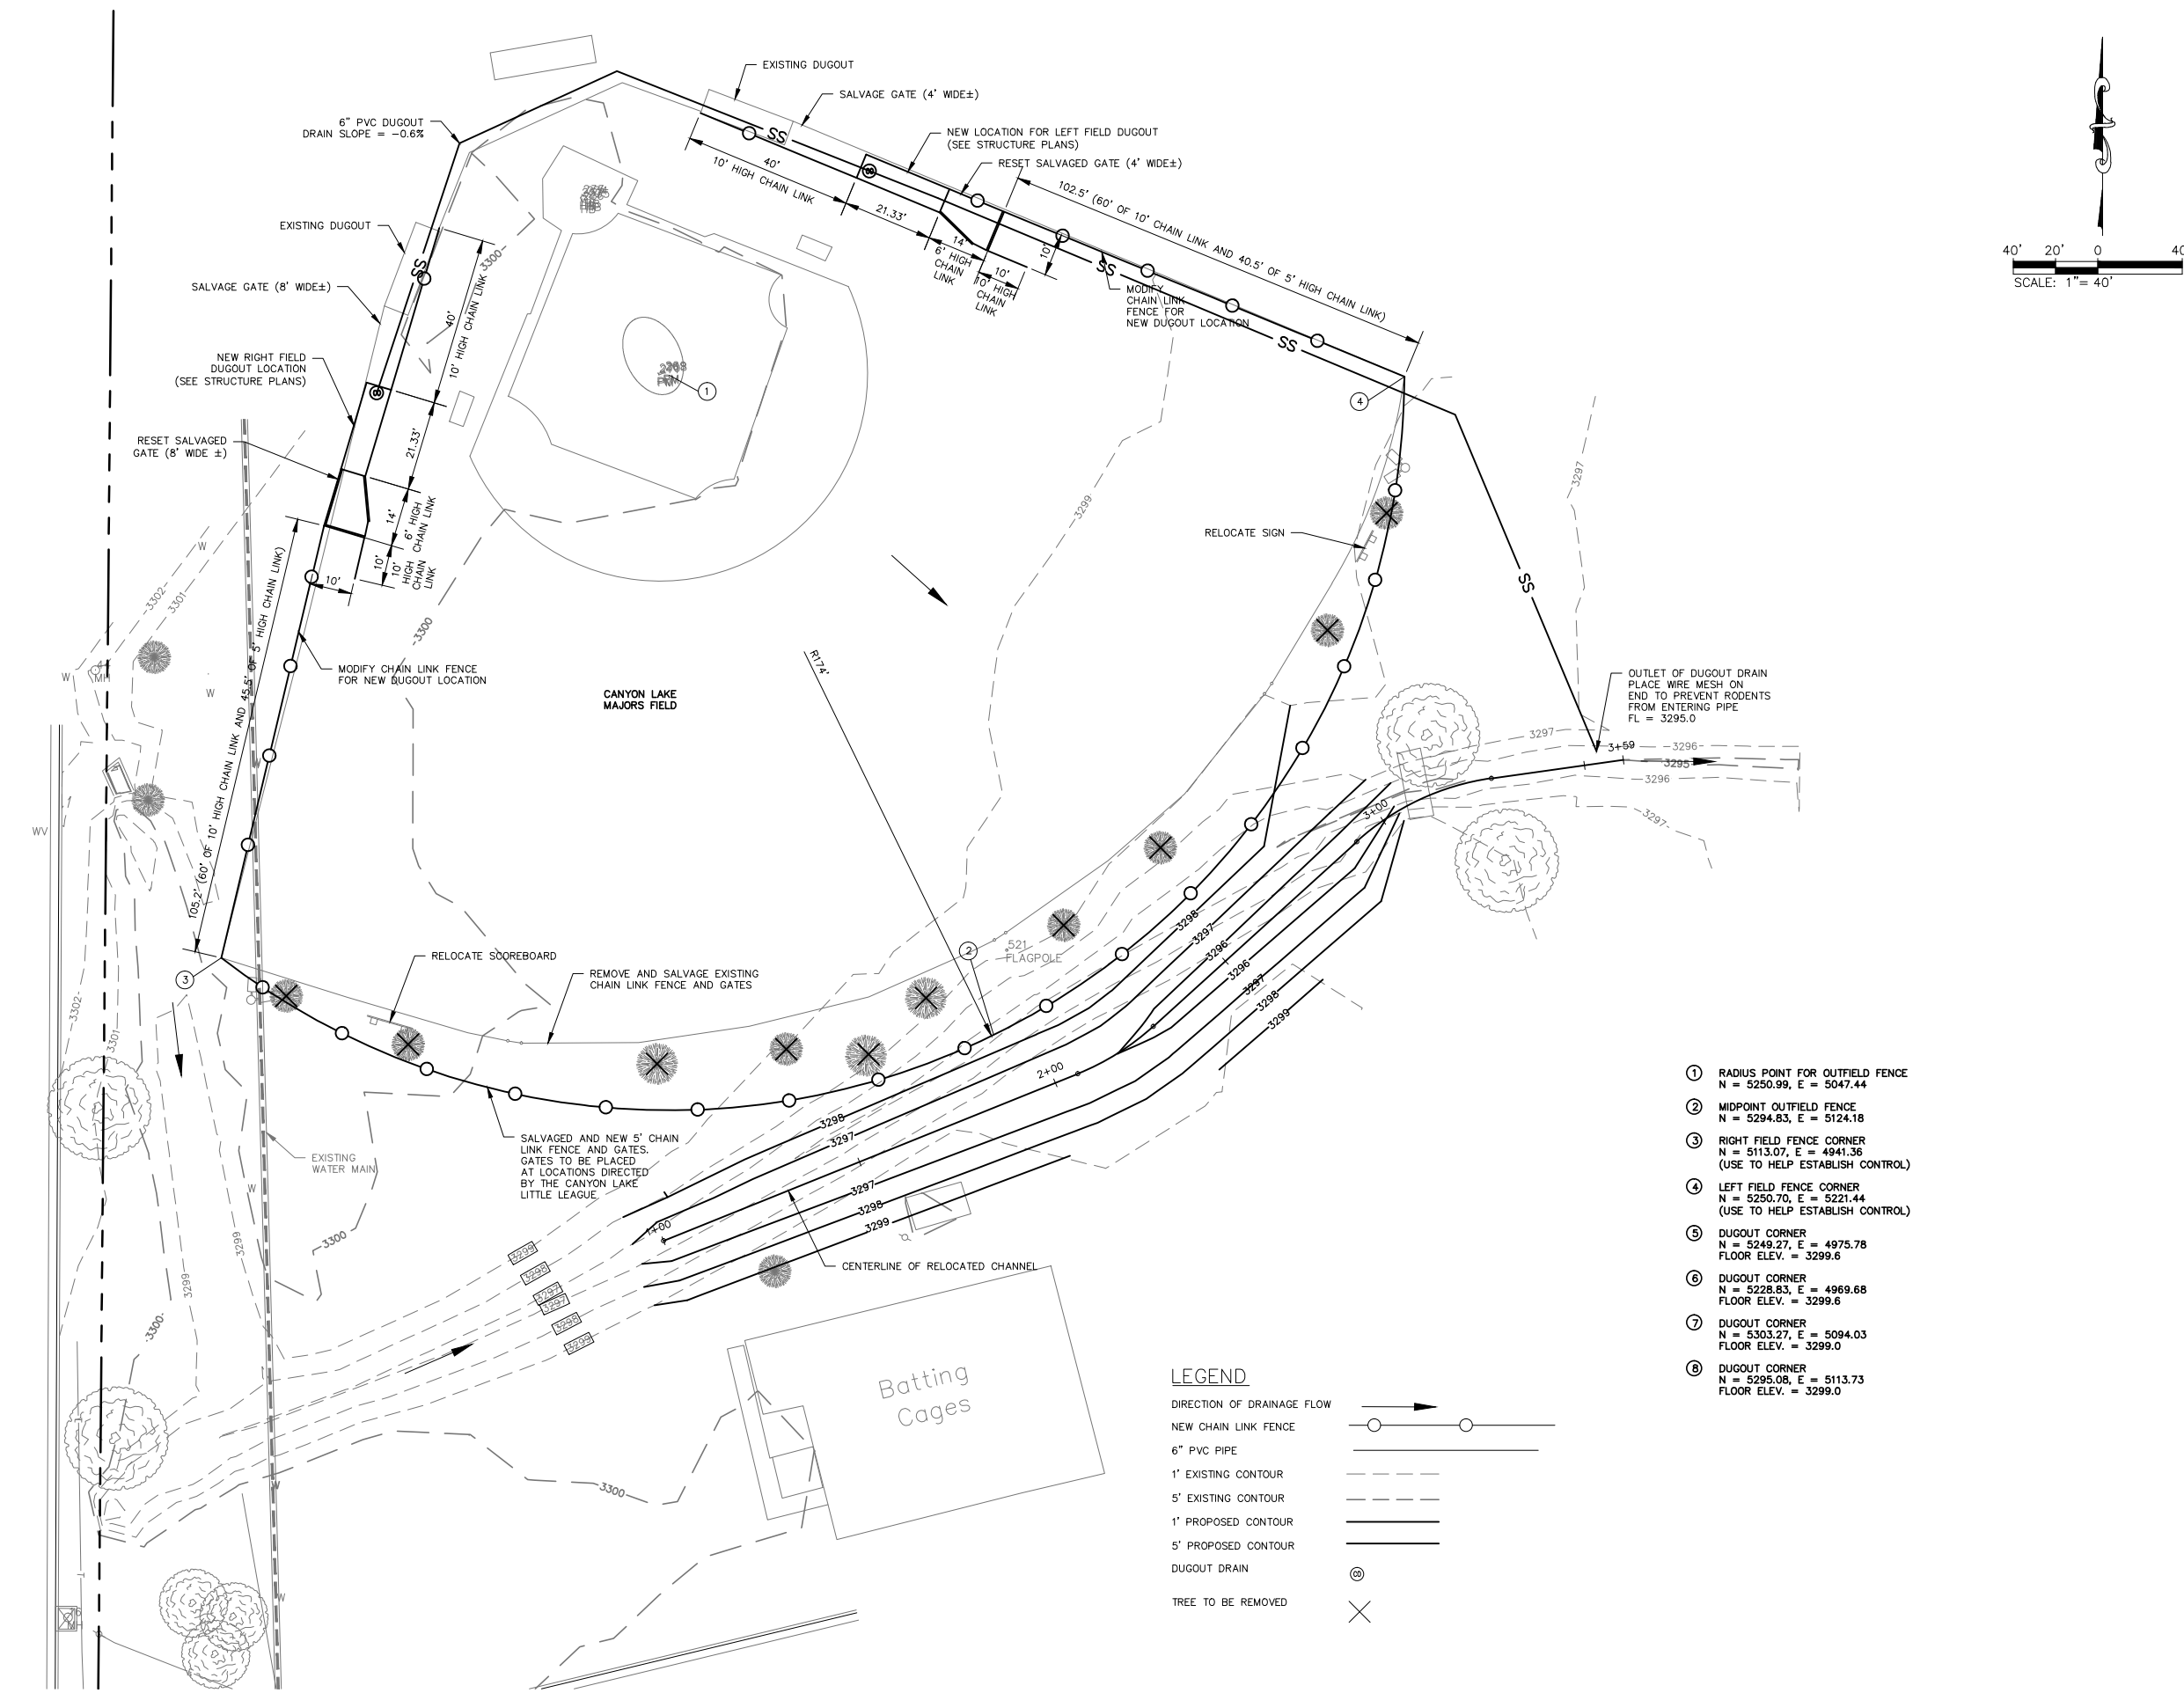

- ① RADIUS POINT FOR OUTFIELD FENCE
N = 5250.99, E = 5047.44
- ② MIDPOINT OUTFIELD FENCE
N = 5294.83, E = 5124.18
- ③ RIGHT FIELD FENCE CORNER
N = 5113.07, E = 4941.36
(USE TO HELP ESTABLISH CONTROL)
- ④ LEFT FIELD FENCE CORNER
N = 5250.70, E = 5221.44
(USE TO HELP ESTABLISH CONTROL)
- ⑤ DUGOUT CORNER
N = 5249.27, E = 4975.78
FLOOR ELEV. = 3299.6
- ⑥ DUGOUT CORNER
N = 5228.83, E = 4969.68
FLOOR ELEV. = 3299.6
- ⑦ DUGOUT CORNER
N = 5303.27, E = 5094.03
FLOOR ELEV. = 3299.0
- ⑧ DUGOUT CORNER
N = 5295.08, E = 5113.73
FLOOR ELEV. = 3299.0

LEGEND

DIRECTION OF DRAINAGE FLOW →

NEW CHAIN LINK FENCE —○—○—

6" PVC PIPE ———

1' EXISTING CONTOUR - - - - -

5' EXISTING CONTOUR - - - - -

1' PROPOSED CONTOUR ———

5' PROPOSED CONTOUR ———

DUGOUT DRAIN ⊙

TREE TO BE REMOVED ✕

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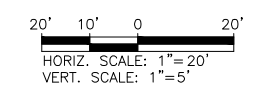
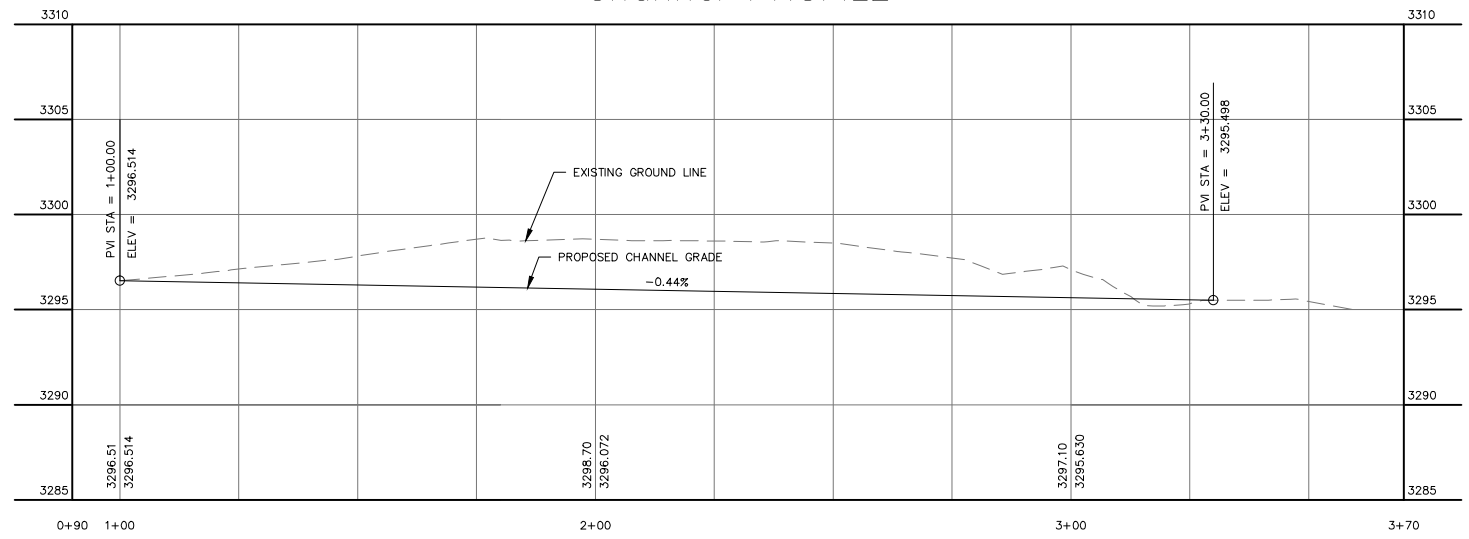
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**CANYON LAKE LITTLE LEAGUE
 MAJORS FIELD FENCE RELOCATION**

Sheet Title:
PLAN

Channel PROFILE












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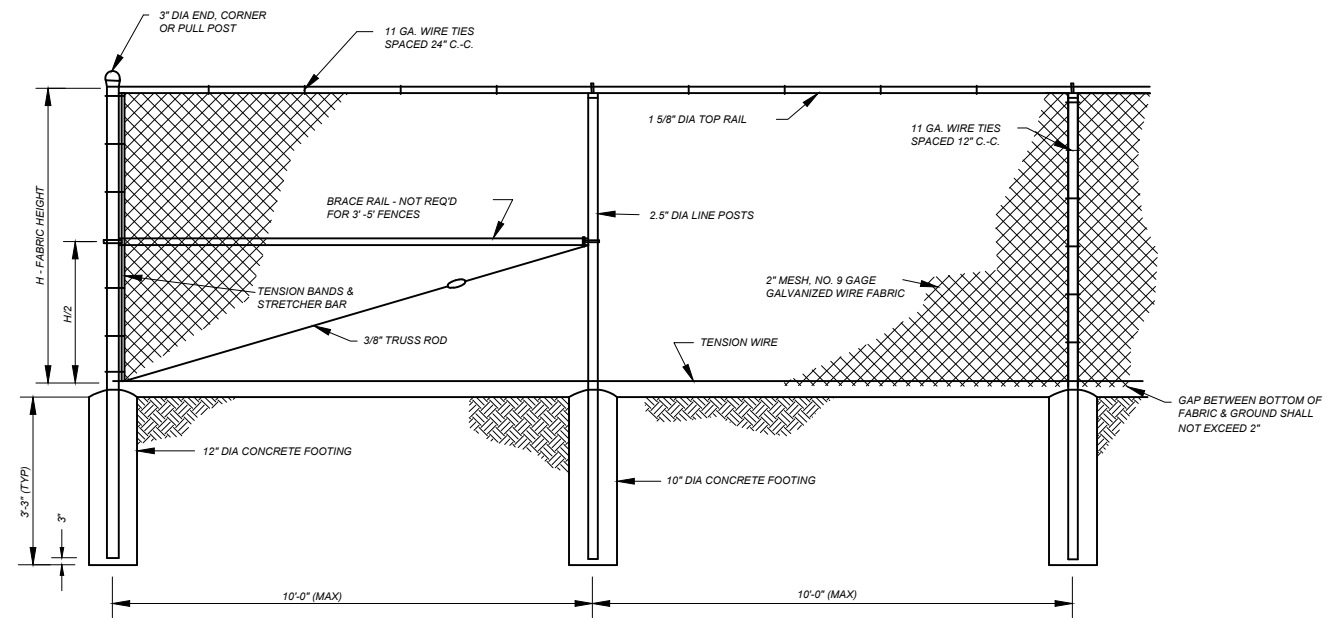
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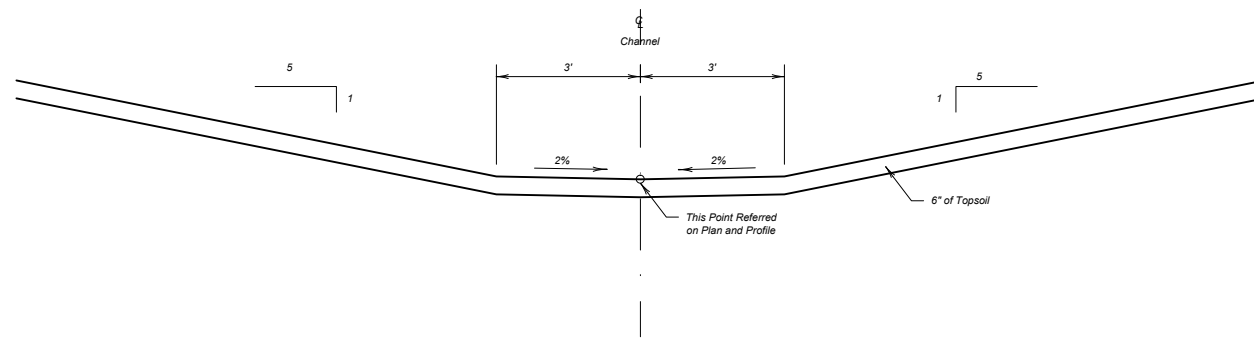
CANYON LAKE LITTLE LEAGUE
MAJORS FIELD FENCE RELOCATION

Sheet Title:
PROFILE AND CROSS SECTIONS





CHAIN LINK FENCE
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TYPICAL SECTION
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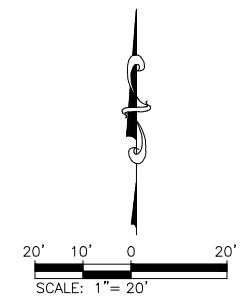
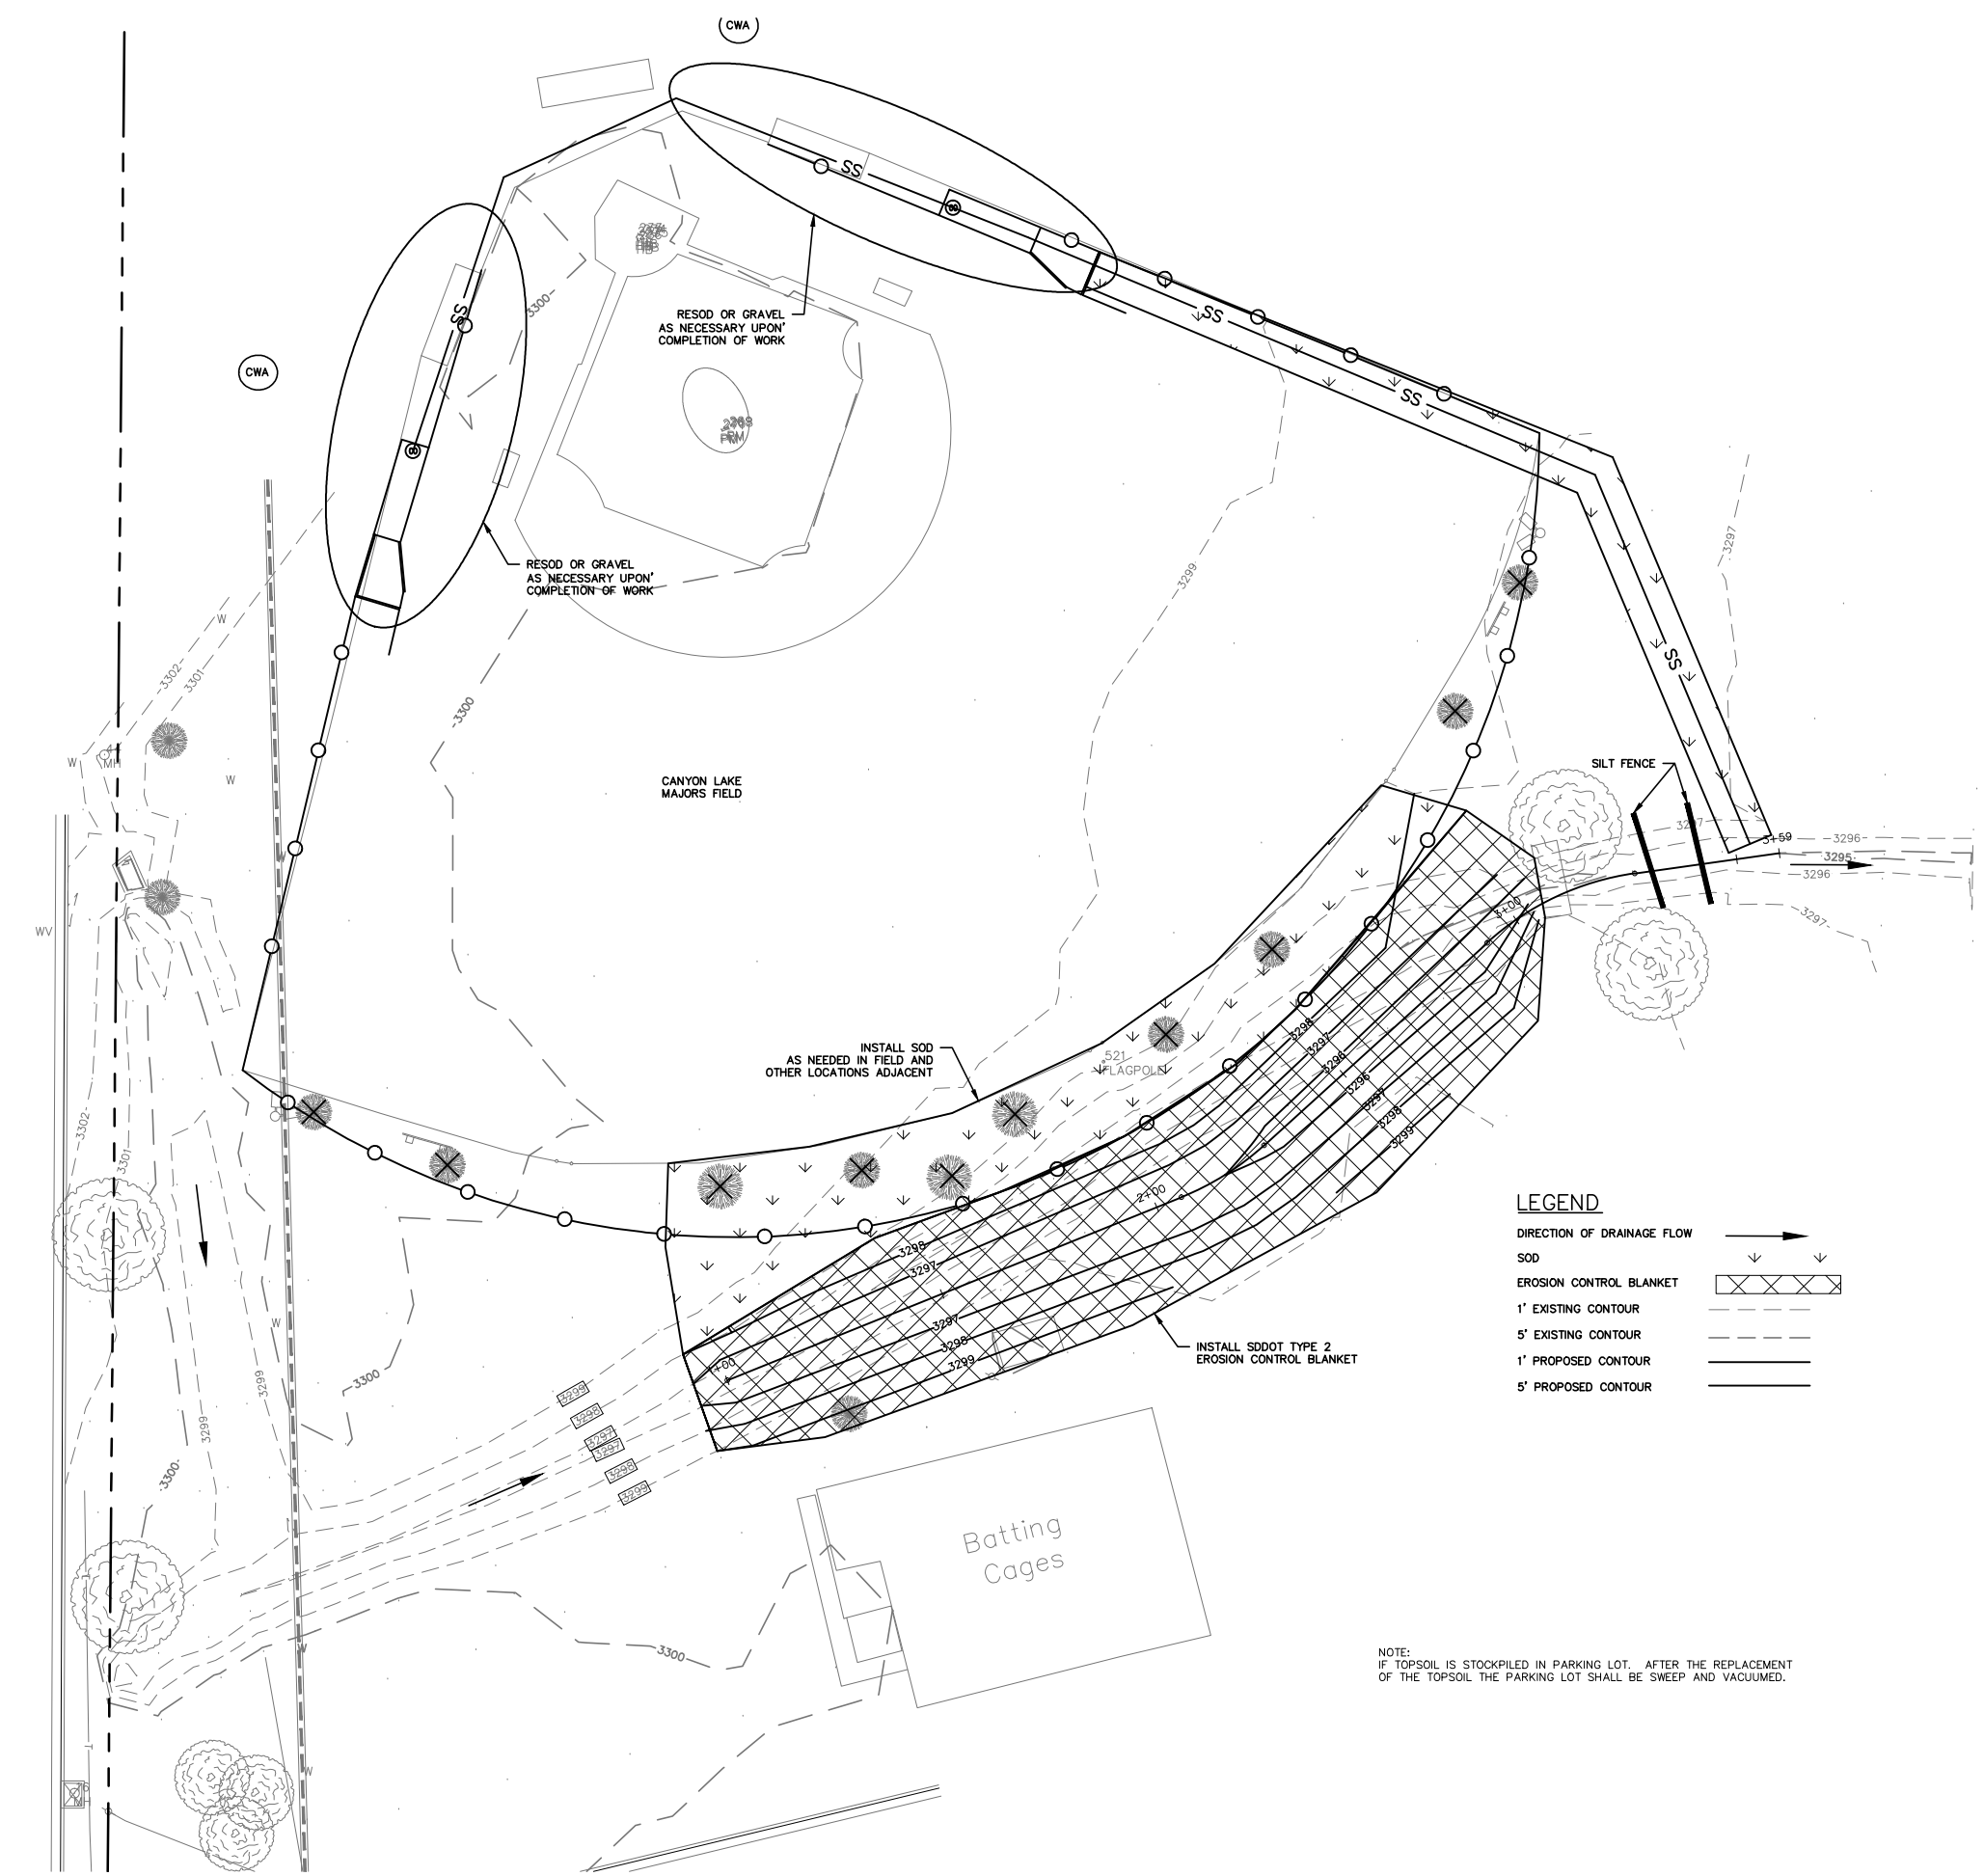
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**CANYON LAKE LITTLE LEAGUE
 MAJORS FIELD FENCE RELOCATION**

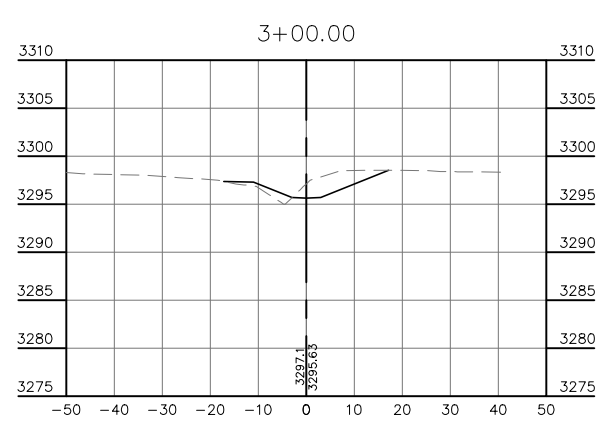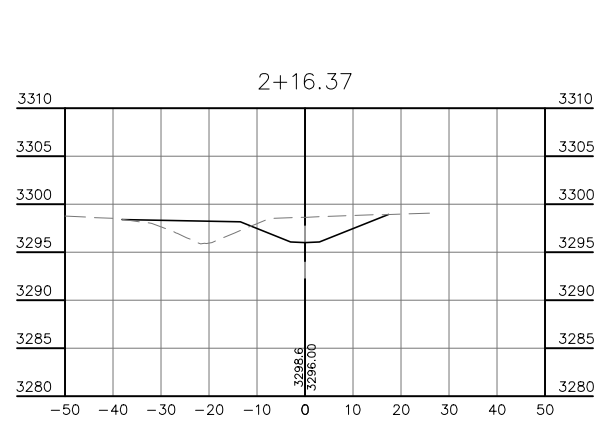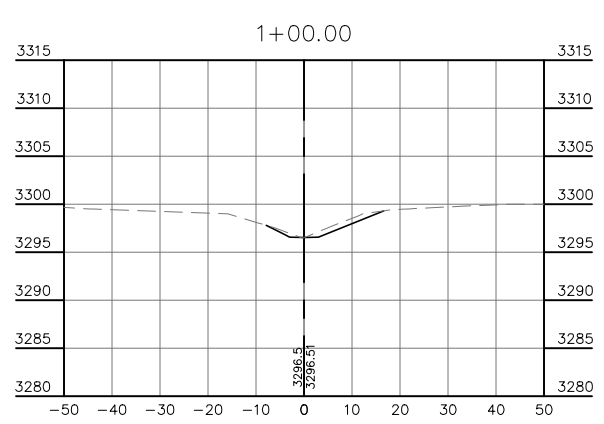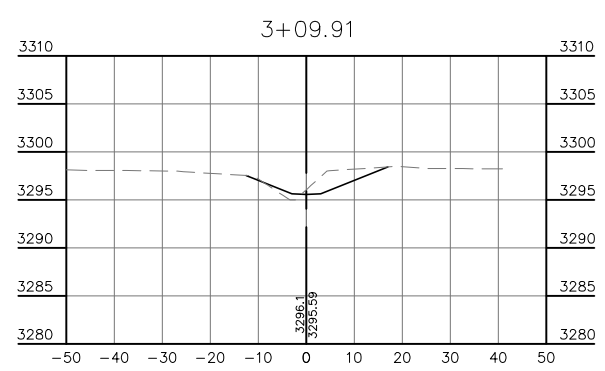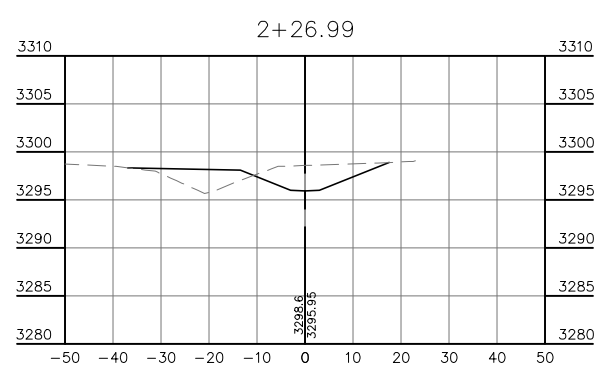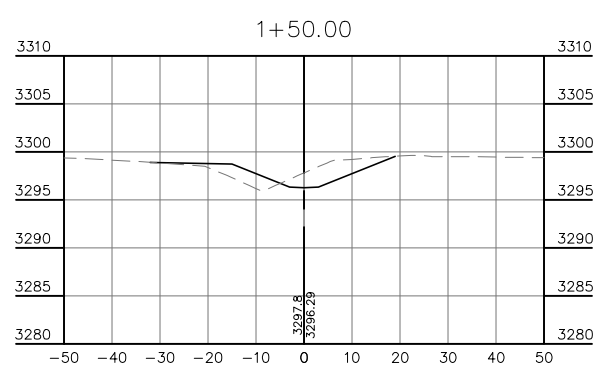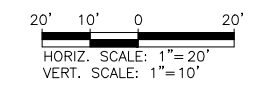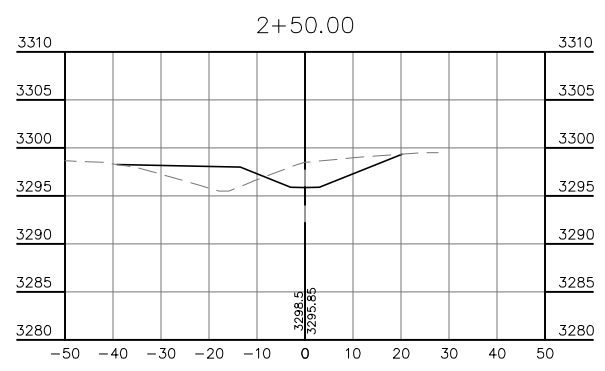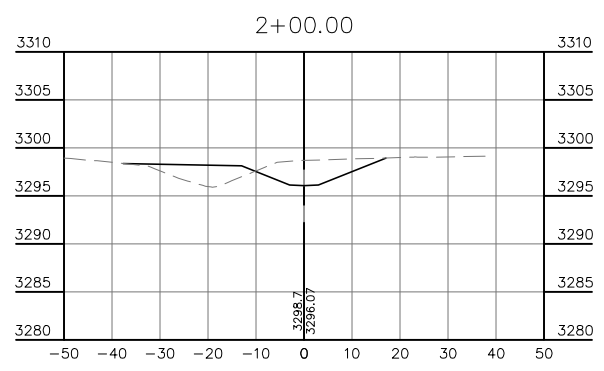Sheet Title:
**GRADING
 DETAILS**

32nd Street








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**CANYON LAKE LITTLE LEAGUE
 MAJORS FIELD FENCE RELOCATION**

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SEDIMENT AND EROSION CONTROL PLAN




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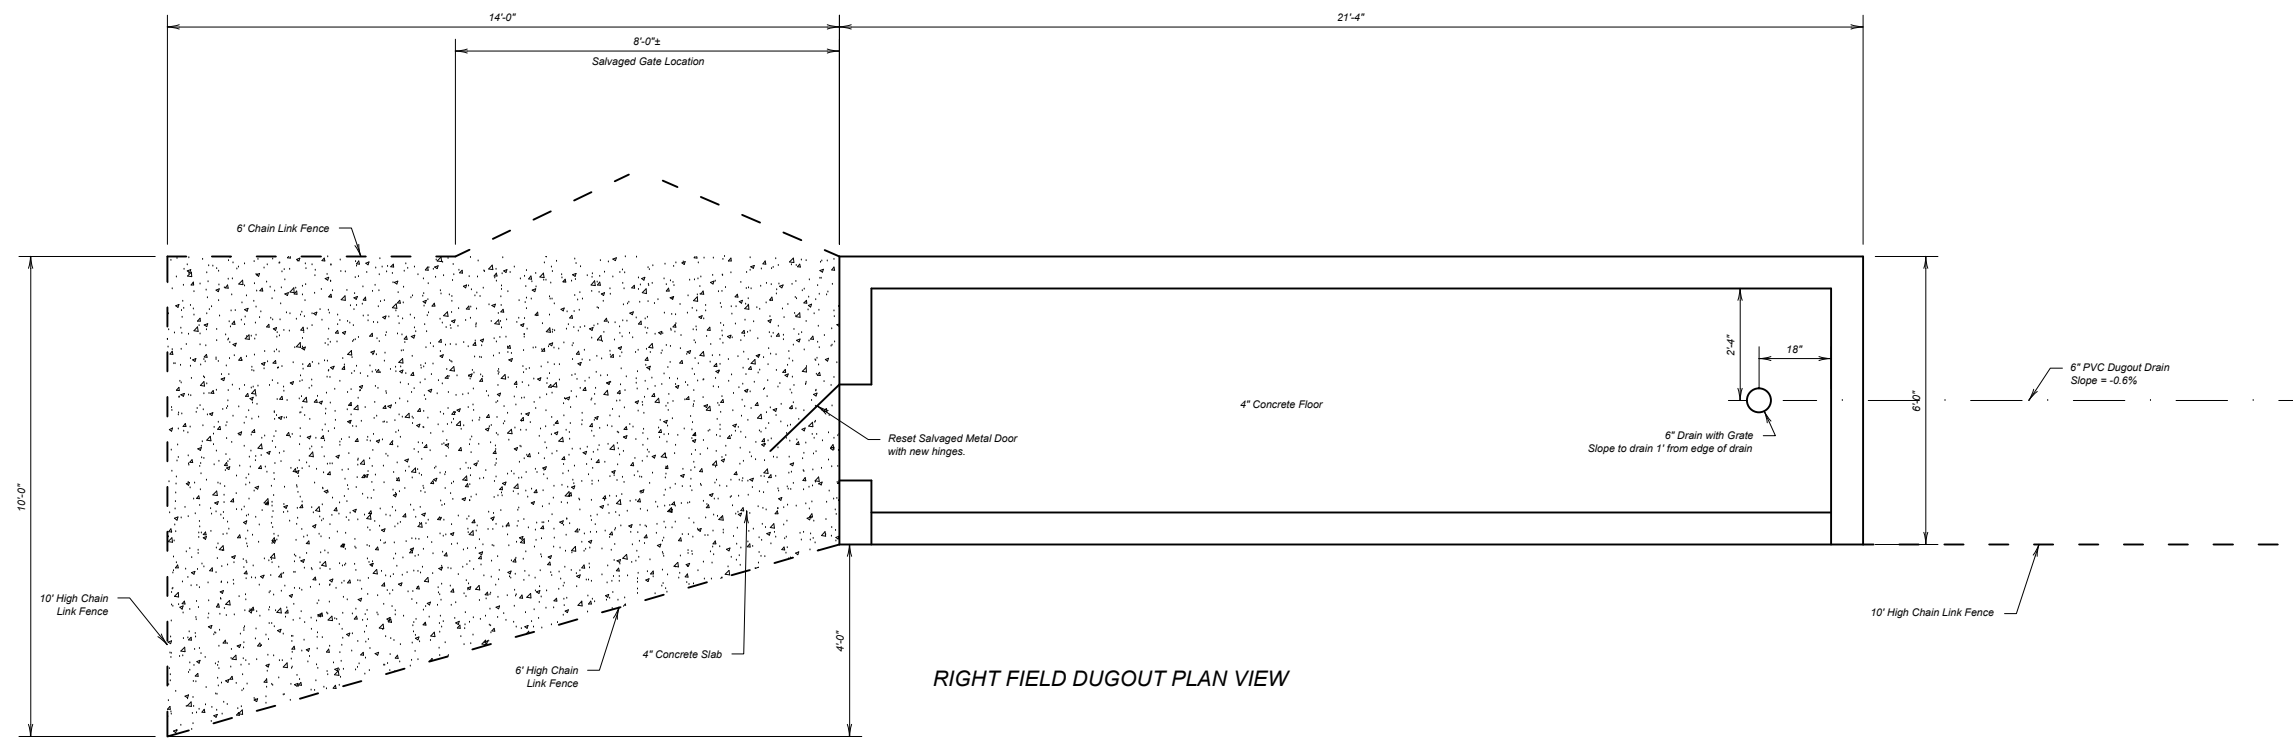
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CANYON LAKE LITTLE LEAGUE
MAJORS FIELD FENCE RELOCATION

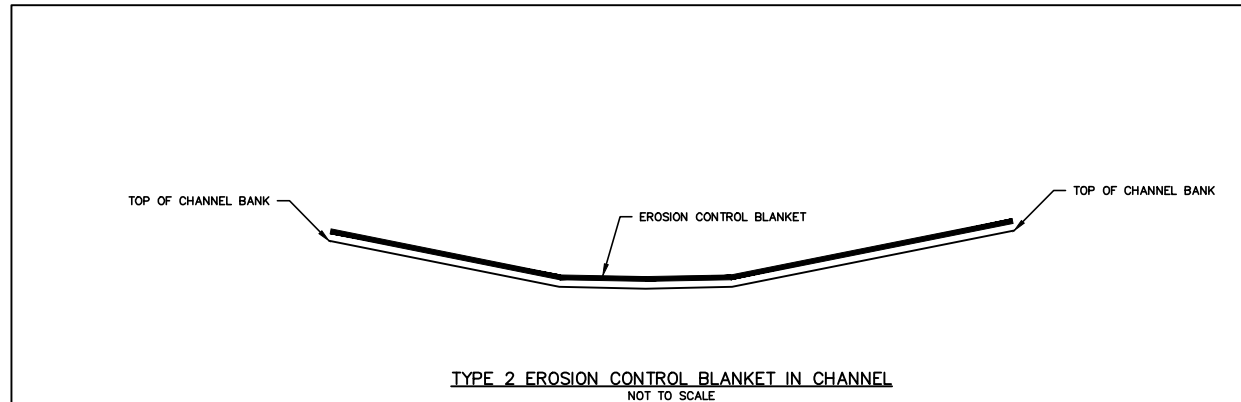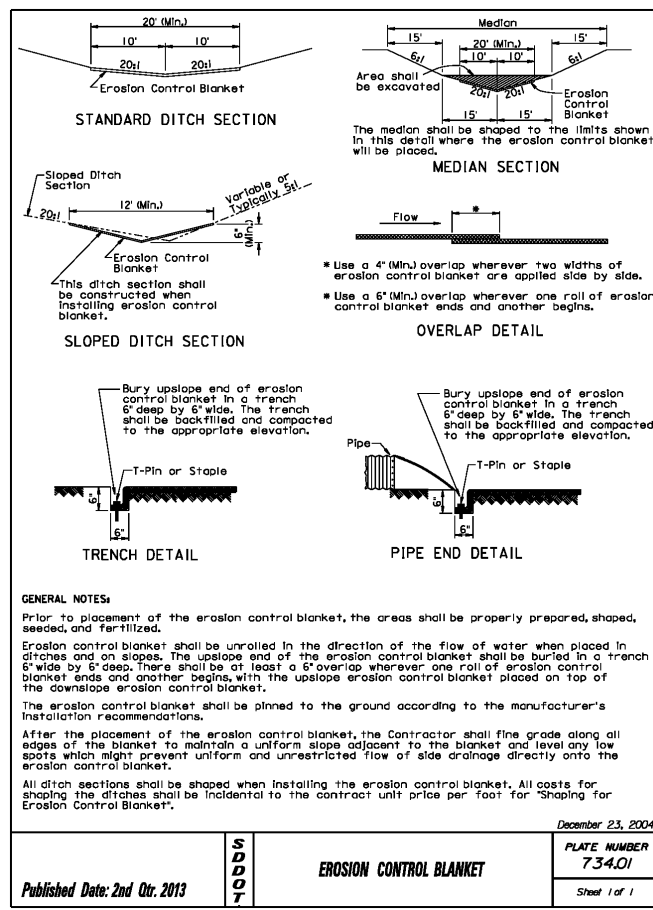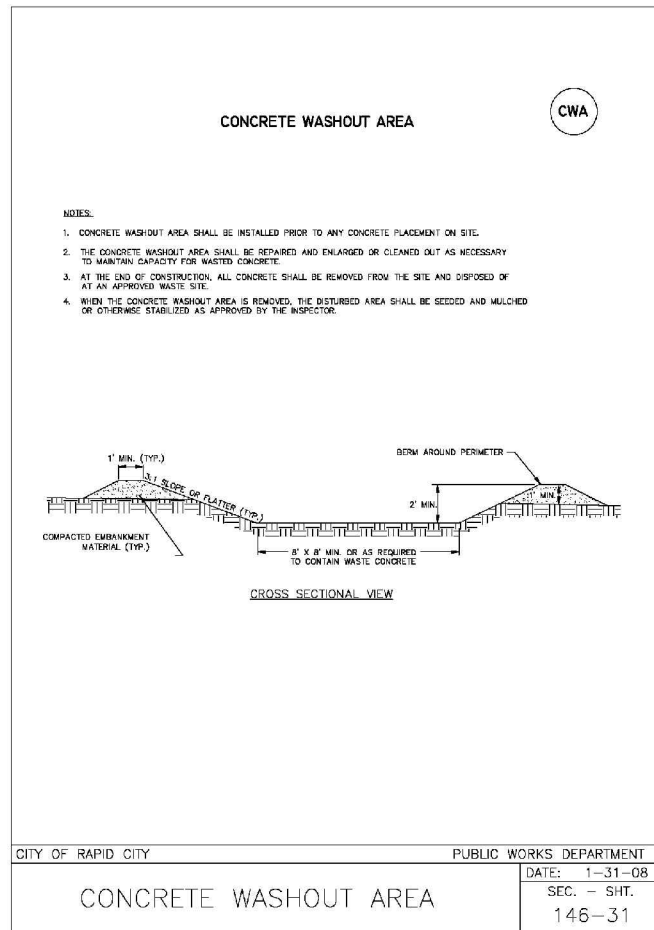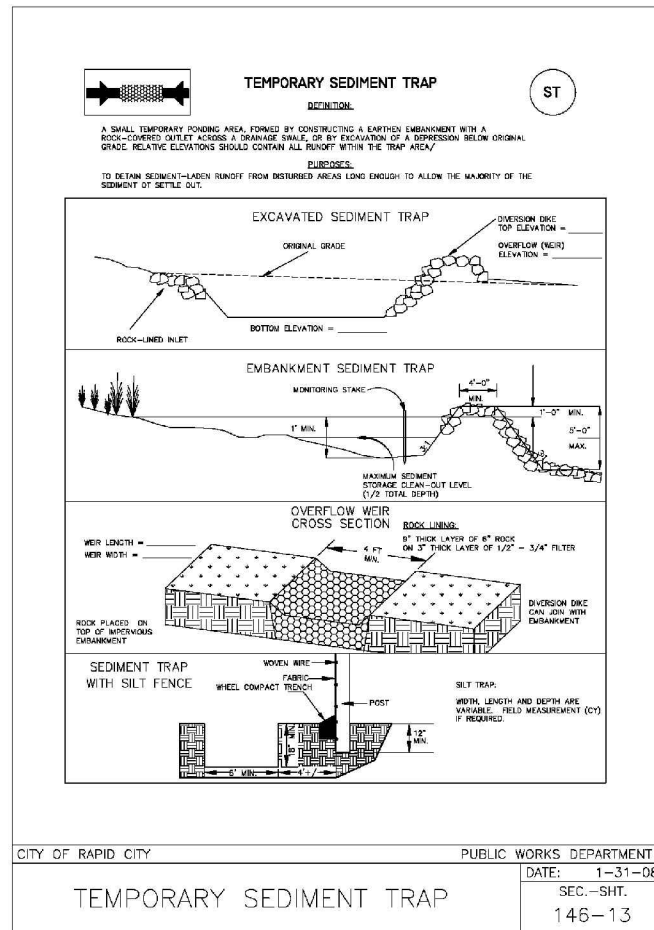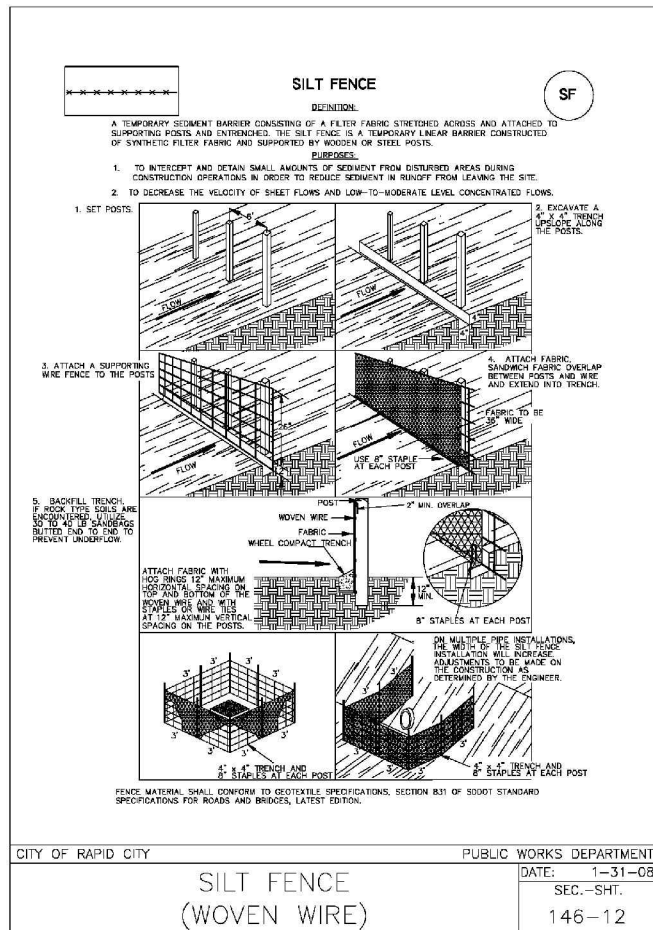

LEFT FIELD DUGOUT PLAN VIEW

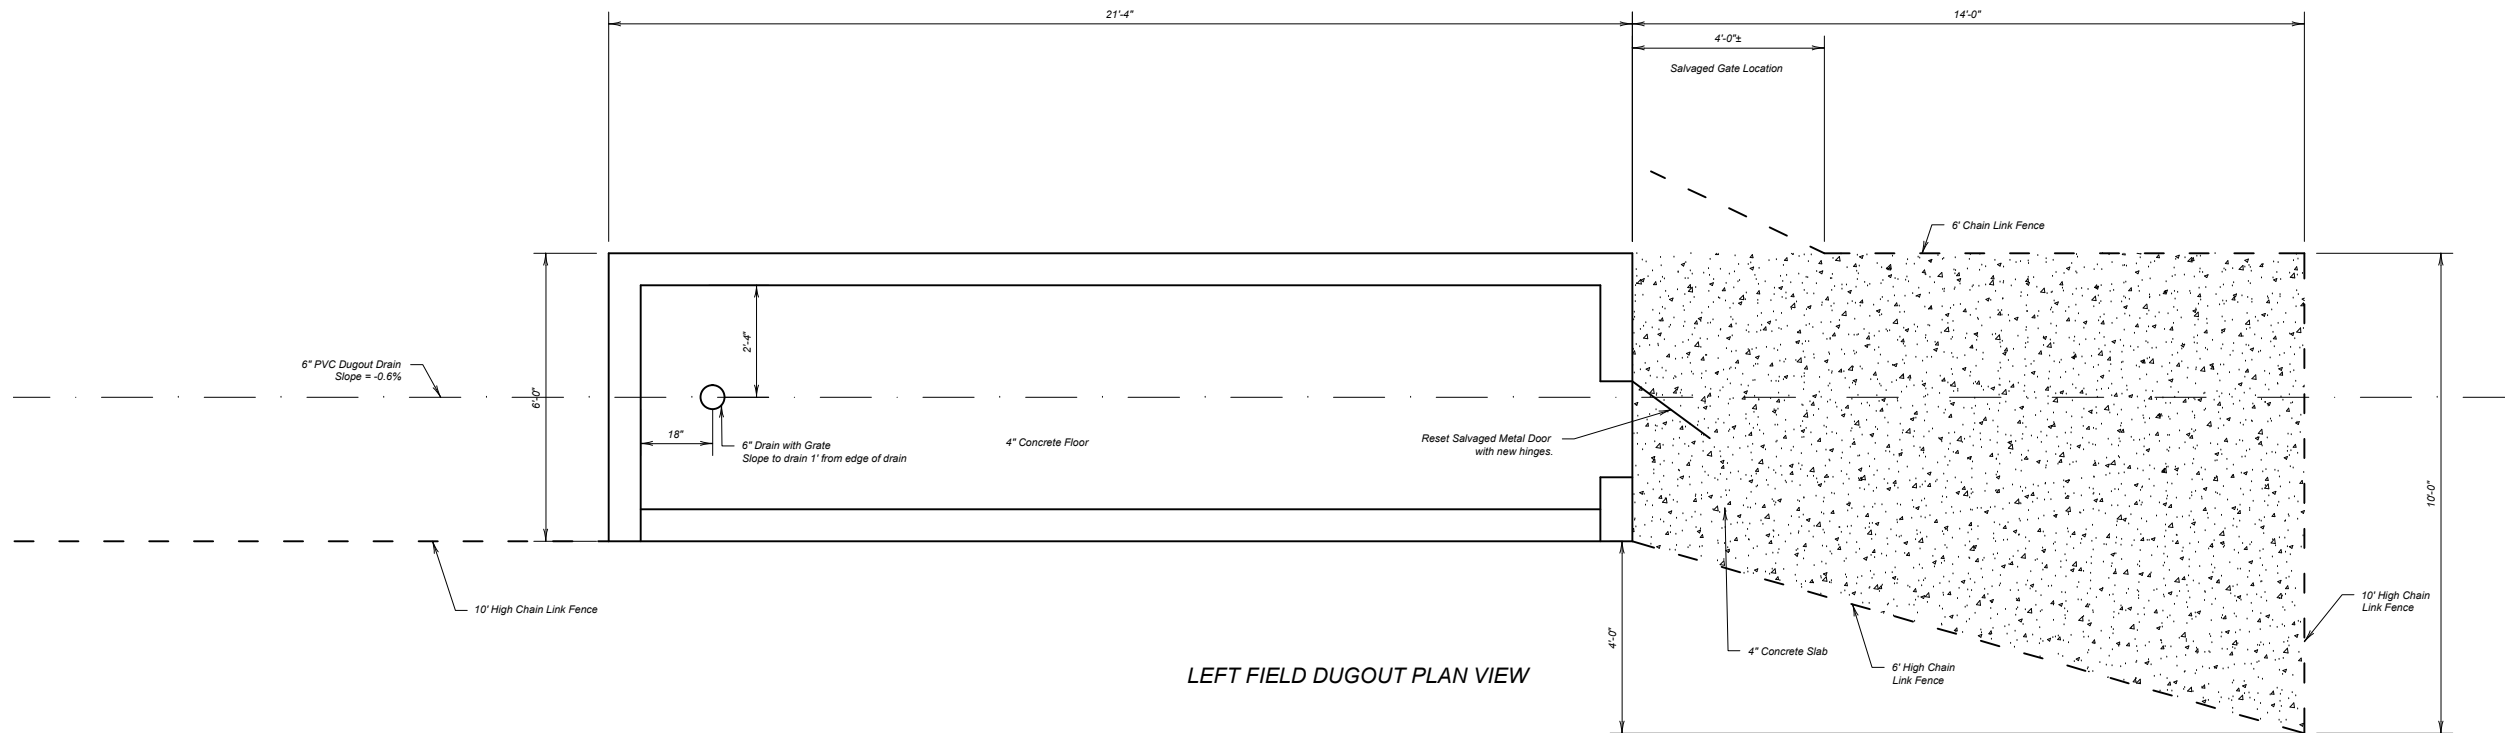

RIGHT FIELD DUGOUT PLAN VIEW


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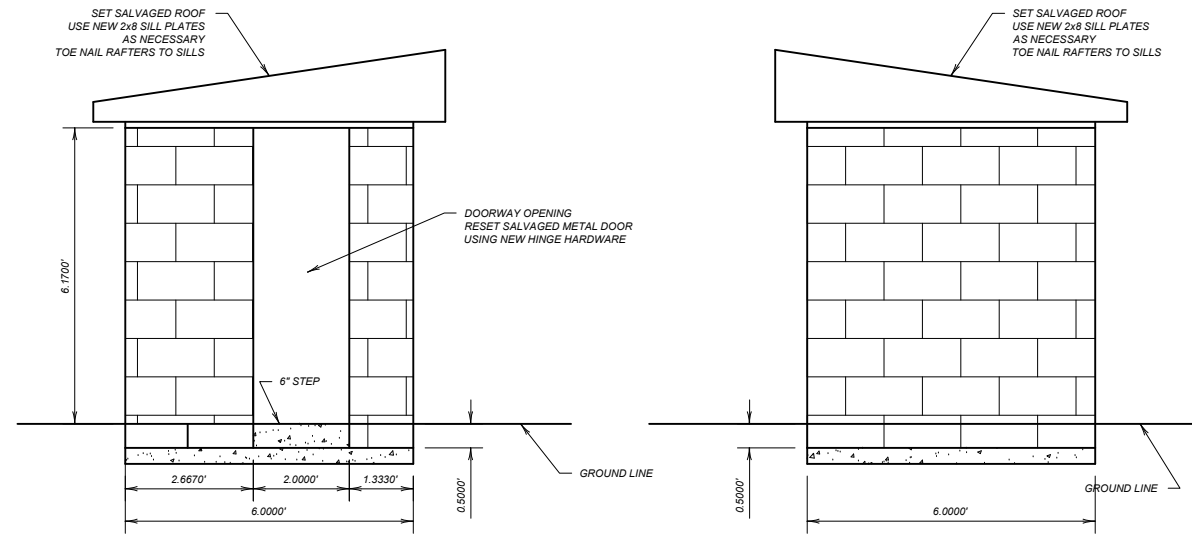
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CANYON LAKE LITTLE LEAGUE
 MAJORS FIELD FENCE RELOCATION

Sheet Title:
 DUGOUT
 PLAN




RIGHT FIELD DUGOUT ELEVATION VIEW

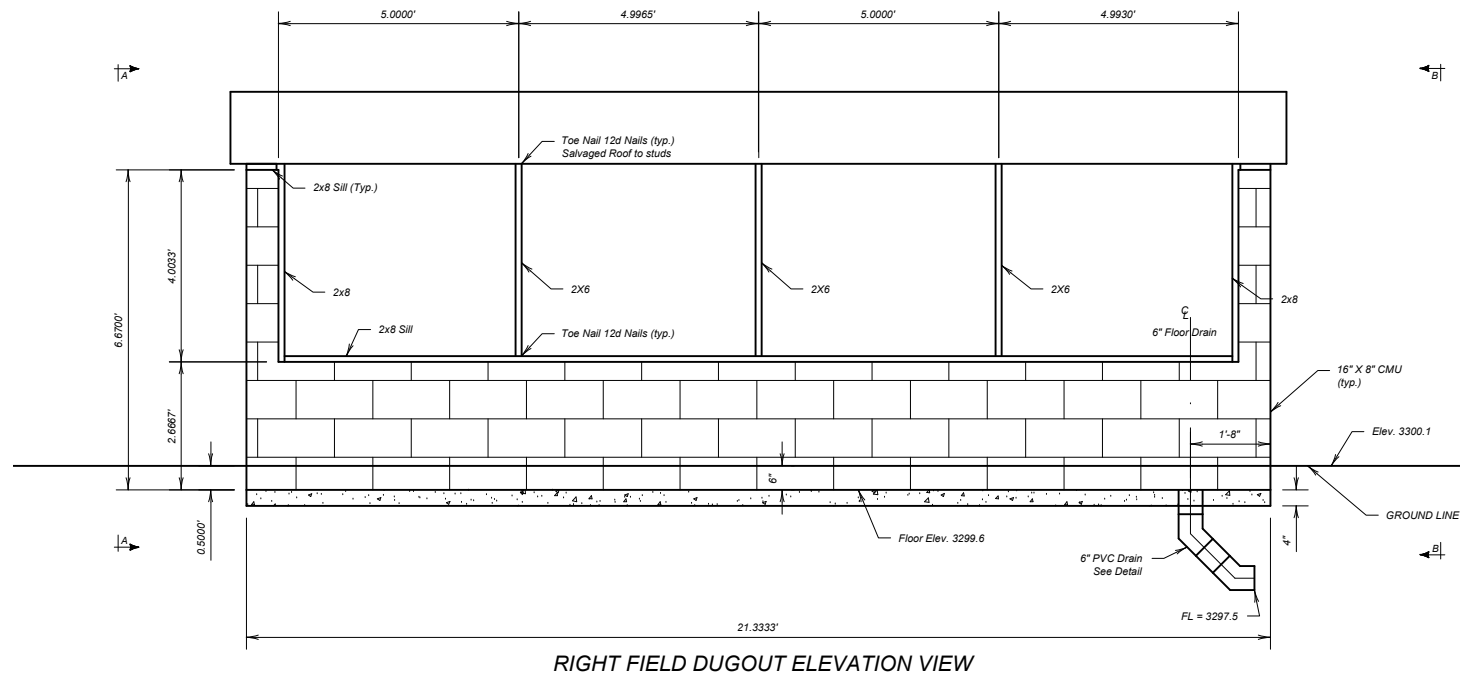


VIEW A-A

VIEW B-B

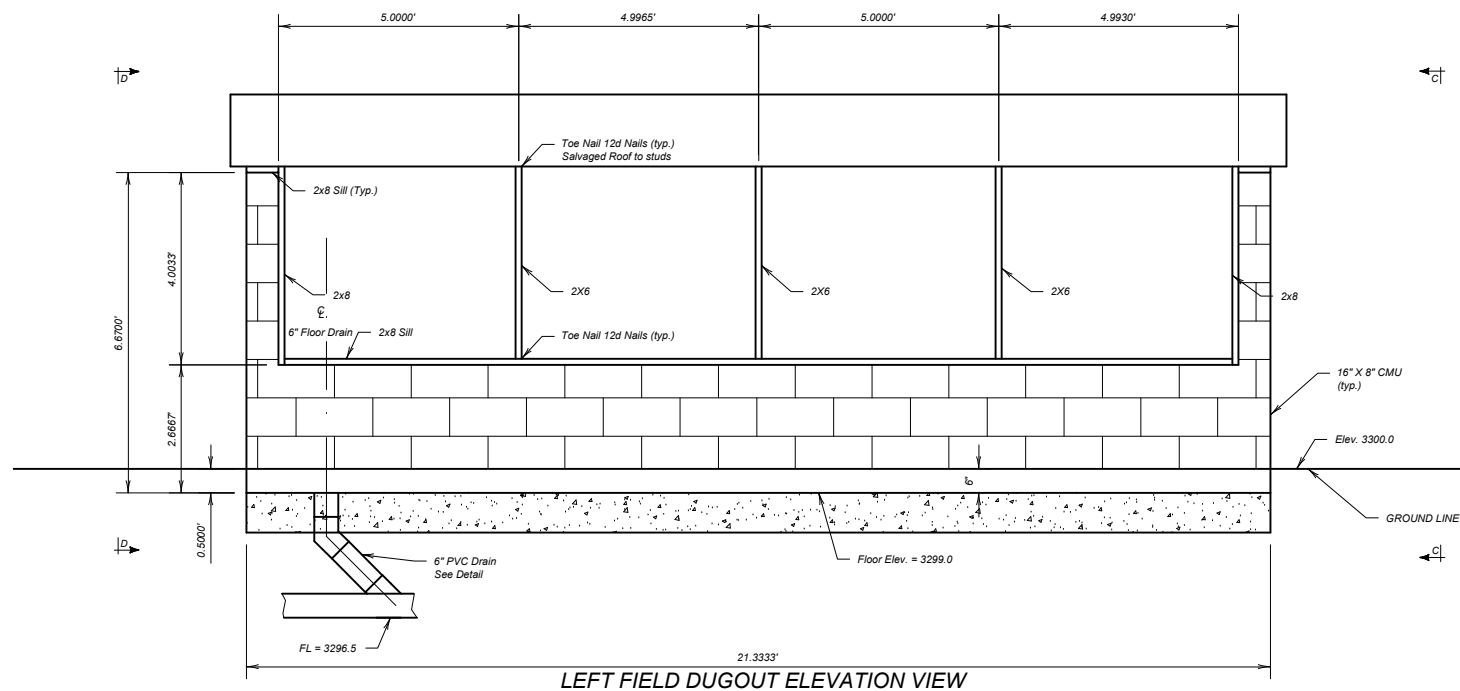

LEFT FIELD DUGOUT ELEVATION VIEW

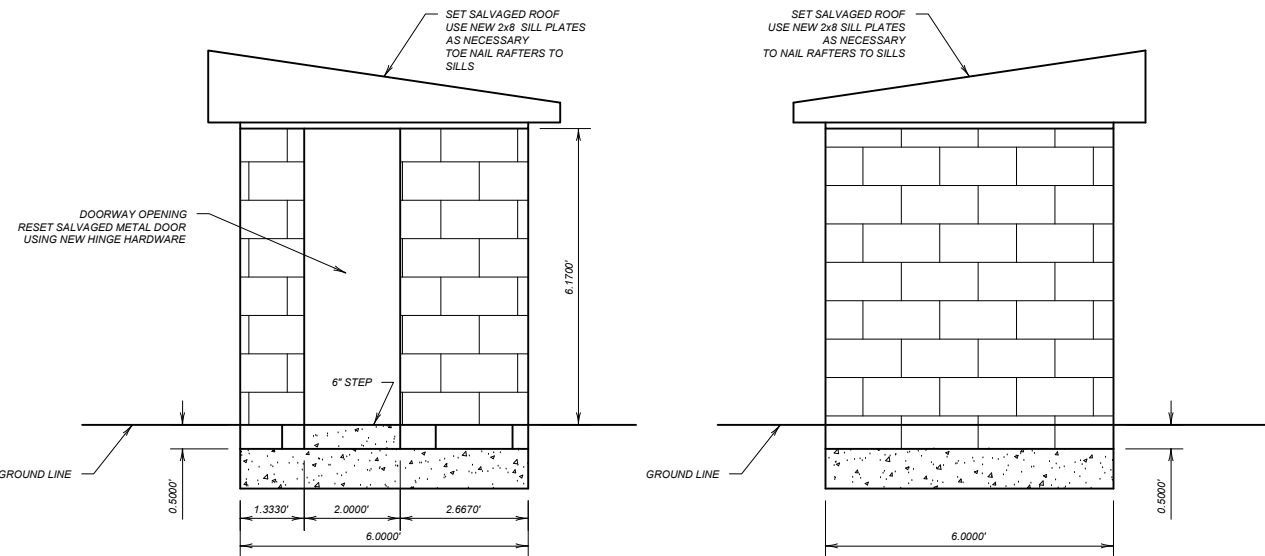

VIEW C-C


VIEW D-D

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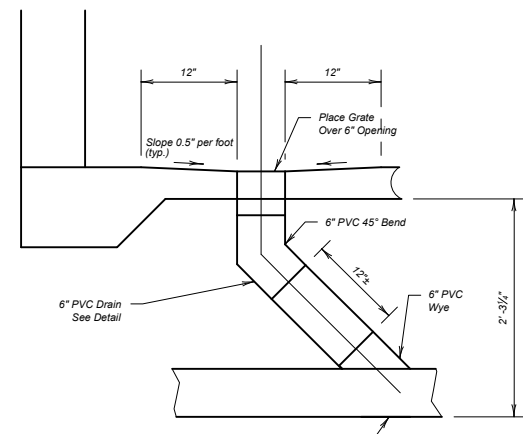
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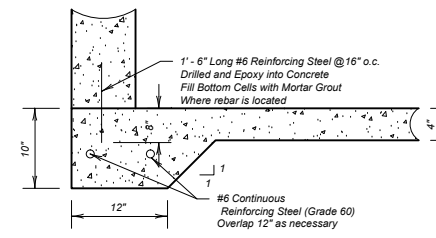
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 DUGOUT ELEVATIONS



RIGHT FIELD DUGOUT DRAIN

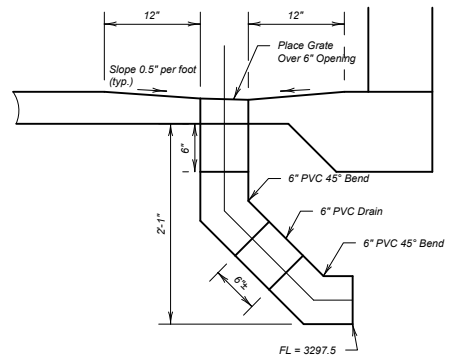

LEFT FIELD DUGOUT DRAIN



DUGOUT FOOTING DETAIL

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Sheet Title:
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